



NOTES:

GENERAL NOTES:
 1. These plans are drawn as required for construction by an experienced licensed general contractor.
 2. The General contractor shall fully comply with the 9TH Edition of the Massachusetts State Building Code, IRC2015 and all additional local requirements.
 3. Written dimensions shall have precedence over scaled dimensions. The general contractor shall verify and is responsible for all dimensions (including rough openings) and conditions on the job and must notify this office of any variations from these drawings. Any defects in the construction documents shall be brought to the attention of this office before proceeding with work. Reasonable time not allowed this office to correct defects shall place the burden of cost and liability from such defects upon the contractor.

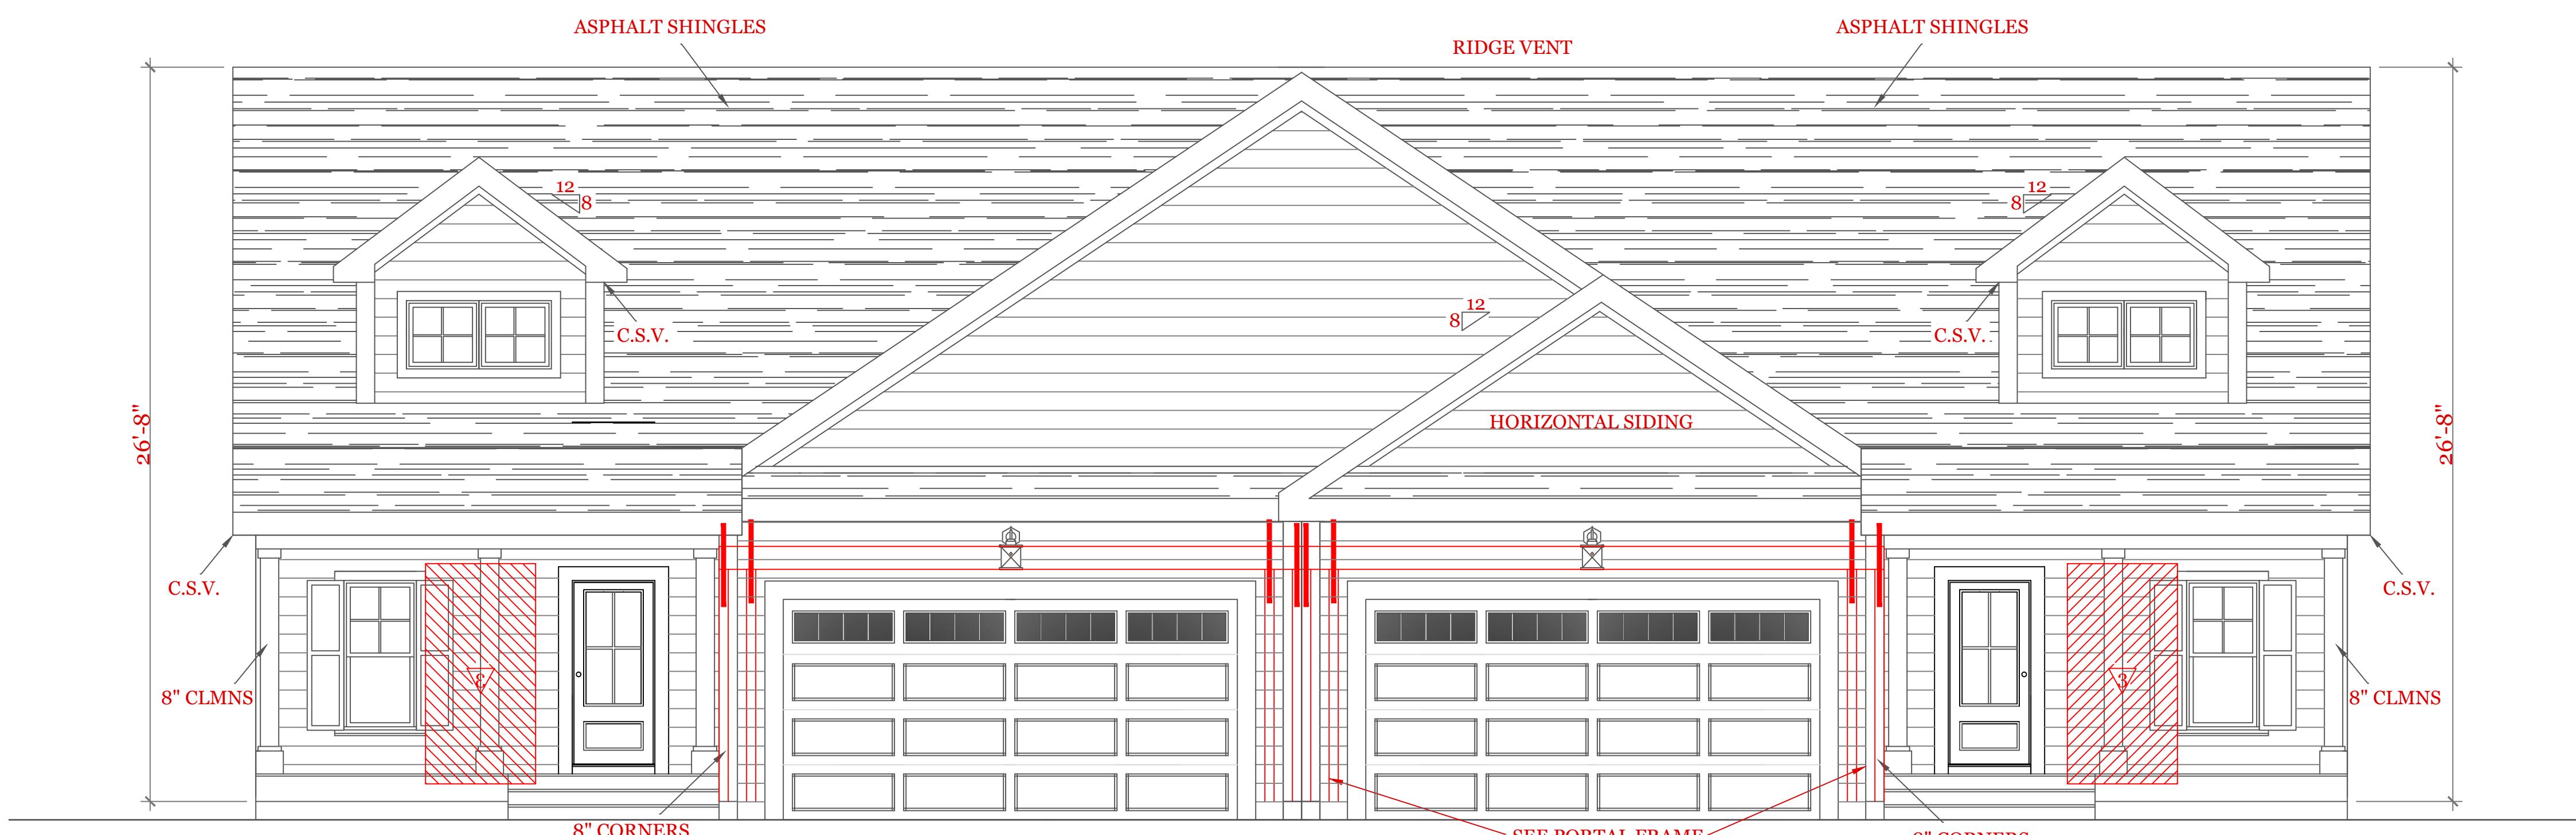

FRONT ELEVATION (1799 s.f.)

WOOD STRUCTURAL PANEL 15/32 CDX PLY WD, SHEATHING ON 16"
 STUD SPACING PANELS INSTALLED VERTICALLY
 W/ 6d COMMON NAIL 6" O.C. @ EDGES & 12" O.C. INTERMEDIATE
 SUPPORTS

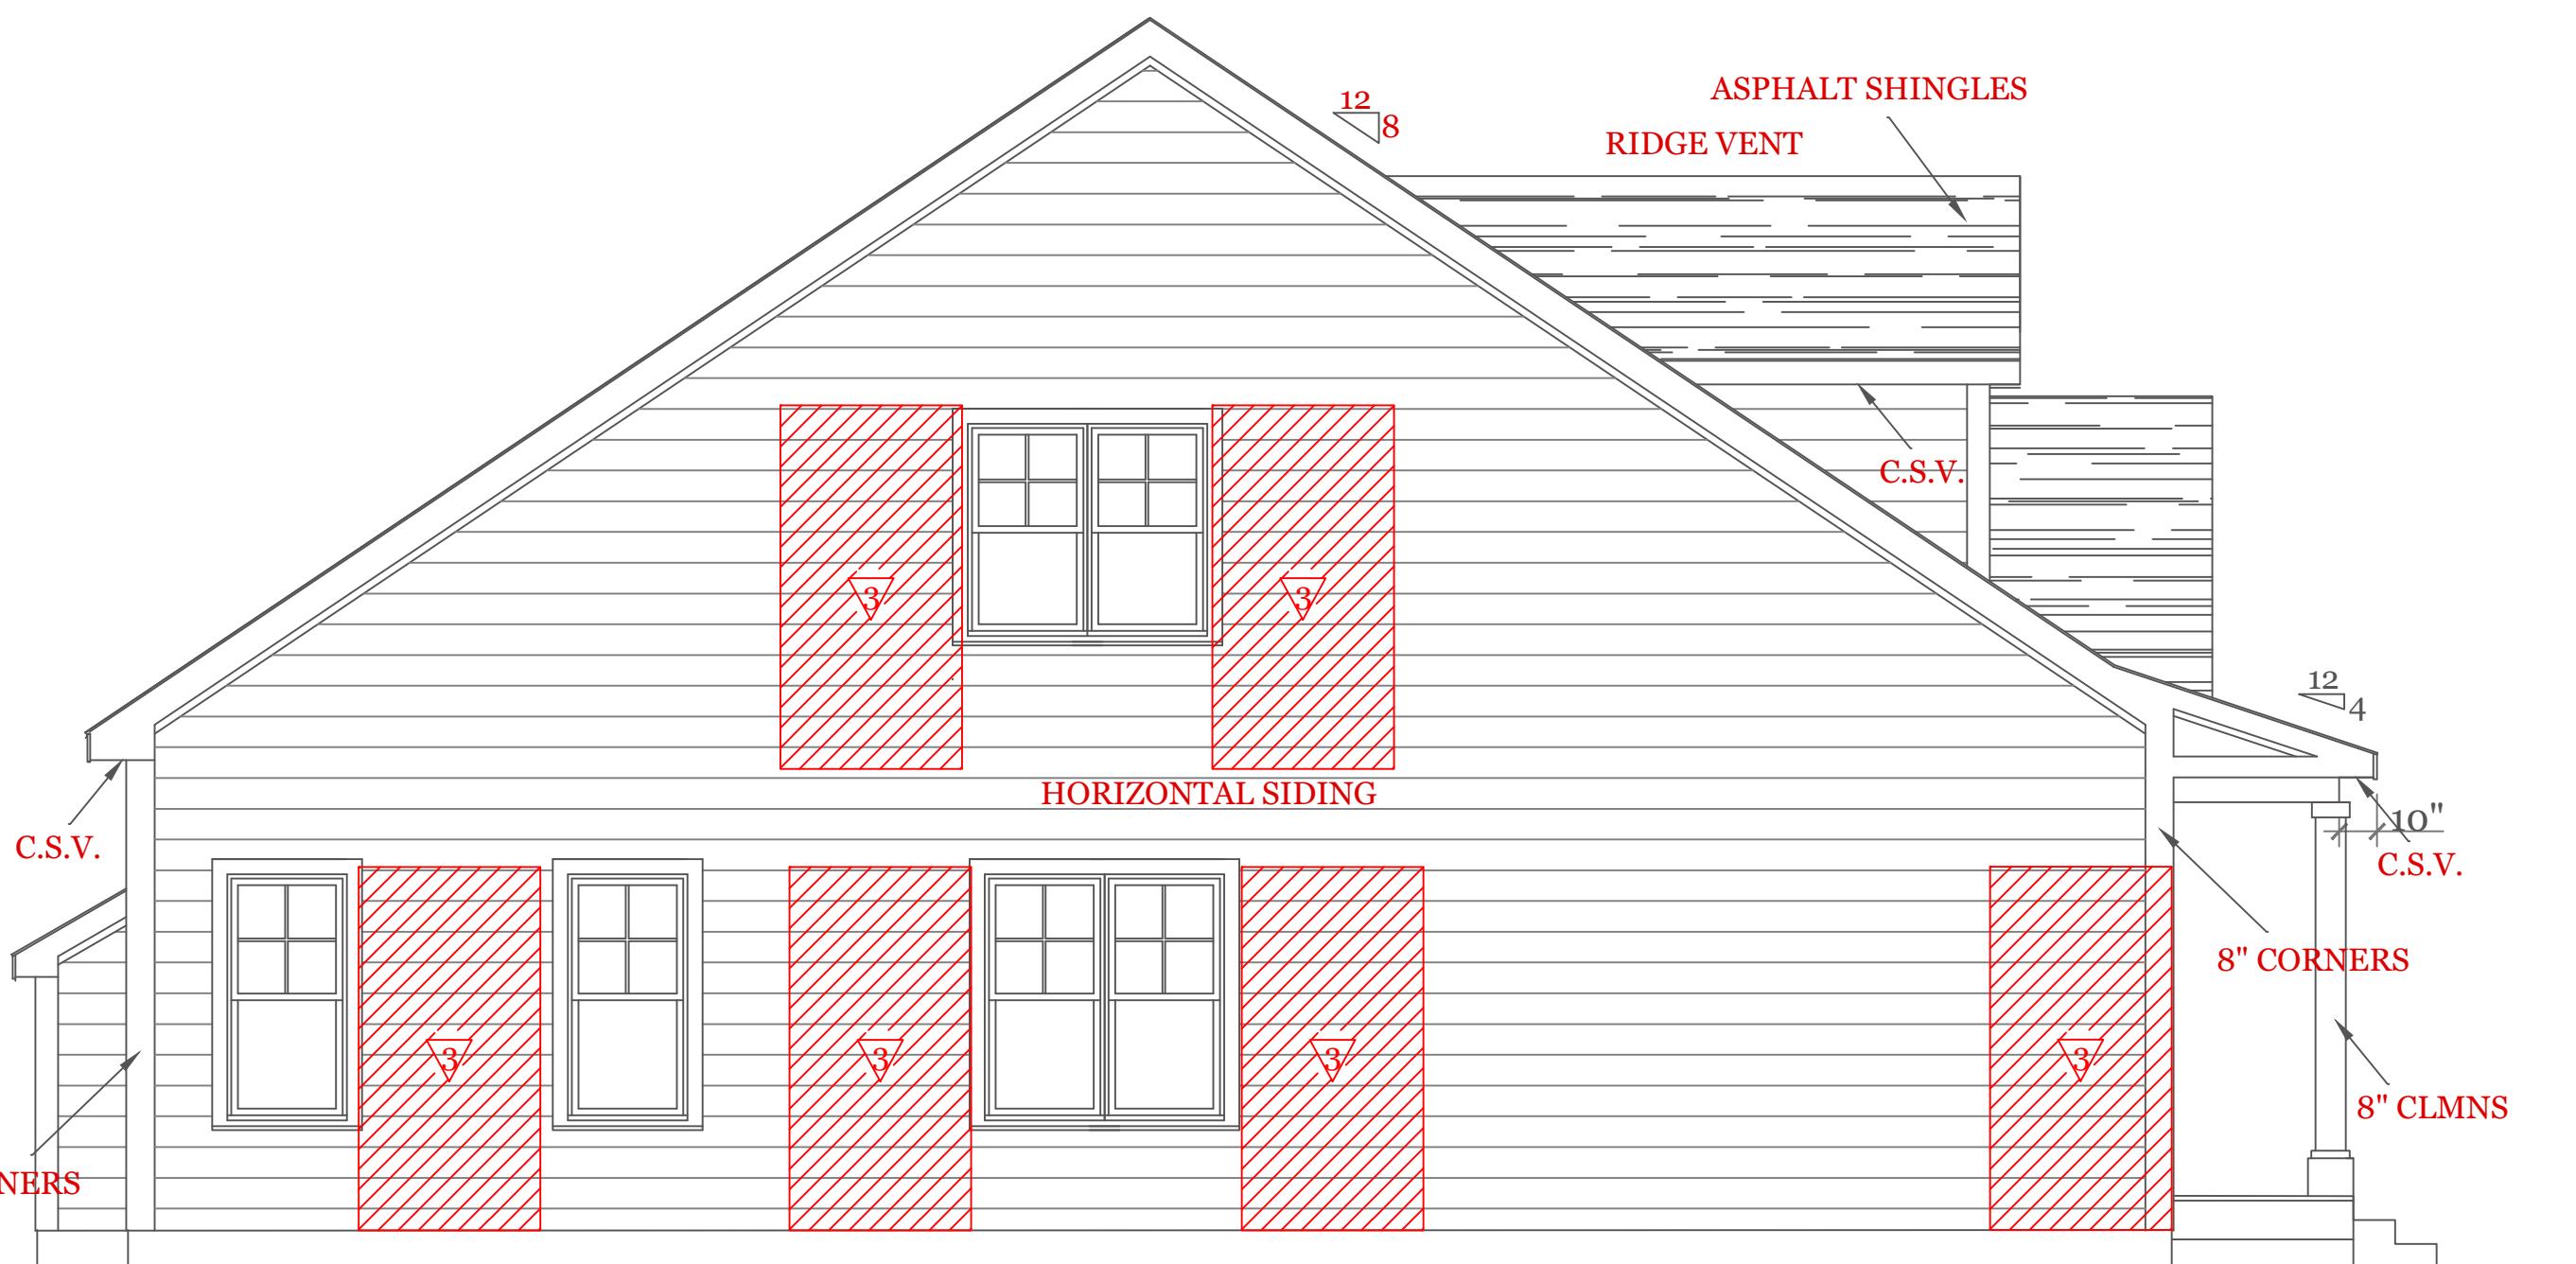

LEFT SIDE ELEVATION

TABLE 402.1.2
INSULATION AND FENESTRATION REQUIREMENTS BY COMPONENT^a

CLIMATE ZONE	FENESTRATION U-FACTOR ^b	SKYLIGHT ^b U-FACTOR	GLAZED FENESTRATION SHGC ^{c,e}	CEILING R-VALUE	WOOD FRAME WALL R-VALUE	MASS WALL R-VALUE ^f	FLOOR R-VALUE	BASEMENT ^c WALL R-VALUE	SLAB ^d R-VALUE & DEPTH	CRAWL SPACE ^c WALL R-VALUE
5 and Marine 4	0.30	0.55	NR	49	20 or 13+5 ^h	13/17	30g	15/19	10, 2 ft	15/19

2018 INTERNATIONAL ENERGY CONSERVATION CODE® AND MASSACHUSETTES 780 CMR 9TH EDITION

For SI: 1 foot = 304.8 mm.
 a. R-values are minimums. U-factors and SHGC are maximums. R-19 batts compressed into a nominal 2 x 6 framing cavity such that the R-value is reduced by R-1 or more shall be marked with the compressed batt R-value in addition to the full thickness R-value.
 b. The fenestration U-factor column applies to all glazed fenestration.
 c. "15/19" means R-15 continuous insulated sheathing on the interior of the basement wall plus R-5 continuous insulated sheathing on the exterior of the home. "10/13" means R-10 continuous insulated sheathing on the interior or exterior of the home or R-13 cavity insulation at the interior of the basement wall.
 d. R-5 shall be added to the required slab edge R-values for heated slabs. Insulation depth shall be the depth of the footing or 2 feet, whichever is less in Zones 1 through 3 for heated slabs.
 e. There are no SHGC requirements in the Marine Zone.
 f. Basement wall insulation is not required in warm-humid locations as defined by Figure 301.1 and Table 301.1.
 g. Or insulation sufficient to fill the framing cavity, R-19 minimum.
 h. "13+5" means R-13 cavity insulation plus R-5 insulated sheathing. If structural sheathing covers 25 percent or less of the exterior, insulating sheathing is not required where structural sheathing is used. If structural sheathing covers more than 25 percent of exterior, structural sheathing shall be supplemented with insulated sheathing of at least R-2.
 i. The second R-value applies when more than half the insulation is on the interior of the mass wall.
 j. For impact rated fenestration complying with Section R301.21.2 of the International Residential Code or Section 1608.1.2 of the International Building Code, the maximum U-factor shall be 0.75 in Zone 2 and 0.65 in Zone 3.


DESIGN CRITERIA												
GROUND SNOW LOAD	WIND SPEED (MPH)	SEISMIC DESIGN	WEATHERING	FROST LINE DEPTH	TERMITE	DECAY	WINTER DESIGN TEMP	ICE SHIELD UNDERLAYMENT REQUIRED	FLOOD HAZARD	AIR FREEZING INDEX	MEAN ANNUAL TEMP	
TABLE 5301.2(5)	TABLE 5301.2(4)	N/A	FIGURE 5301.2(3)	.4 ft. minimum unless engineered data shows otherwise	FIGURE 5301.2(6)	FIGURE 5301.2(7)	APPENDIX 780 CMR 120.J TABLE 120.J.3-2.1	As required by the exterior roof covering manufacturer; roof pitch and local climate must also be considered	Refer to applicable Flood Insurance Rate Map (FIRM)	Only utilized in the design and construction of frost protected shallow foundations	Only utilized in the design and construction of frost protected shallow foundations	
50 psf	124 mph	N/A	SEVERE	\$5403.14	MODERATE TO HEAVY	SLIGHT TO MODERATE	N/A	\$5905.0	FIRM MAPS	SEE NOTE J TABLE 5301.2(1)	SEE NOTE K TABLE 5301.2(1)	

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UNIT 'A' - DUPLEX
HIGGINS FARM AT
SALISBURY HILL



FRONT & LEFT
ELEVATIONS
DESIGN CRITERIA

DATE: 9/20/2022 R5/5/23
SCALE: 1/4"=1'-0"
DRAWN BY: RCS
CHECKED BY: MJB
Sheet 1 OF 8

1
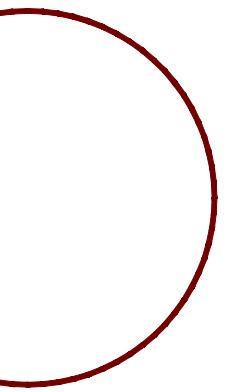
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UNIT 'A' - DUPLEX
HIGGINS FARM AT
SALISBURY HILL

REAR & LEFT
ELEVATIONS

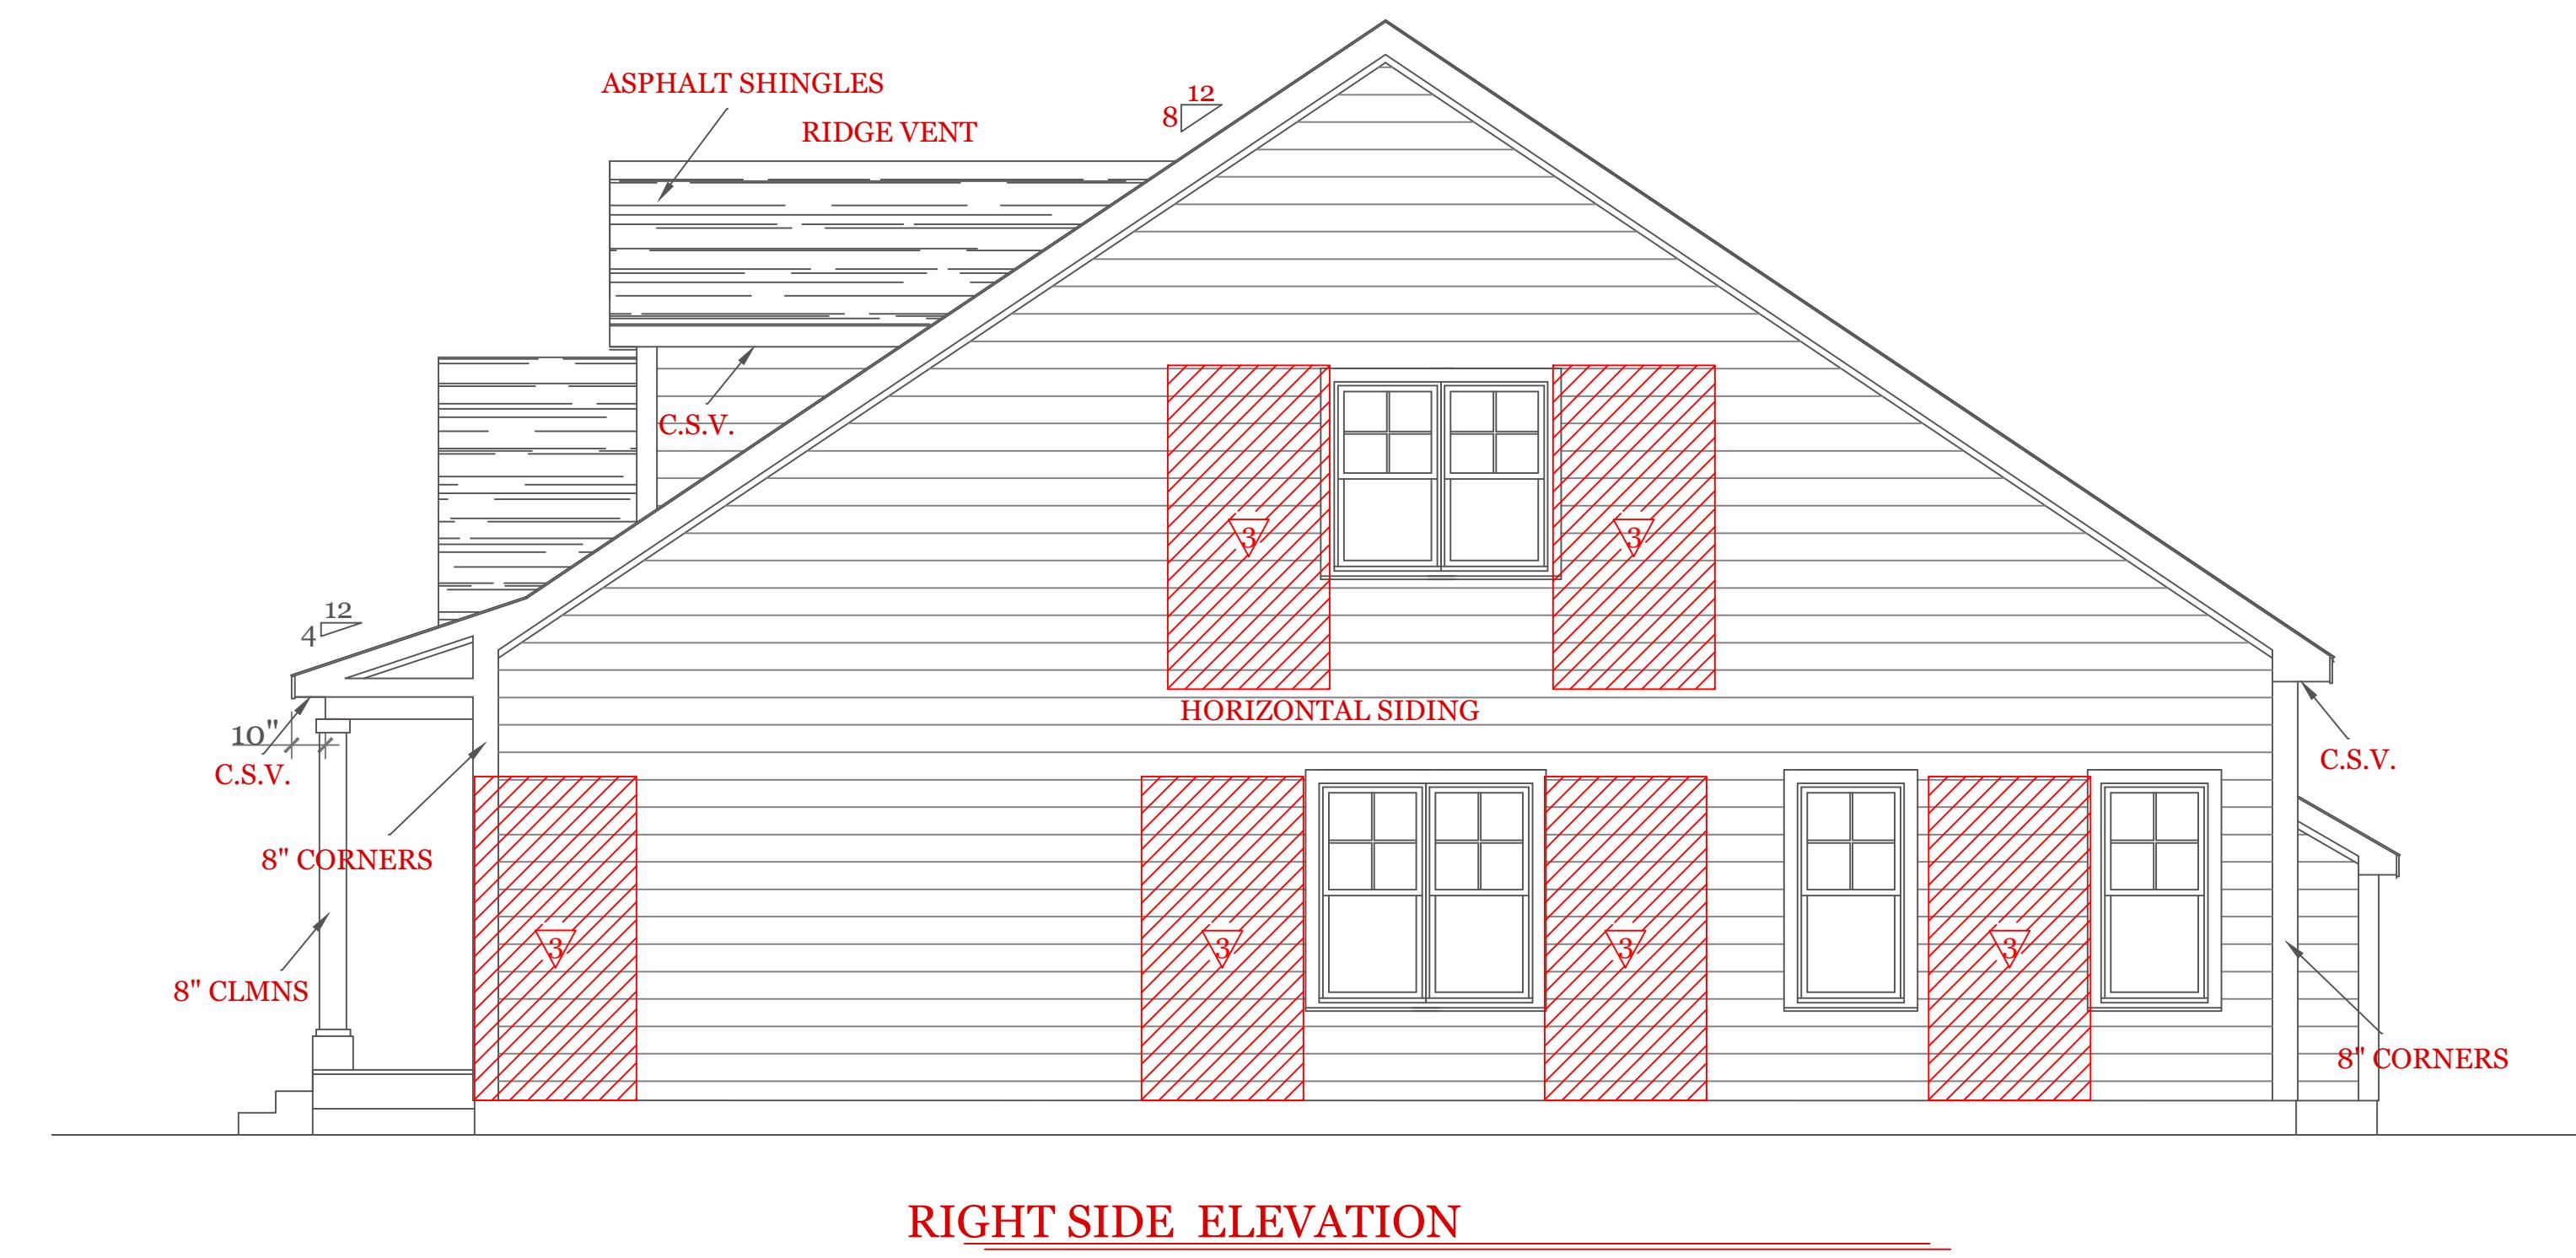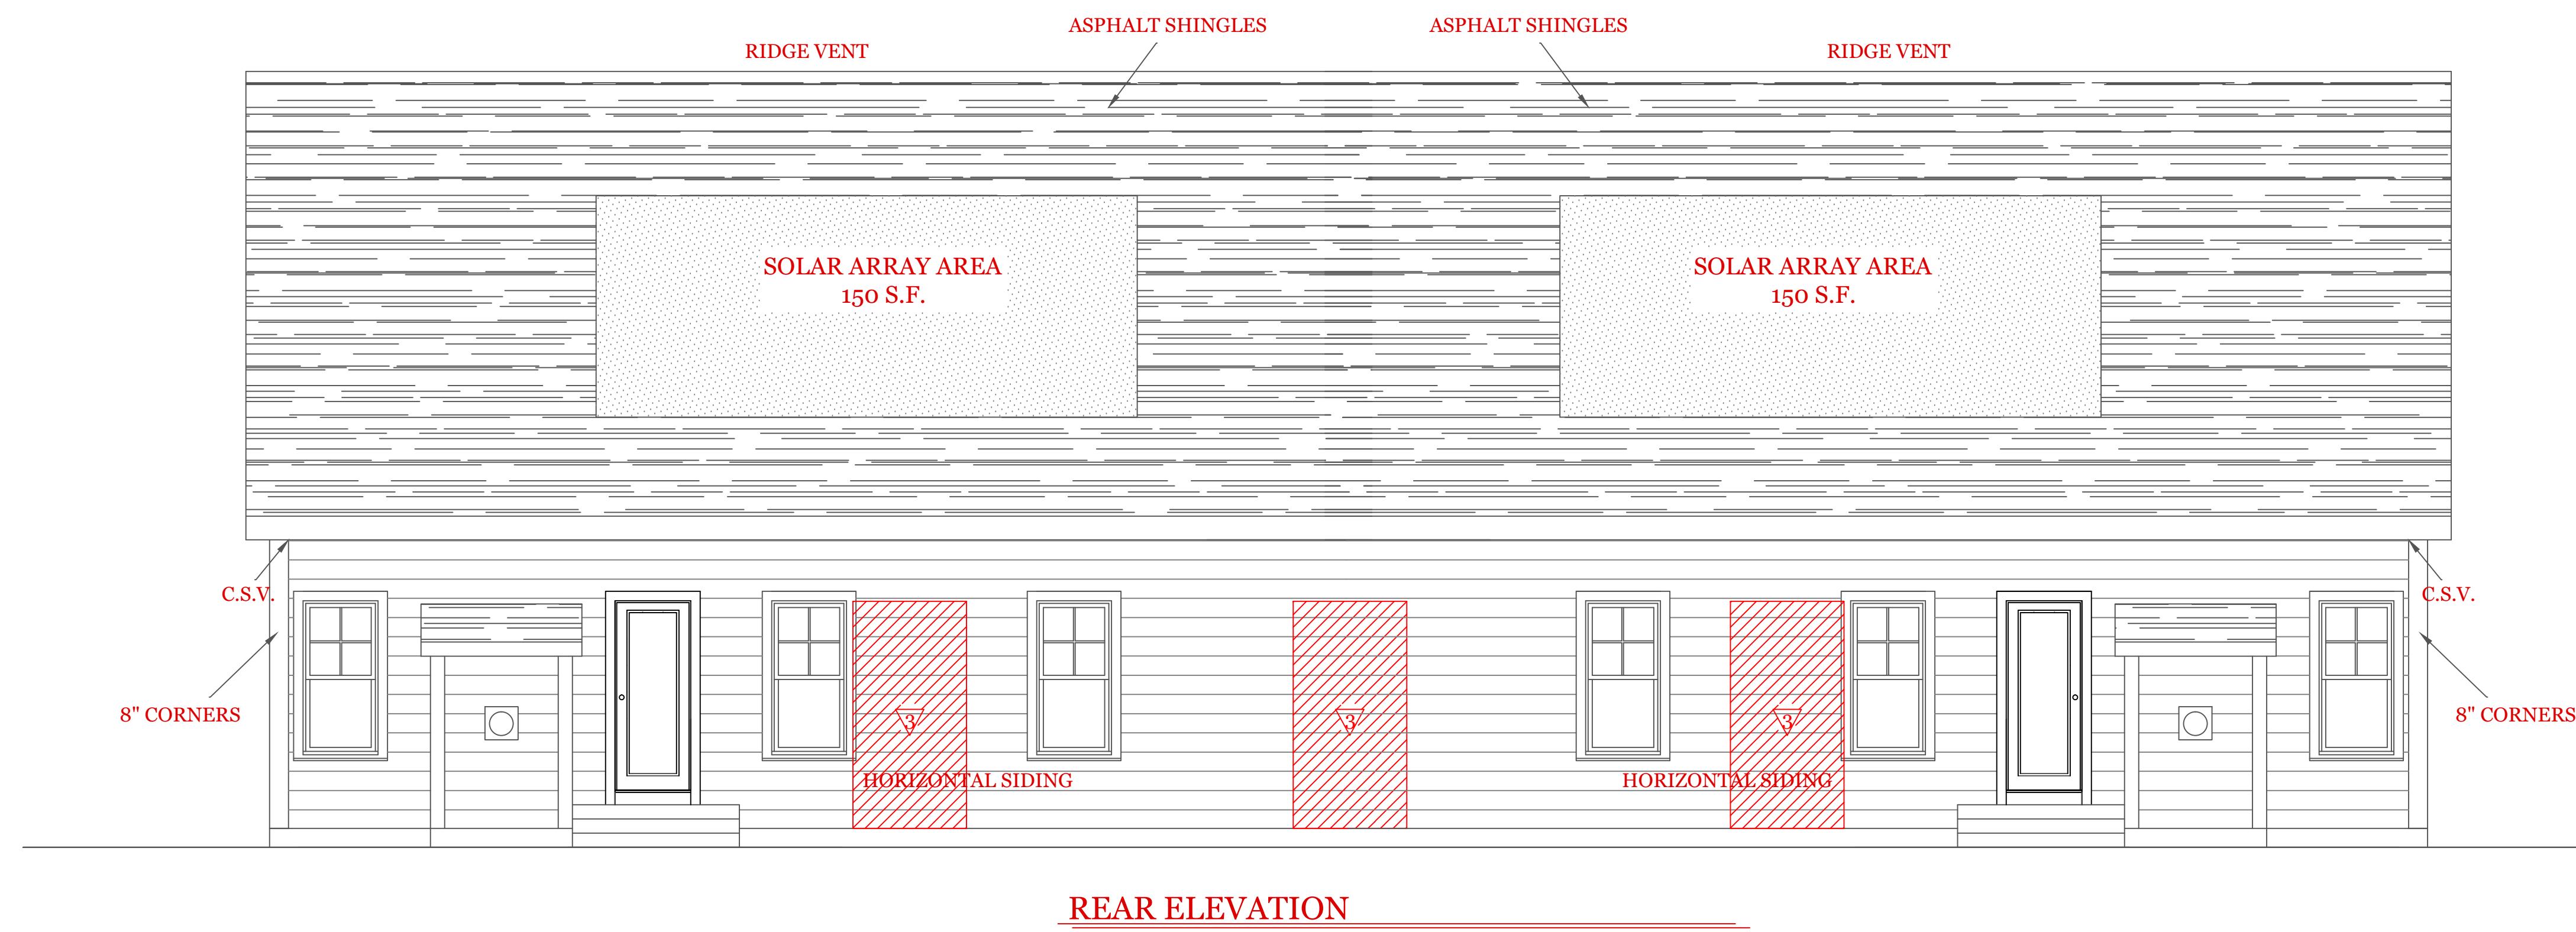UNIT 'A' DPLX

DATE: 9/20/2022 R5/5/23

SCALE: 1/4"=1'-0"


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CHECKED BY: MJB


Sheet 2 OF 8

2


TYPICAL FOUNDATION DETAILS

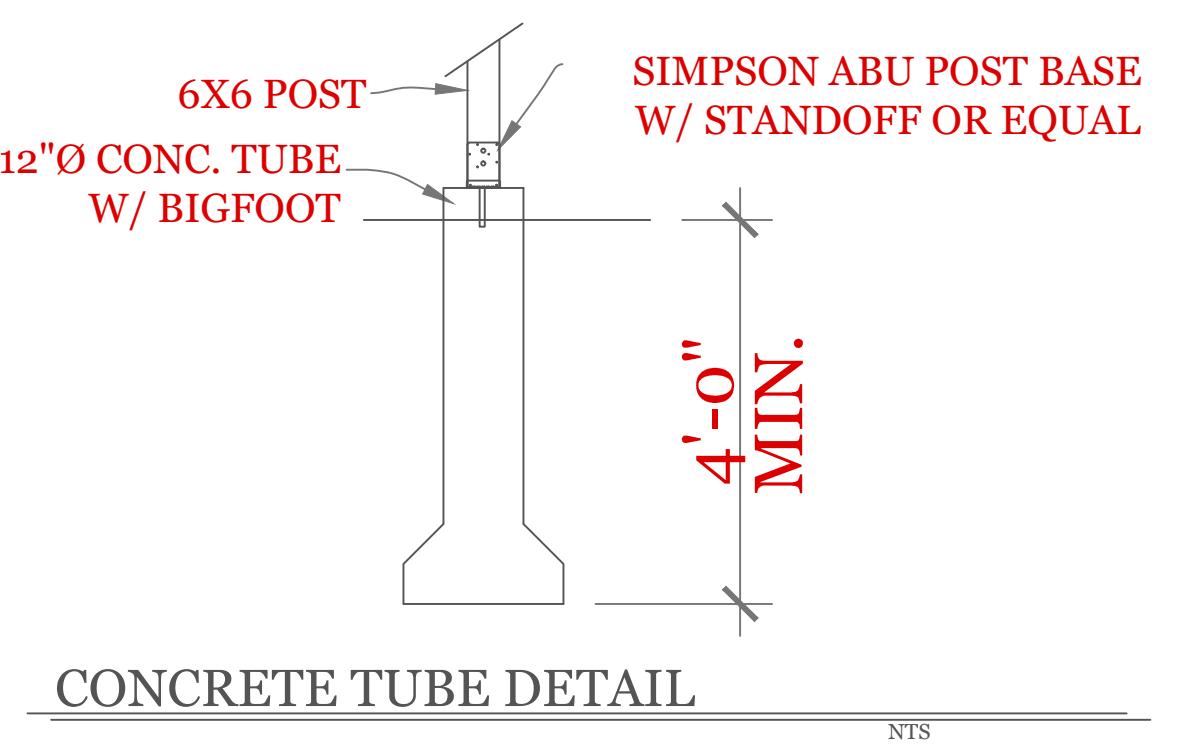

CONCRETE TUBE DETAIL

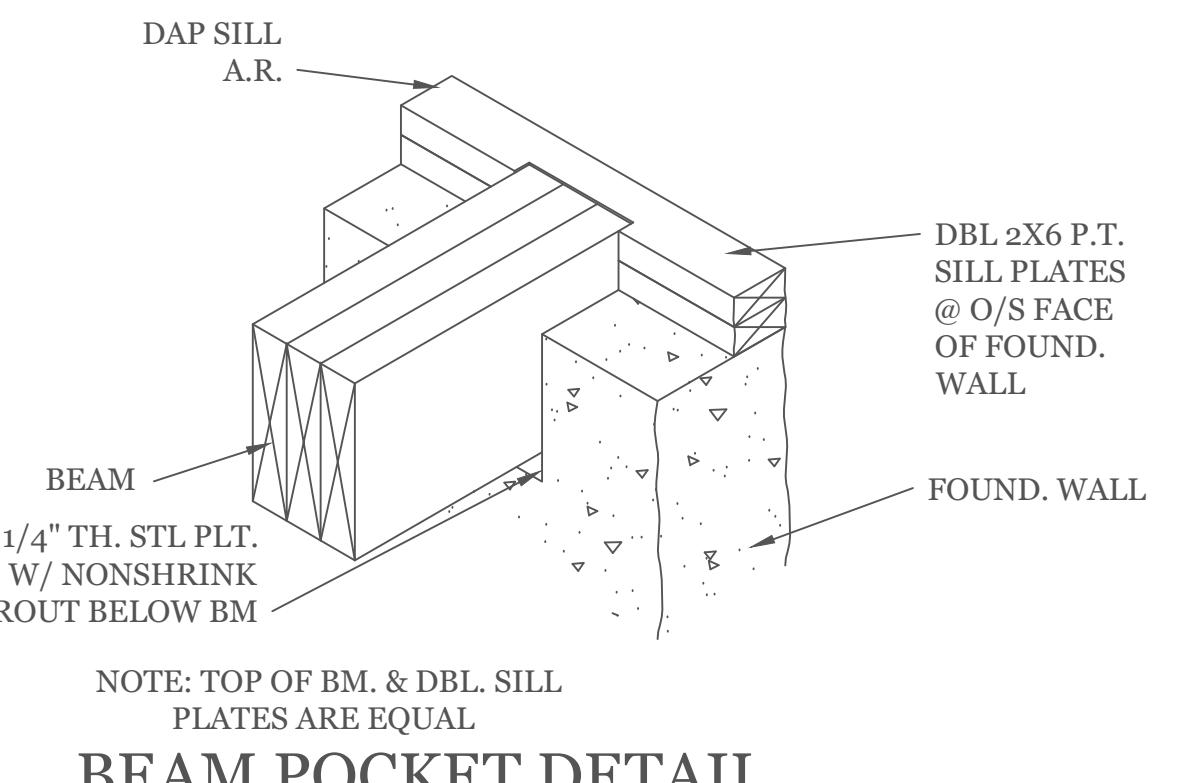


BEAM POCKET DETAIL

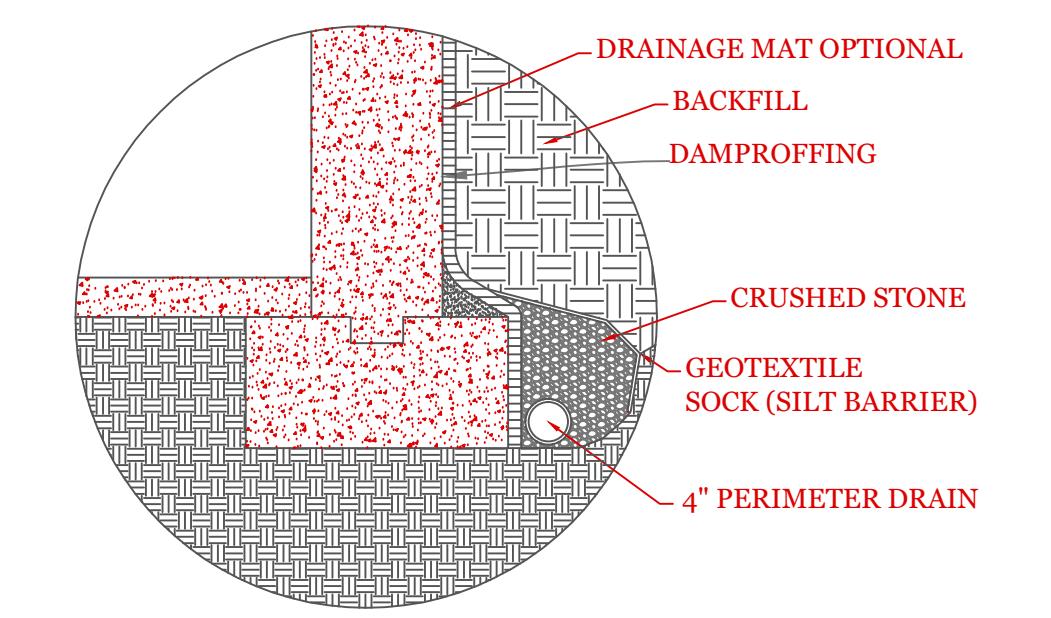




TYP. PERIMETER DRAIN DETAIL

NOTE: SLOPE DRAIN TO SUMP OR OUTfall

NTS

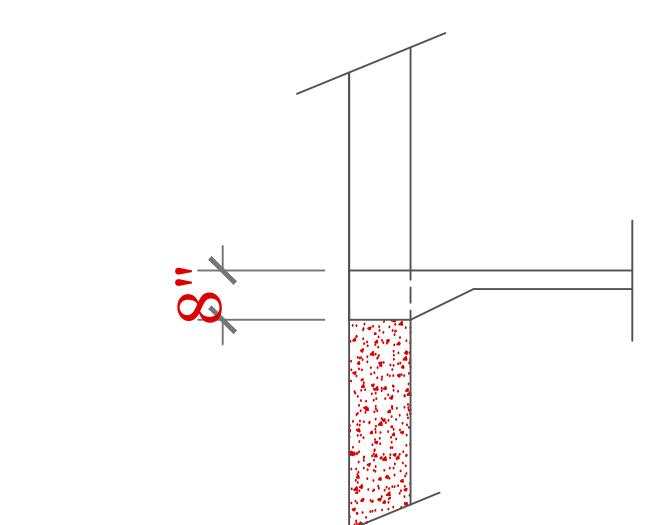

GARAGE FLOOR @ O.H.D.

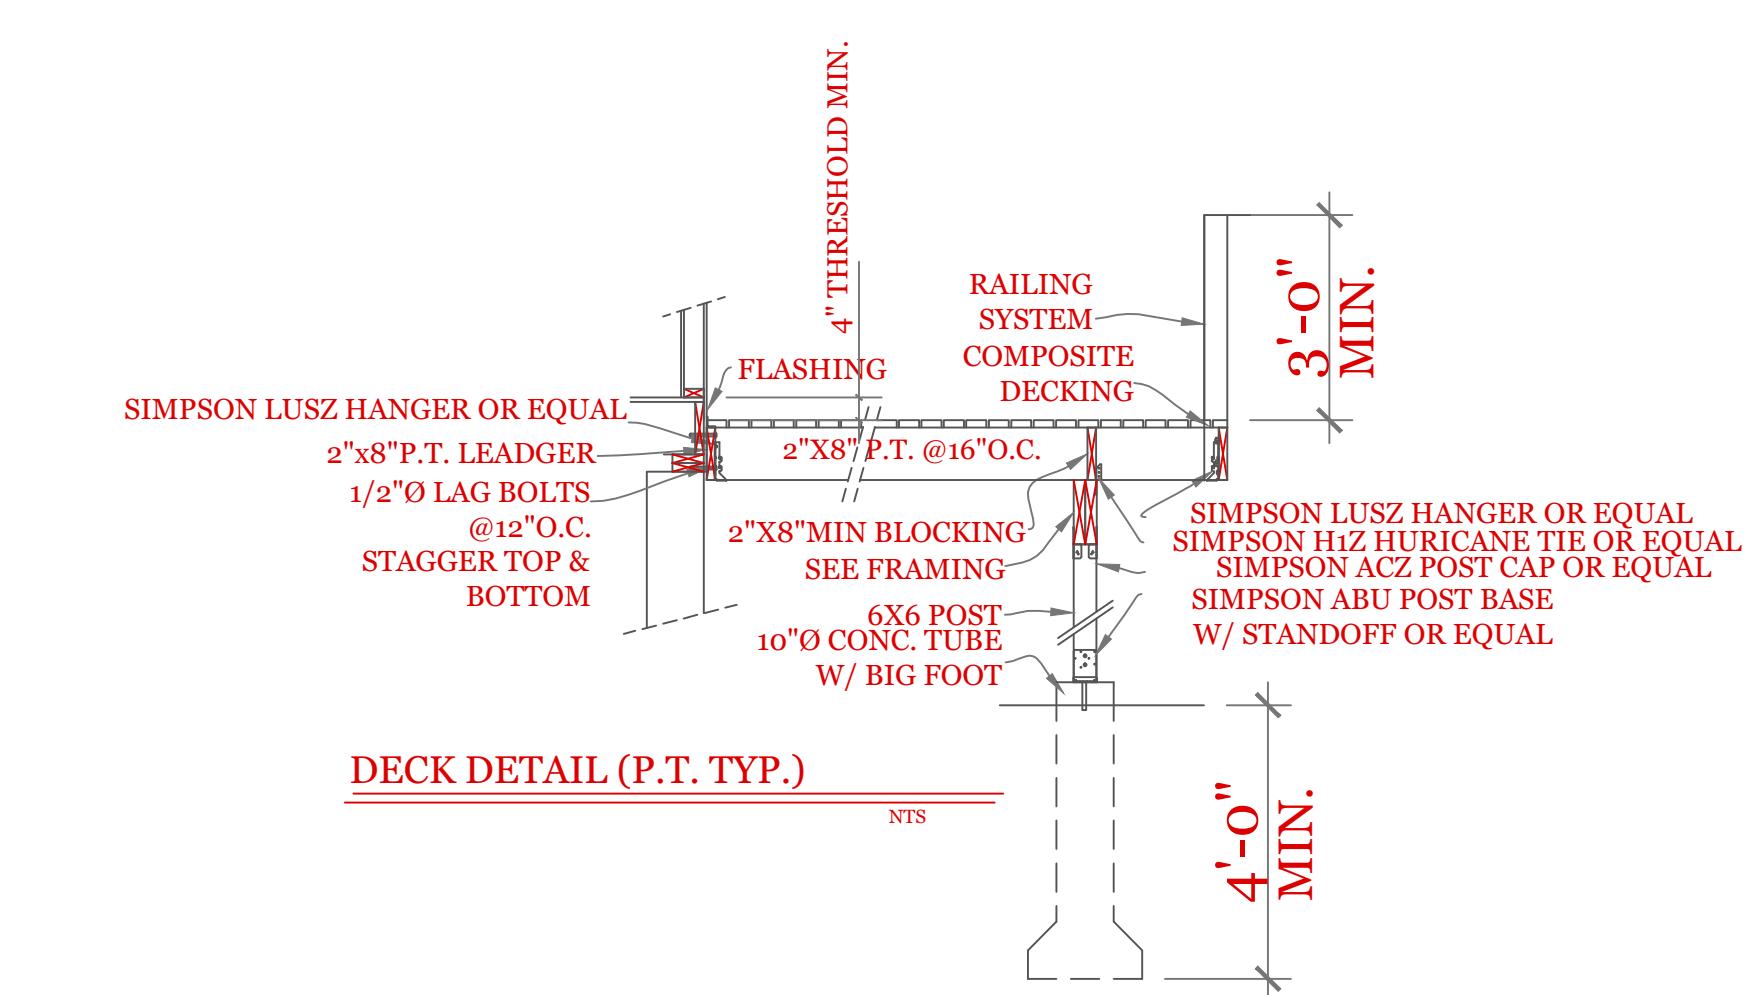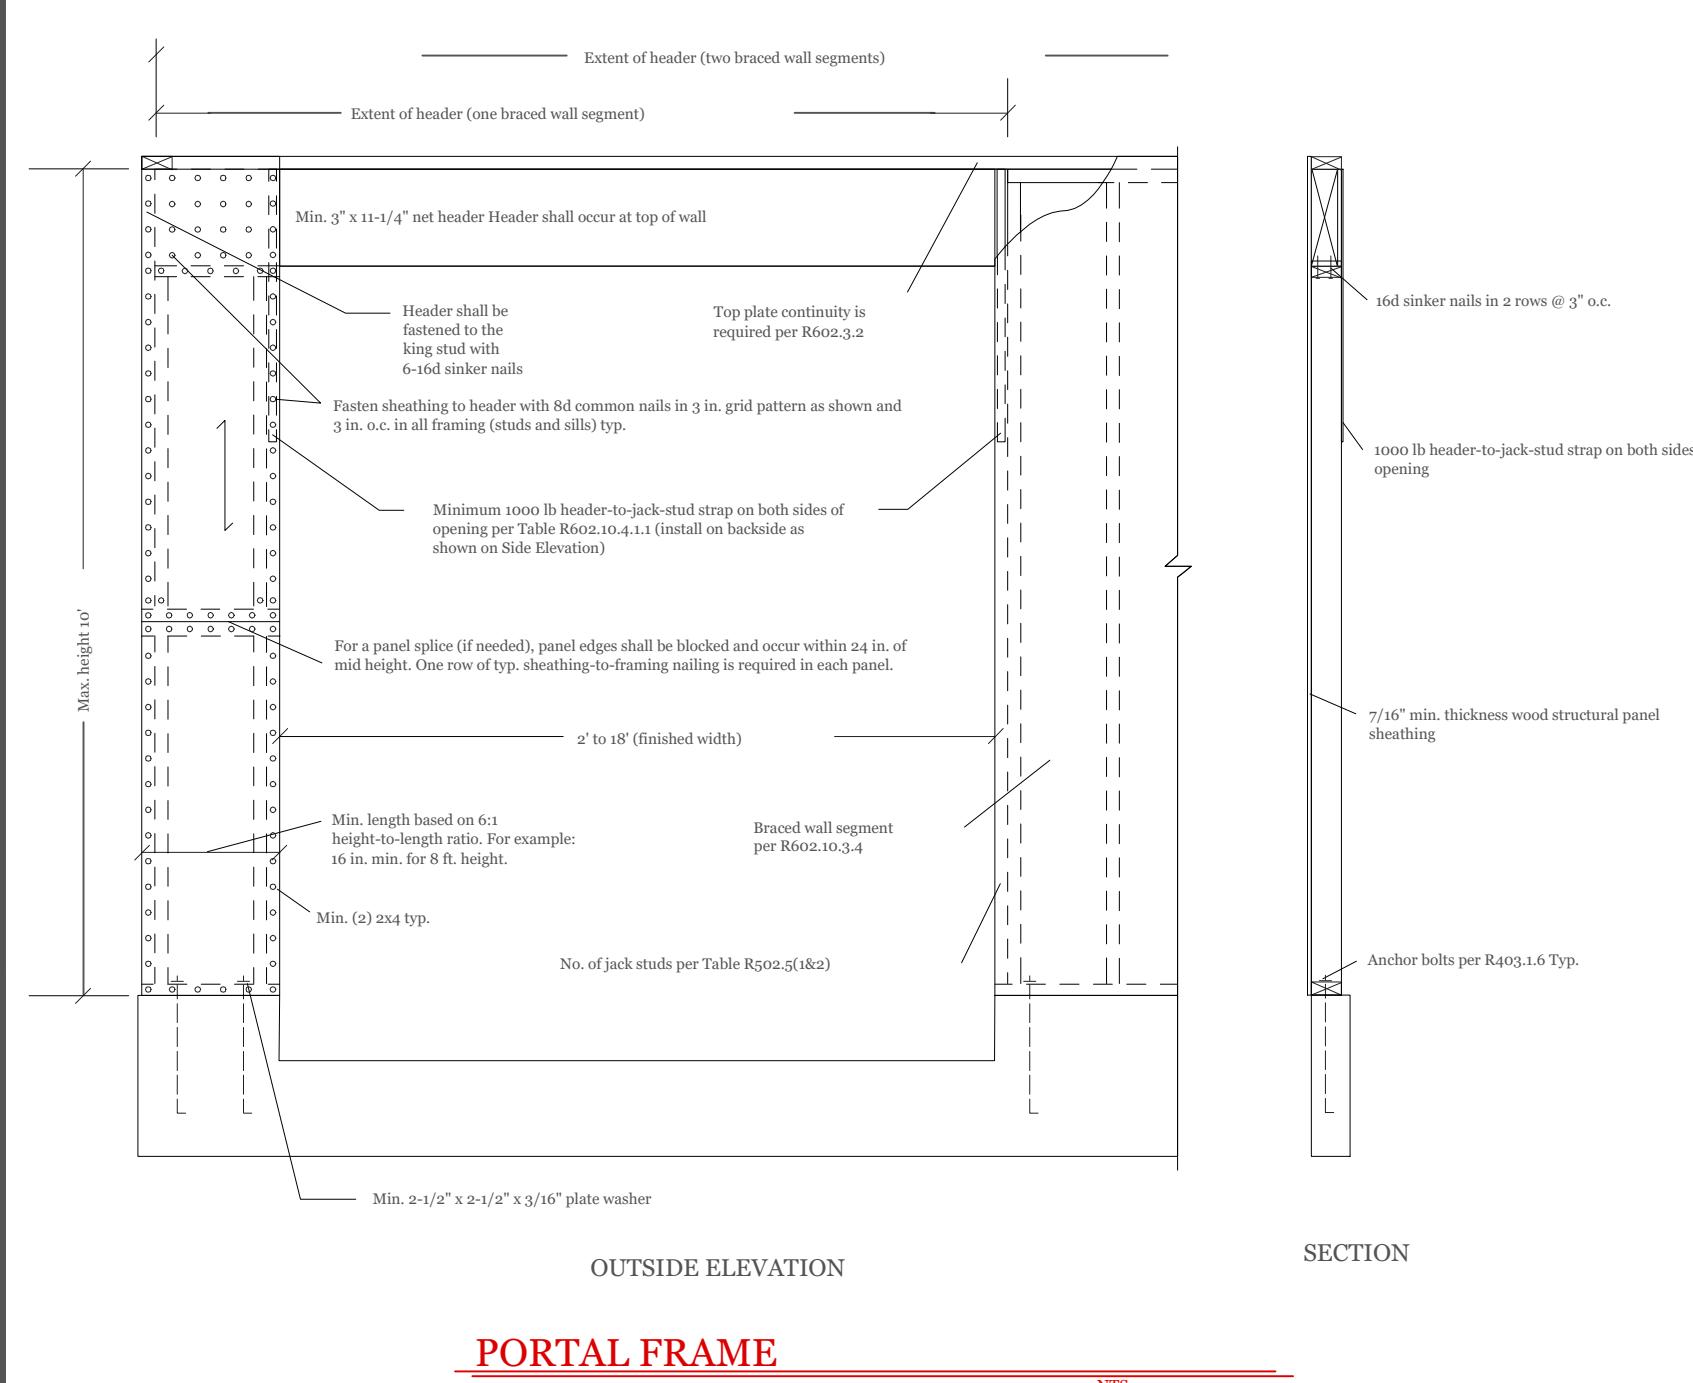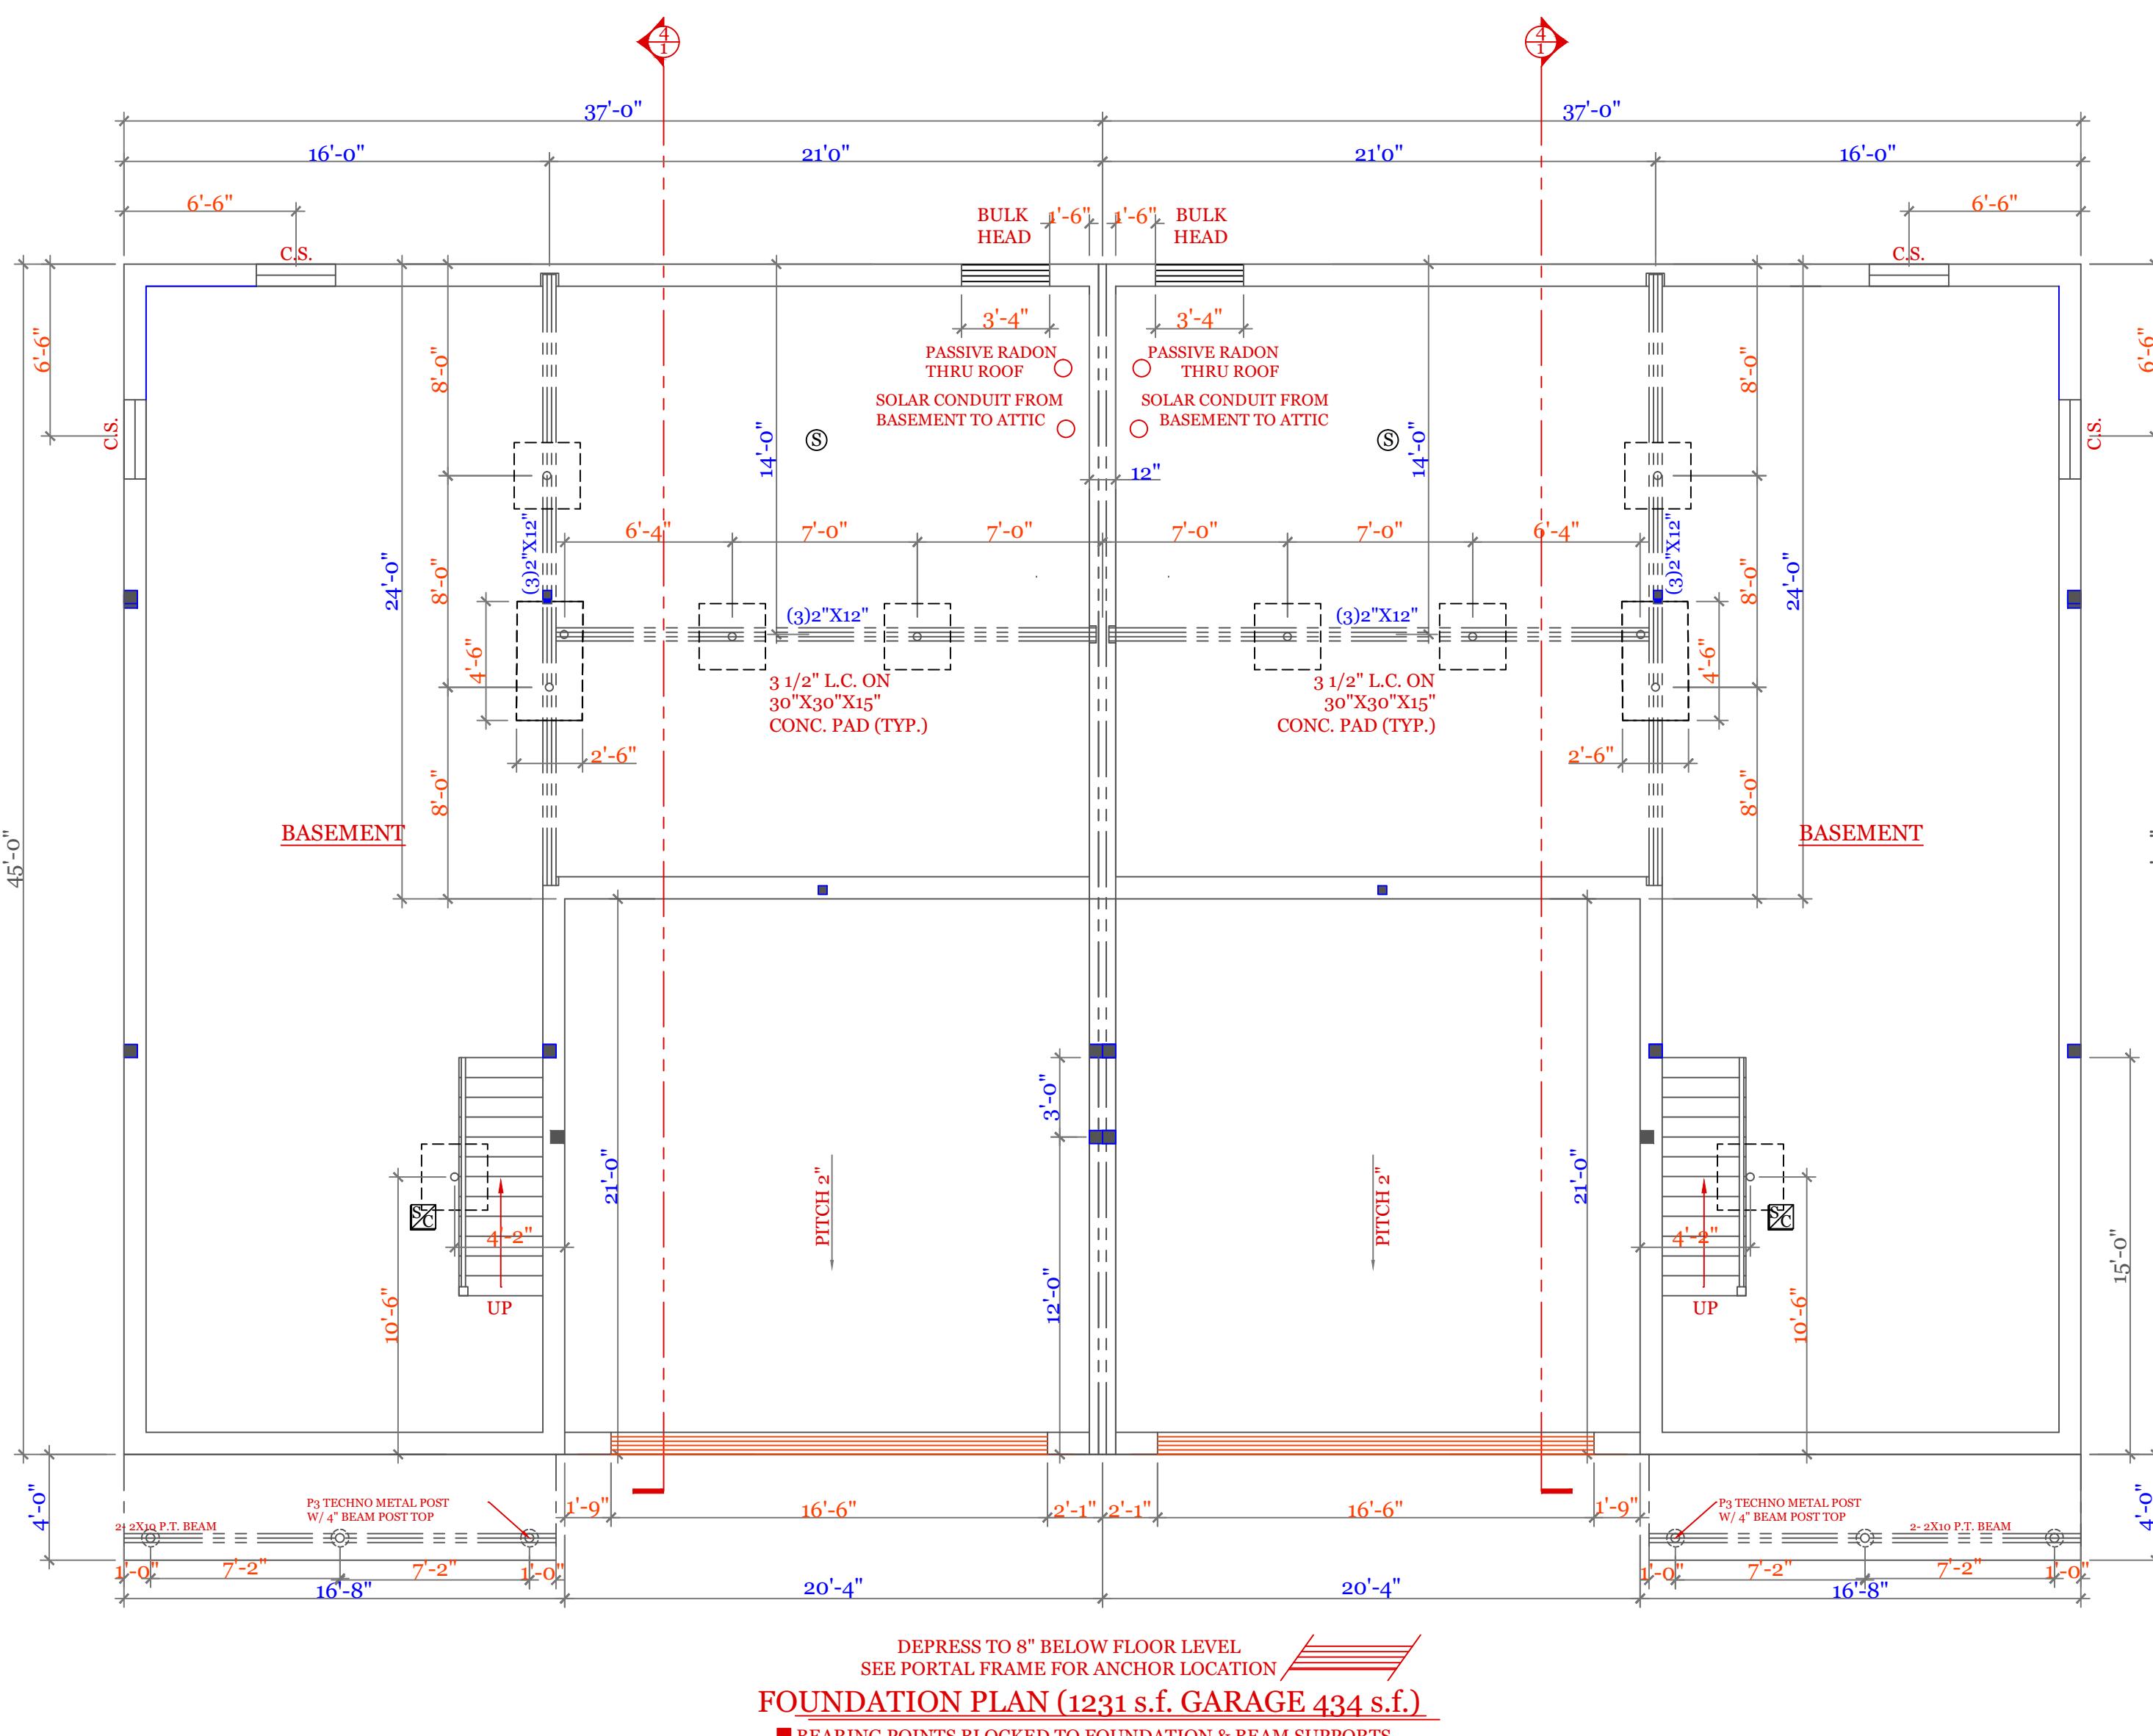

SYMBOL SCHEDULE;

- VENT
- SMOKE AND CARBON DETECTOR
- SMOKE DETECTOR
- HEAT DETECTOR
- BEARING POINT W/ SQUASH BLOCK

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NOTES:

- 1. HOUSE FOUNDATION- 10"X7'-10" POUR ON 20"X10" CONTINUOUS KEYED FOOTING. FOOTING TO BE PLACED ON UNDISTURBED SOIL OR 95% COMPACTED GRAVEL FREE OF ORGANIC SOIL AND MATERIAL.
- 2. GARAGE FOUNDATION- 8"X4"-0" MINIMUM POUR ON 16"X8" CONTINUOUS KEYED FOOTING. BOTTOM OF FOOTING TO BE 4'-0" MINIMUM BELOW GRADE. SOIL CONDITION SEE NOTE 1.
- 3. BASEMENT FLOOR-MINIMUM 3" CONCRETE (3,500 PSI)
- 4. GARAGE FLOOR- MINIMUM 4" CONCRETE (3,500 PSI) WITH WELDED WIRE FABRIC REINFORCEMENT. FLOOR TO PITCH 2° TOWARD OVERHEAD GARAGE DOOR'
- 5. ANCHOR BOLTS 12" FROM CORNERS AND 6'-0" ON CENTER.
- 6. ONE #4 REBAR WITHIN 12" OF THE TOP OF THE WALL, STORY AND ONE #4 BAR NEAR MID-HEIGHT OF THE WALL, STORY (TABLE R404.1.2(1) 2015 INTERNATIONAL RESIDENTIAL BUILDING CODE)

UNIT 'A' DUPLEX
HIGGINS FARM AT
SALISBURY HILL


FOUNDATION PLAN
PORTAL FRAME
DETAILS

UNIT 'A' DPLX
DATE: 9/20/2022 R5/5/23
SCALE: 3/16" = 1'-0"
DRAWN BY: RCS
CHECKED BY: MJB
Sheet 3 OF 8

3

NOTES:

SYMBOL SCHEDULE;
 V VENT
 SC SMOKE AND CARBON DETECTOR
 S SMOKE DETECTOR
 H HEAT DETECTOR
 ■ BEARING POINT
 W SQUASH BLOCK

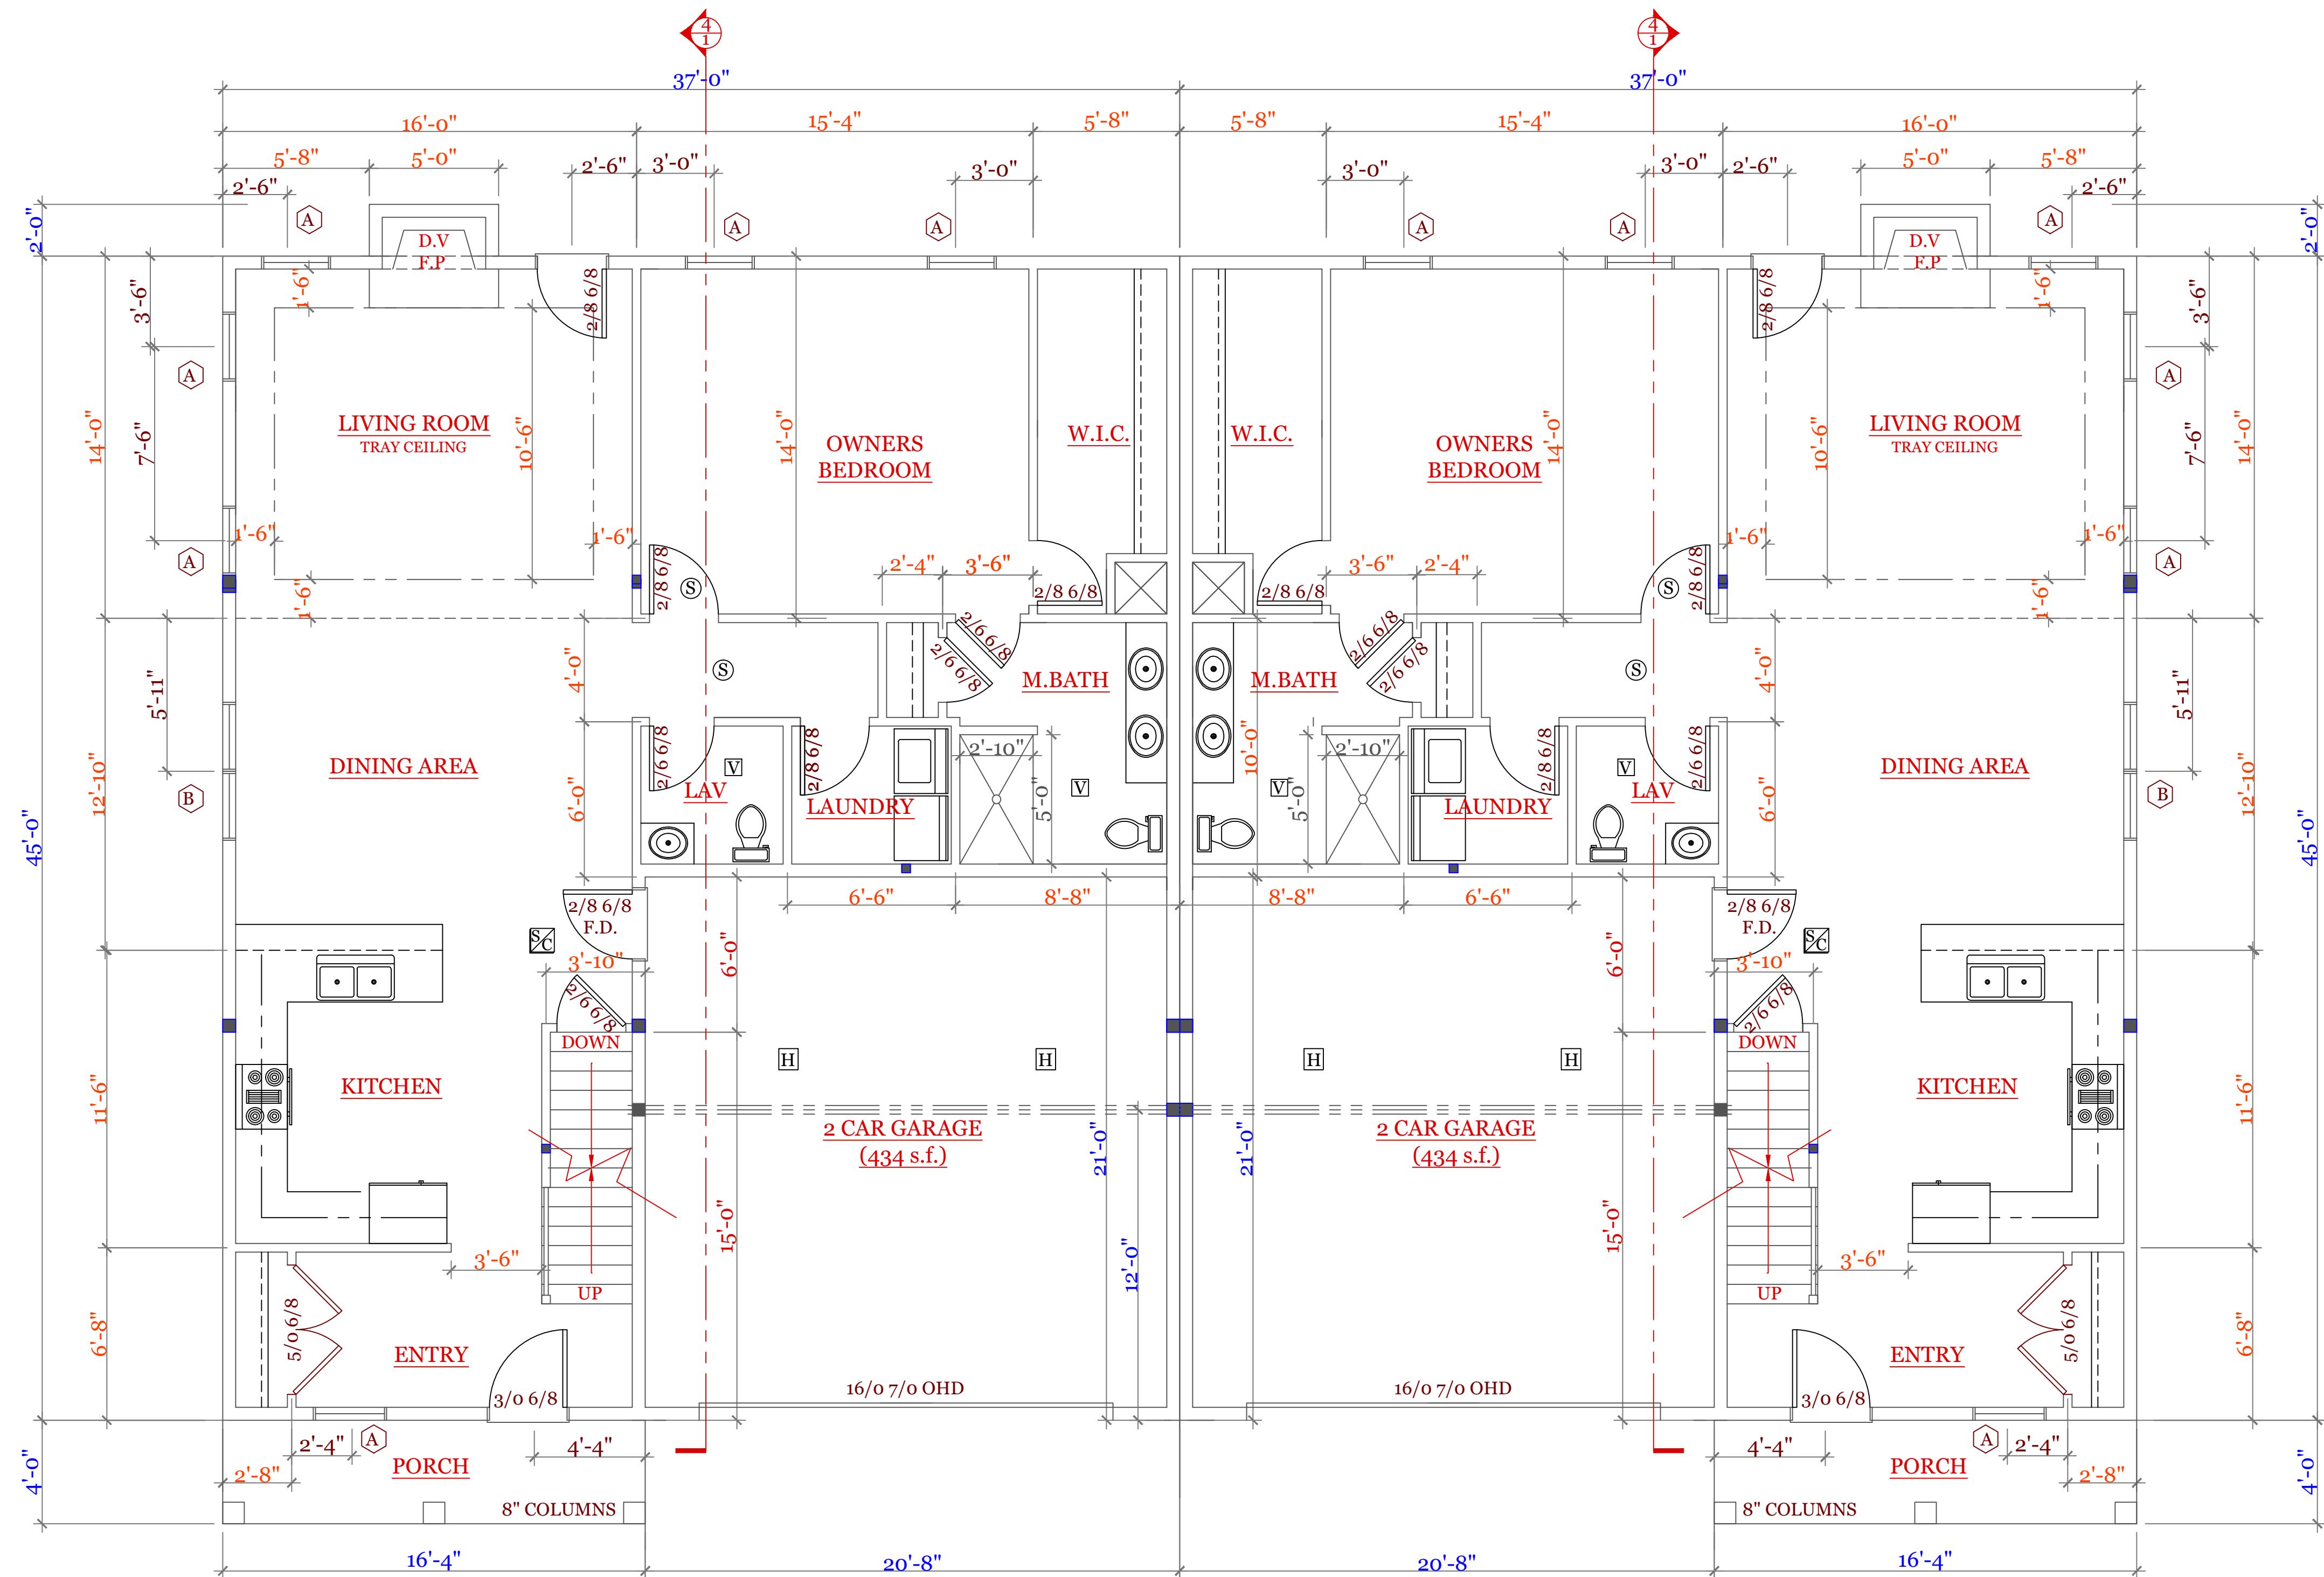

FIRST FLOOR PLAN (1231 s.f. GARAGE 434 s.f.)

■ BEARING POINTS BLOCKED TO FOUNDATION & BEAM SUPPORTS

WINDOW & EXTERIOR DOOR SCHEDULE: HARVEY			
INDEX	QUA	CATALOG	ROUGH OPENING
A	12	10000-1	2'-8 1/4" X 5'-6 1/4"
B	2	11000-1	5'-4 3/4" X 5'-6 1/4"
C	2	12000-1	5'-4 1/2" X 4'-9 1/4"
D	N/A	N/A	N/A
E	2	A2281	5'-3 1/4" X 2'-0 5/8"
F	1	15000-1	5'-4 1/2" X 6'-10 1/2"
G	1	16000-1	3'-2 1/2" X 6'-10 1/2"

NOTES: CONSULT TABLE 603.7(1) JACKS & HEADERS

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UNIT 'A' DUPLEX
 HIGGINS FARM AT
 SALISBURY HILL

FIRST & SECOND
 FLOOR PLAN
 WINDOW SCHEDULE

UNIT 'A' DPLX

DATE: 9/20/2022 R5/5/23

SCALE: 1/4"=1'-0"


DRAWN BY: RWS

CHECKED BY: RCS

Sheet 4 OF 8

4

NOTES:

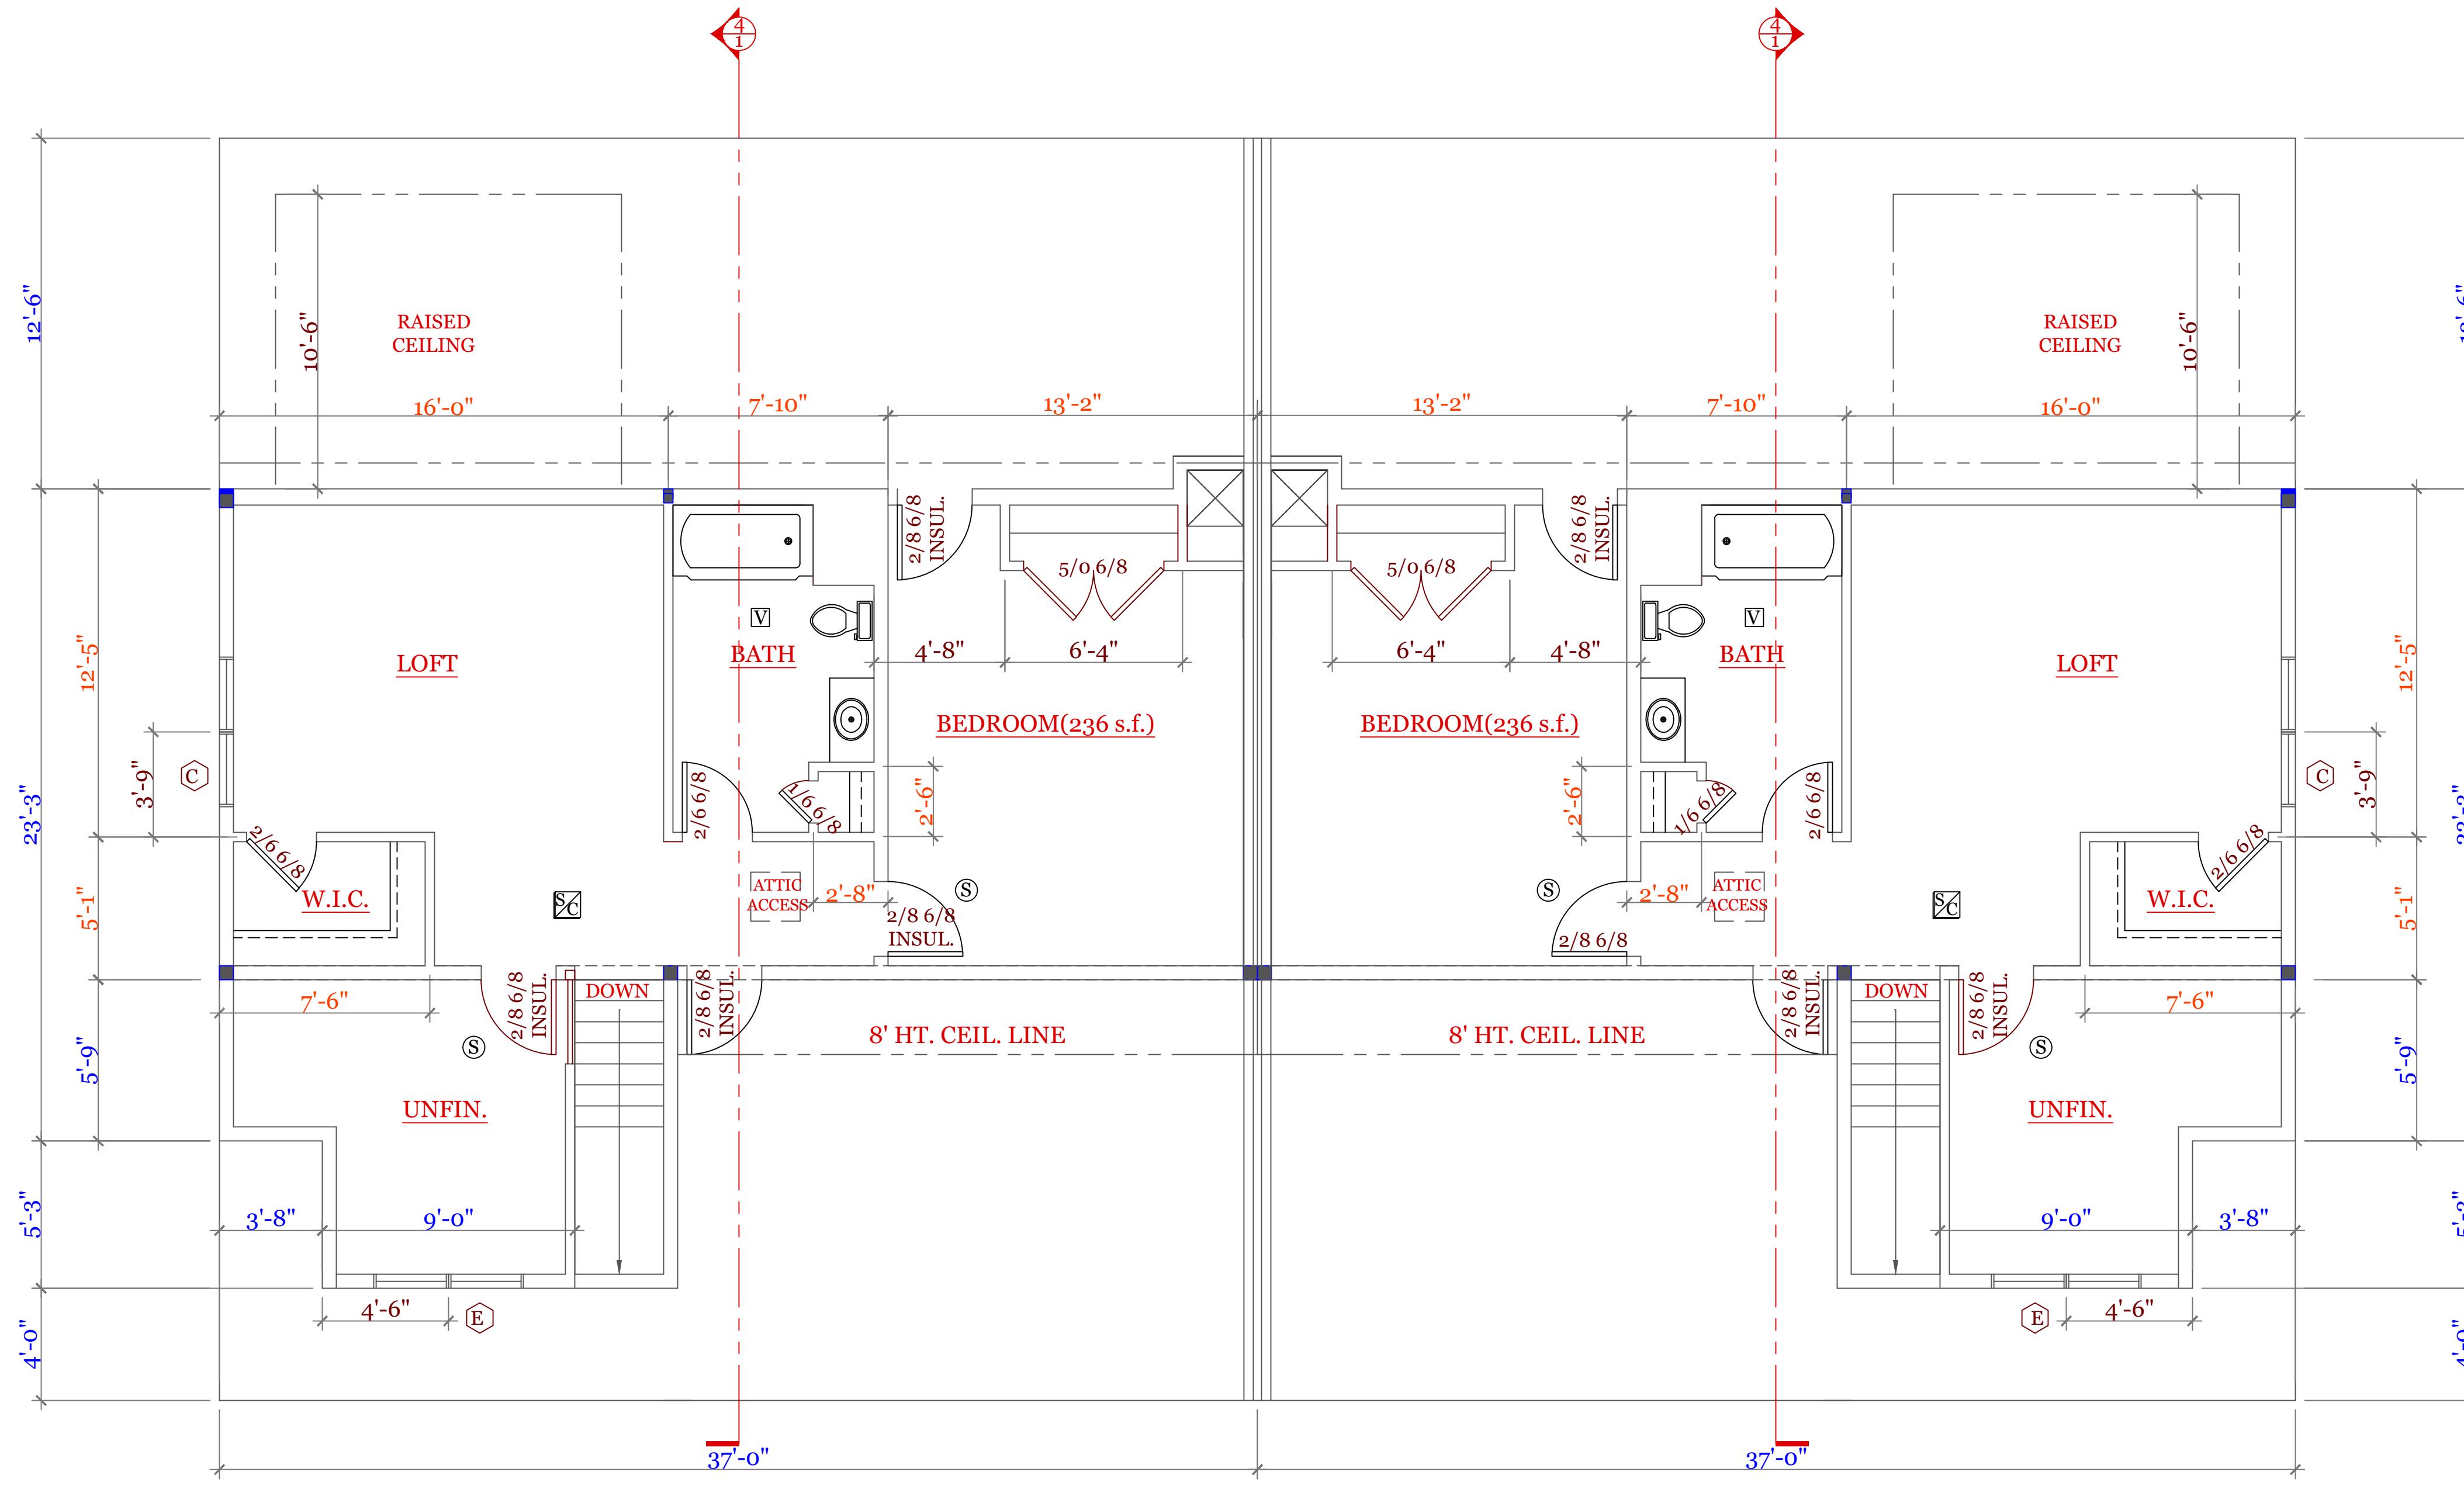

WINDOW & EXTERIOR DOOR SCHEDULE: HARVEY

INDEX	QUA	CATALOG	ROUGH OPENING
A	12	10000-1	2'-8 1/4" X 5'-6 1/4"
B	2	11000-1	5'-4 3/4" X 5'-6 1/4"
C	2	12000-1	5'-4 1/2" X 4'-9 1/4"
D	N/A	N/A	N/A
E	2	A2281	5'-3 1/4" X 2'-0 5/8"
F	1	15000-1	5'-4 1/2" X 6'-10 1/2"
G	1	16000-1	3'-2 1/2" X 6'-10 1/2"

NOTES: CONSULT TABLE 603.7(1) JACKS & HEADERS




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MICHAEL J. BURKE P.E.
299 SALISBURY STR.
WORCESTER, MA
(508)450-3461UNIT 'A' DUPLEX
HIGGINS FARM AT
SALISBURY HILLSECOND FLOOR PLAN
WINDOW SCHEDULE

UNIT 'A' DPLX

DATE:	9/20/2022 R5/5/23
SCALE:	1/4"=1'-0"
DRAWN BY:	RCS
CHECKED BY:	MJB
Sheet	5 OF 8

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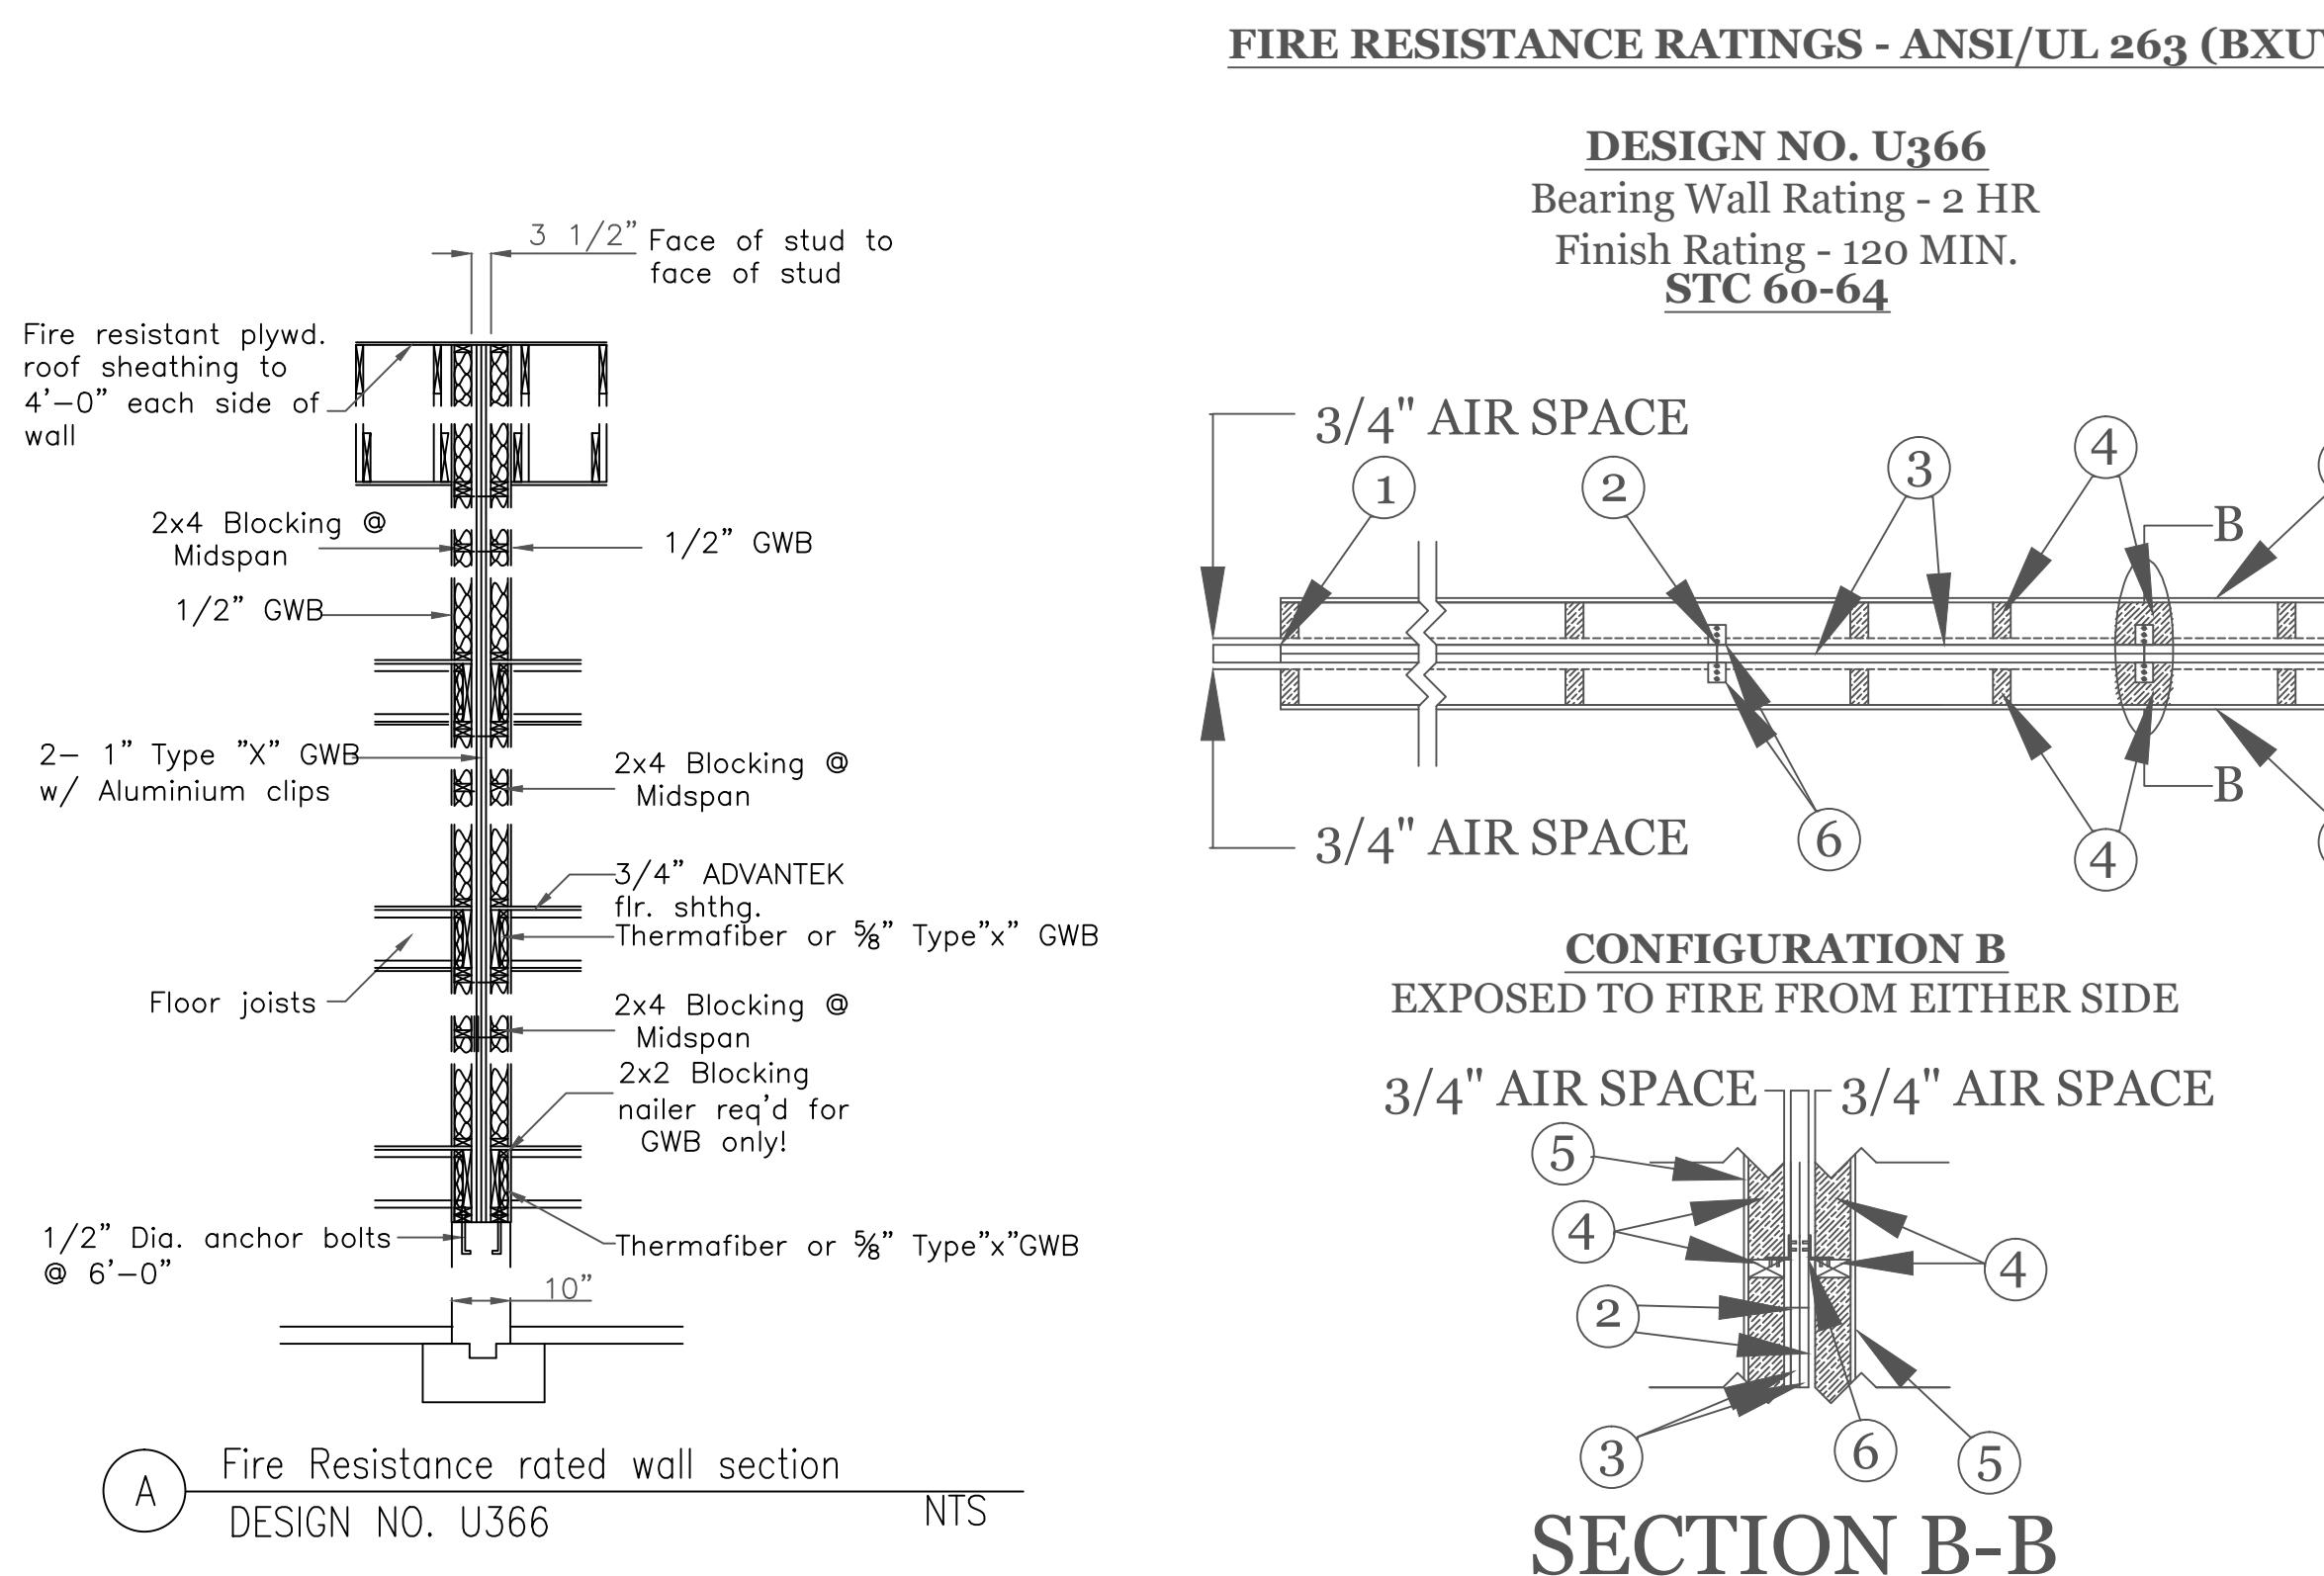
TYPICAL BUILDING SECTION

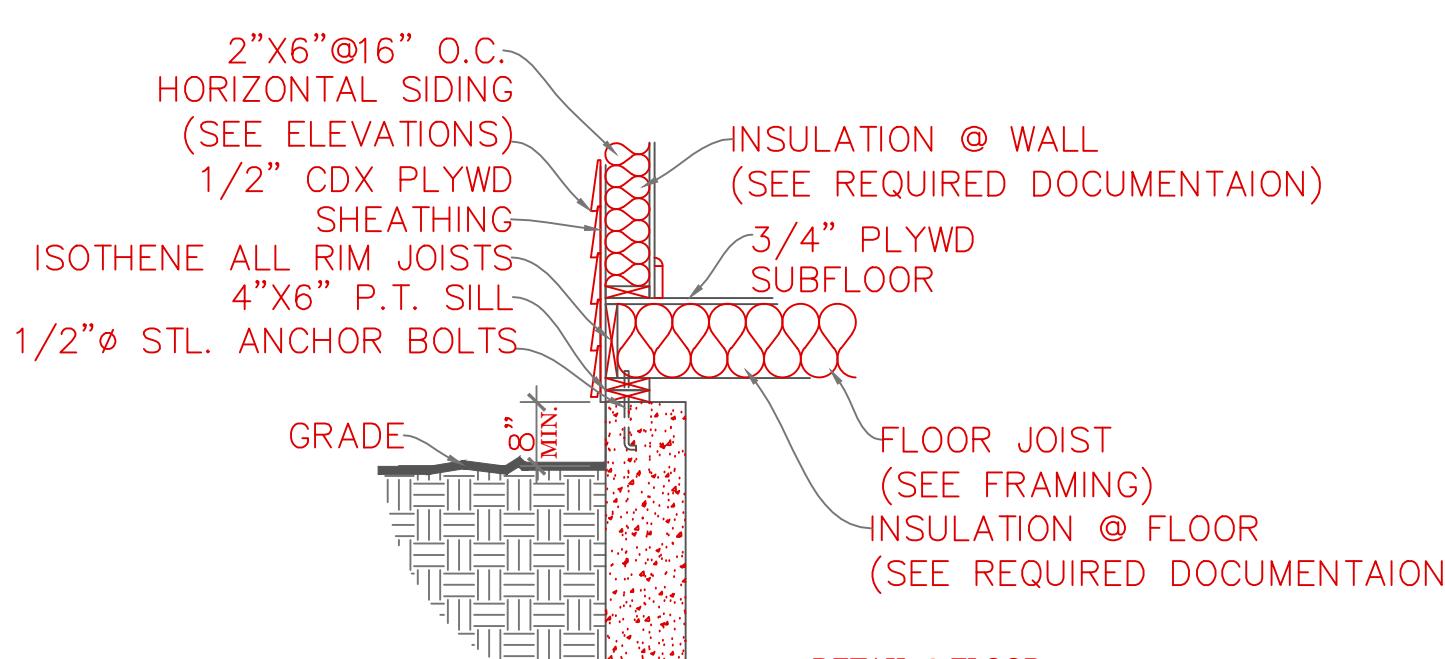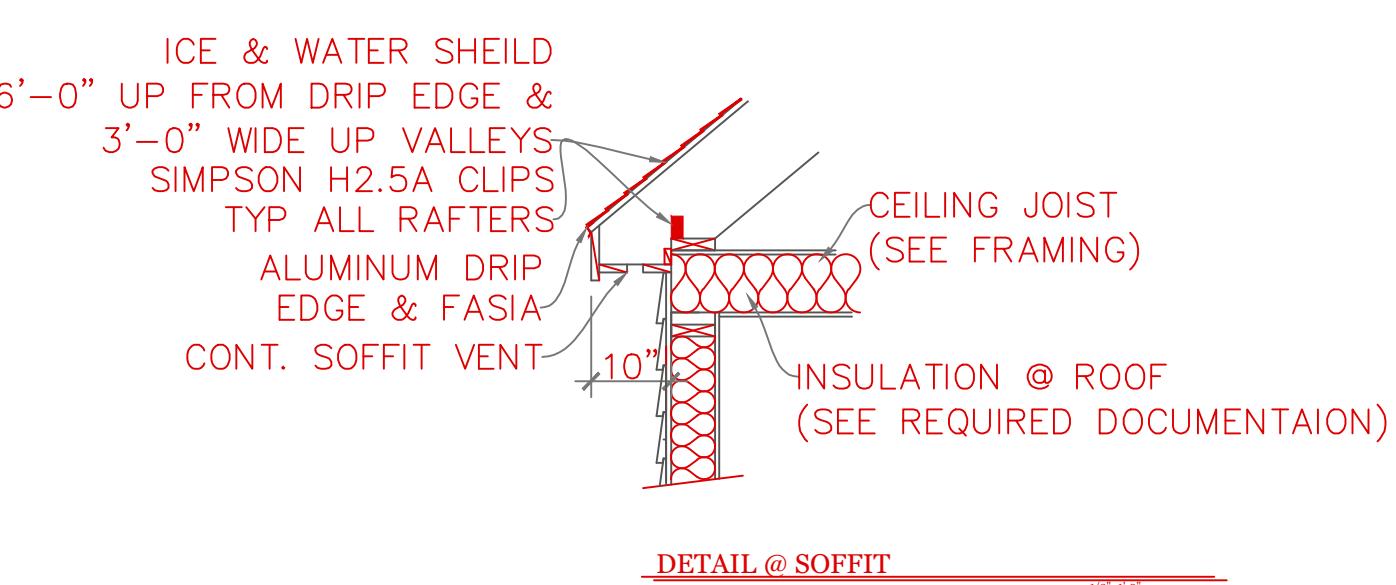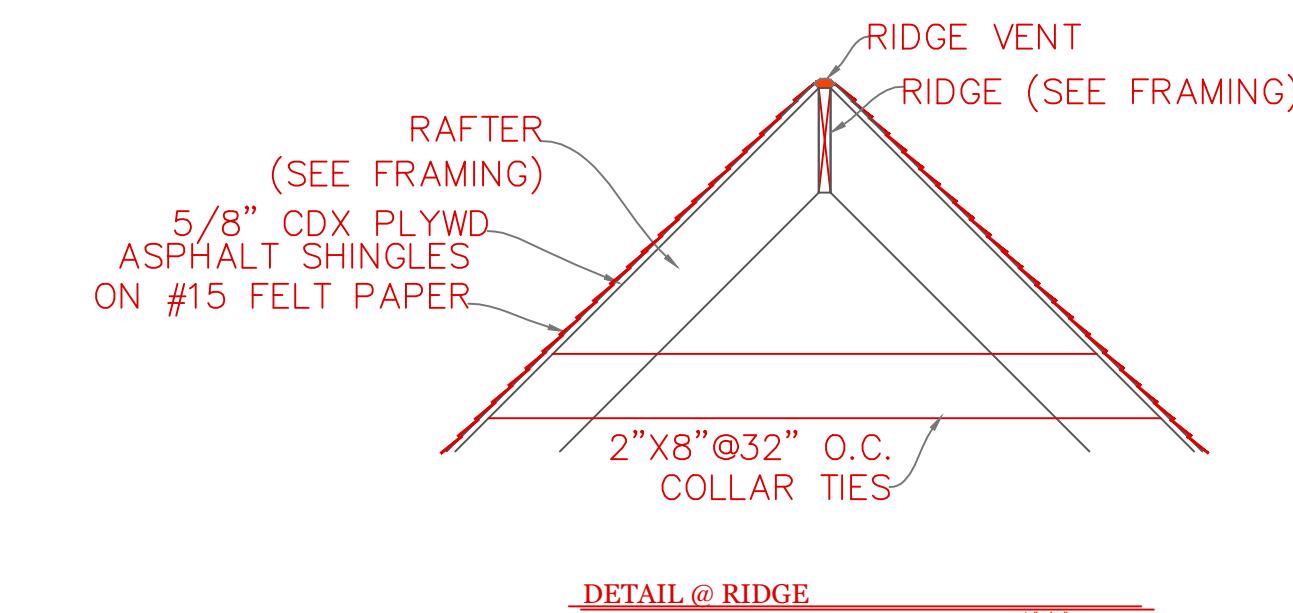

CONSTRUCTION SCHEDULE:		(UNLESS NOTED OTHERWISE ON PLAN)
1	RIDGE BOARD:	2X12
2	ROOF MATERIAL:	ASPHALT SHINGLES ON 15# ROOF FELT
3	ROOF SHEATHING	1/2" O.S.B. w/ 15# ROOF FELT
4	ROOF RAFTER:	SEE FRAMING
5	COLLAR TIES:	1X8 @ 32" O.C.
6	DRIP EDGE	ALUMINUM DRIP EDGE
7	SOFFIT:	CONT. SOFFIT VENT
8	CEILING JOIST	SEE FRAMING
9	ATTIC INSULATION	R-38
10	EXT WALL:	2"X6" @ 16" O.C.
11	EXT. SHEATHING	1/2" O.S.B. w/ HOUSE WRAP
12	EXT. FINISH	SEE ELEVATIONS
13	INSULATION@WALL	R-21
14	INTERIOR WALL	2"X4"@16"O.C.
15	SUB FLOOR:	3/4" ADVANTEK GLUED & NAILED
16	JOIST:	SEE FRAMING.
17	SILL:	2"X6" P.T. SILL W/ 2X6 KD TOP PLATE
18	INSULATION @ FLOOR	R-30
19	ANCHOR:	1/2"Ø STL ANCHOR BOLTS
20	BEAM:	SEE FRAMING PLAN
21	COLUMN:	3 1/2" L.C.
22	FND. WALL:	10"X7'-10" CONC. WALL
23	SLAB:	SEE FOUNDATION NOTES
24	FOOTING:	20"X10" CONT. KEYED FTNG
25	CONC. PAD:	30"X30"X15" CONC. PAD

NOTES:

- ISOThENE ALL RIM JOISTS (OPTIONAL)
- ICE & WATER SHEILD 6'-0" UP FROM DRIP EDGE
- & 3'-0" WIDE UP VALLEYS
- SIMPSON H2.5A CLIPS TYP ALL RAFTERS





AREA SEPARATION WALL: - (Max Height - 44 ft)

- 1. Floor, Intermediate or Top Wall** - 2 in. wide channel shaped with 1 in. long legs formed from No. 25 MSG galv steel, secured with suitable fasteners spaced 24 in. O.C.
 - 2. Steel Studs** - Steel members formed from No. 25 MSG galv steel having "H" - shaped flanged spaced 24 in. O.C.; overall depth 2in. and flange width 1-3/8 in.
 - 3. Gypsum Board*** - Two layers of 1 in. thick gypsum wallboard liner panels, supplied in nom 24 in. widths. Vertical edges of panels friction fitted into "H" - shaped studs.

BPB AMERICA INC - ProRoc Shaftliner
JAMES HARDIE GYPSUM INC - ProRoc Shaftliner

PROTECTED WALL: - (Bearing or Nonbearing Wall)
 - 4. Wood Studs** - Nom 2 by 4 in. max spacing 16 in. O.C. Studs cross-braced at midheight where necessary for clip attachment. Min 3/4 in. separation between wood framing and area separation wall.
 - 5. Gypsum Board** - Classified or Unclassified - Min. 1/2 in. thick, 4 ft. wide, applied either horizontally or vertically. Wallboard attached to studs with 1-1/4 in. long steel drywall nails space 8 in. O.C. Vertical joints located over studs. (Optional) Joints covered with paper tape and joint compound. Nail heads covered with joint compound.
 - 6. Attachment Clips** - Aluminum angle; 0.063 in. thick, min 2 in. wide with min 2 in. and 2-1/4 in. legs. Clips secured with Type S screws 3/8 in. long to "H" studs and with Type W screws 1-1/4 in. long to wood framing through holes provided in clip. Clips spaced a max of 10ft. O.C. vertically between wood framing and "H" studs for separation walls up to 23 ft. high. For separation walls up to 44 ft. high, clips spaced as described above for the upper 24 ft. and the remaining wall area below requires clips spaced a max of 5 ft. O.C. vertically between wood framing and "H" studs.

* Bearing the UL Classification Mark

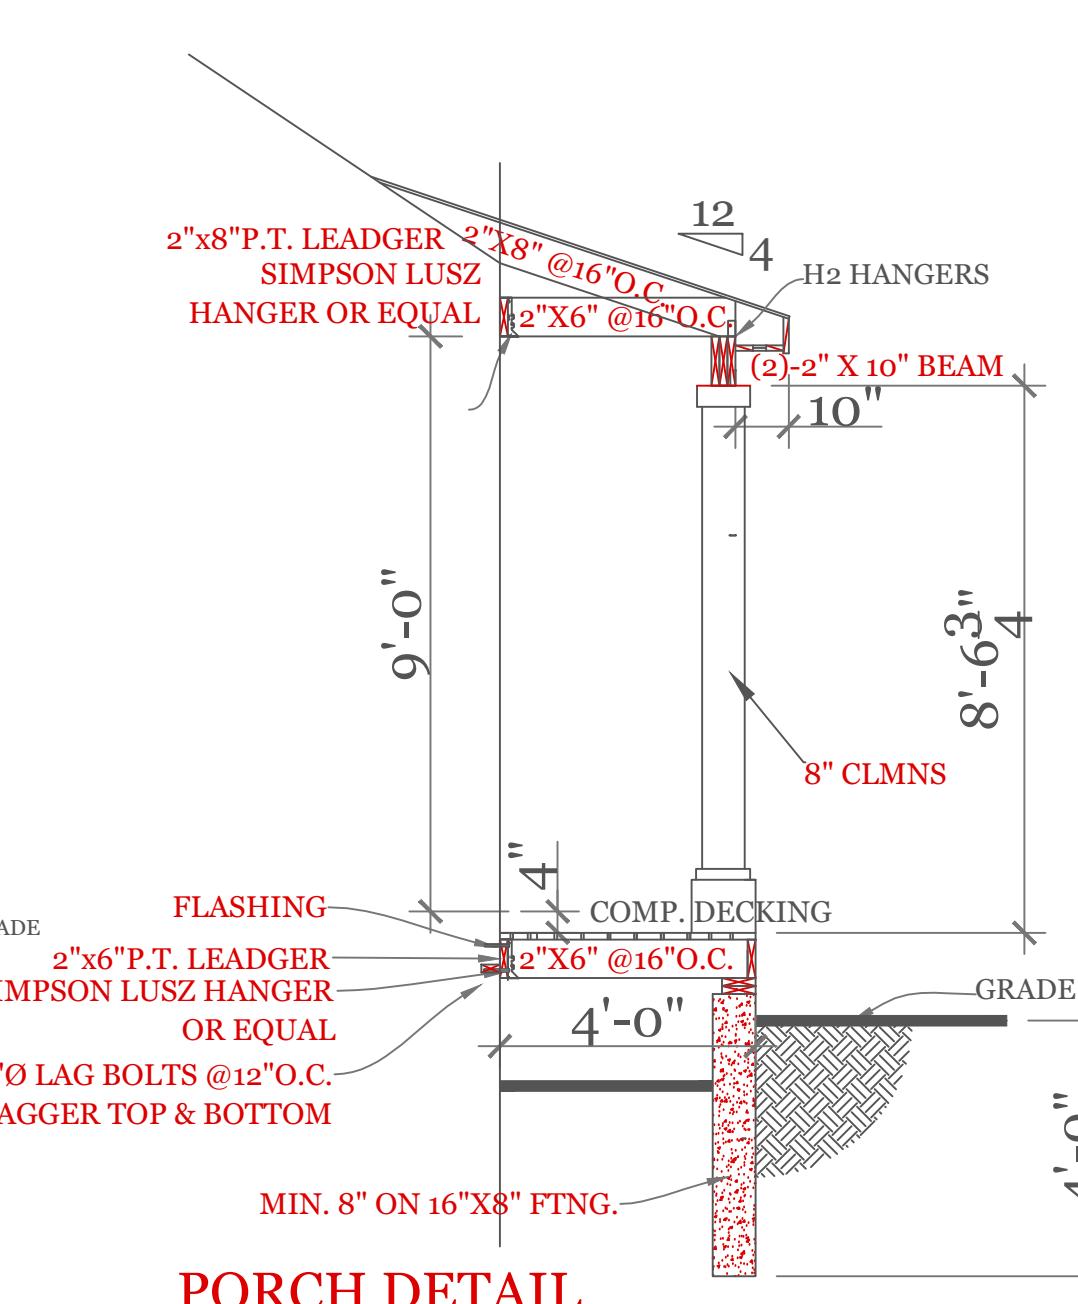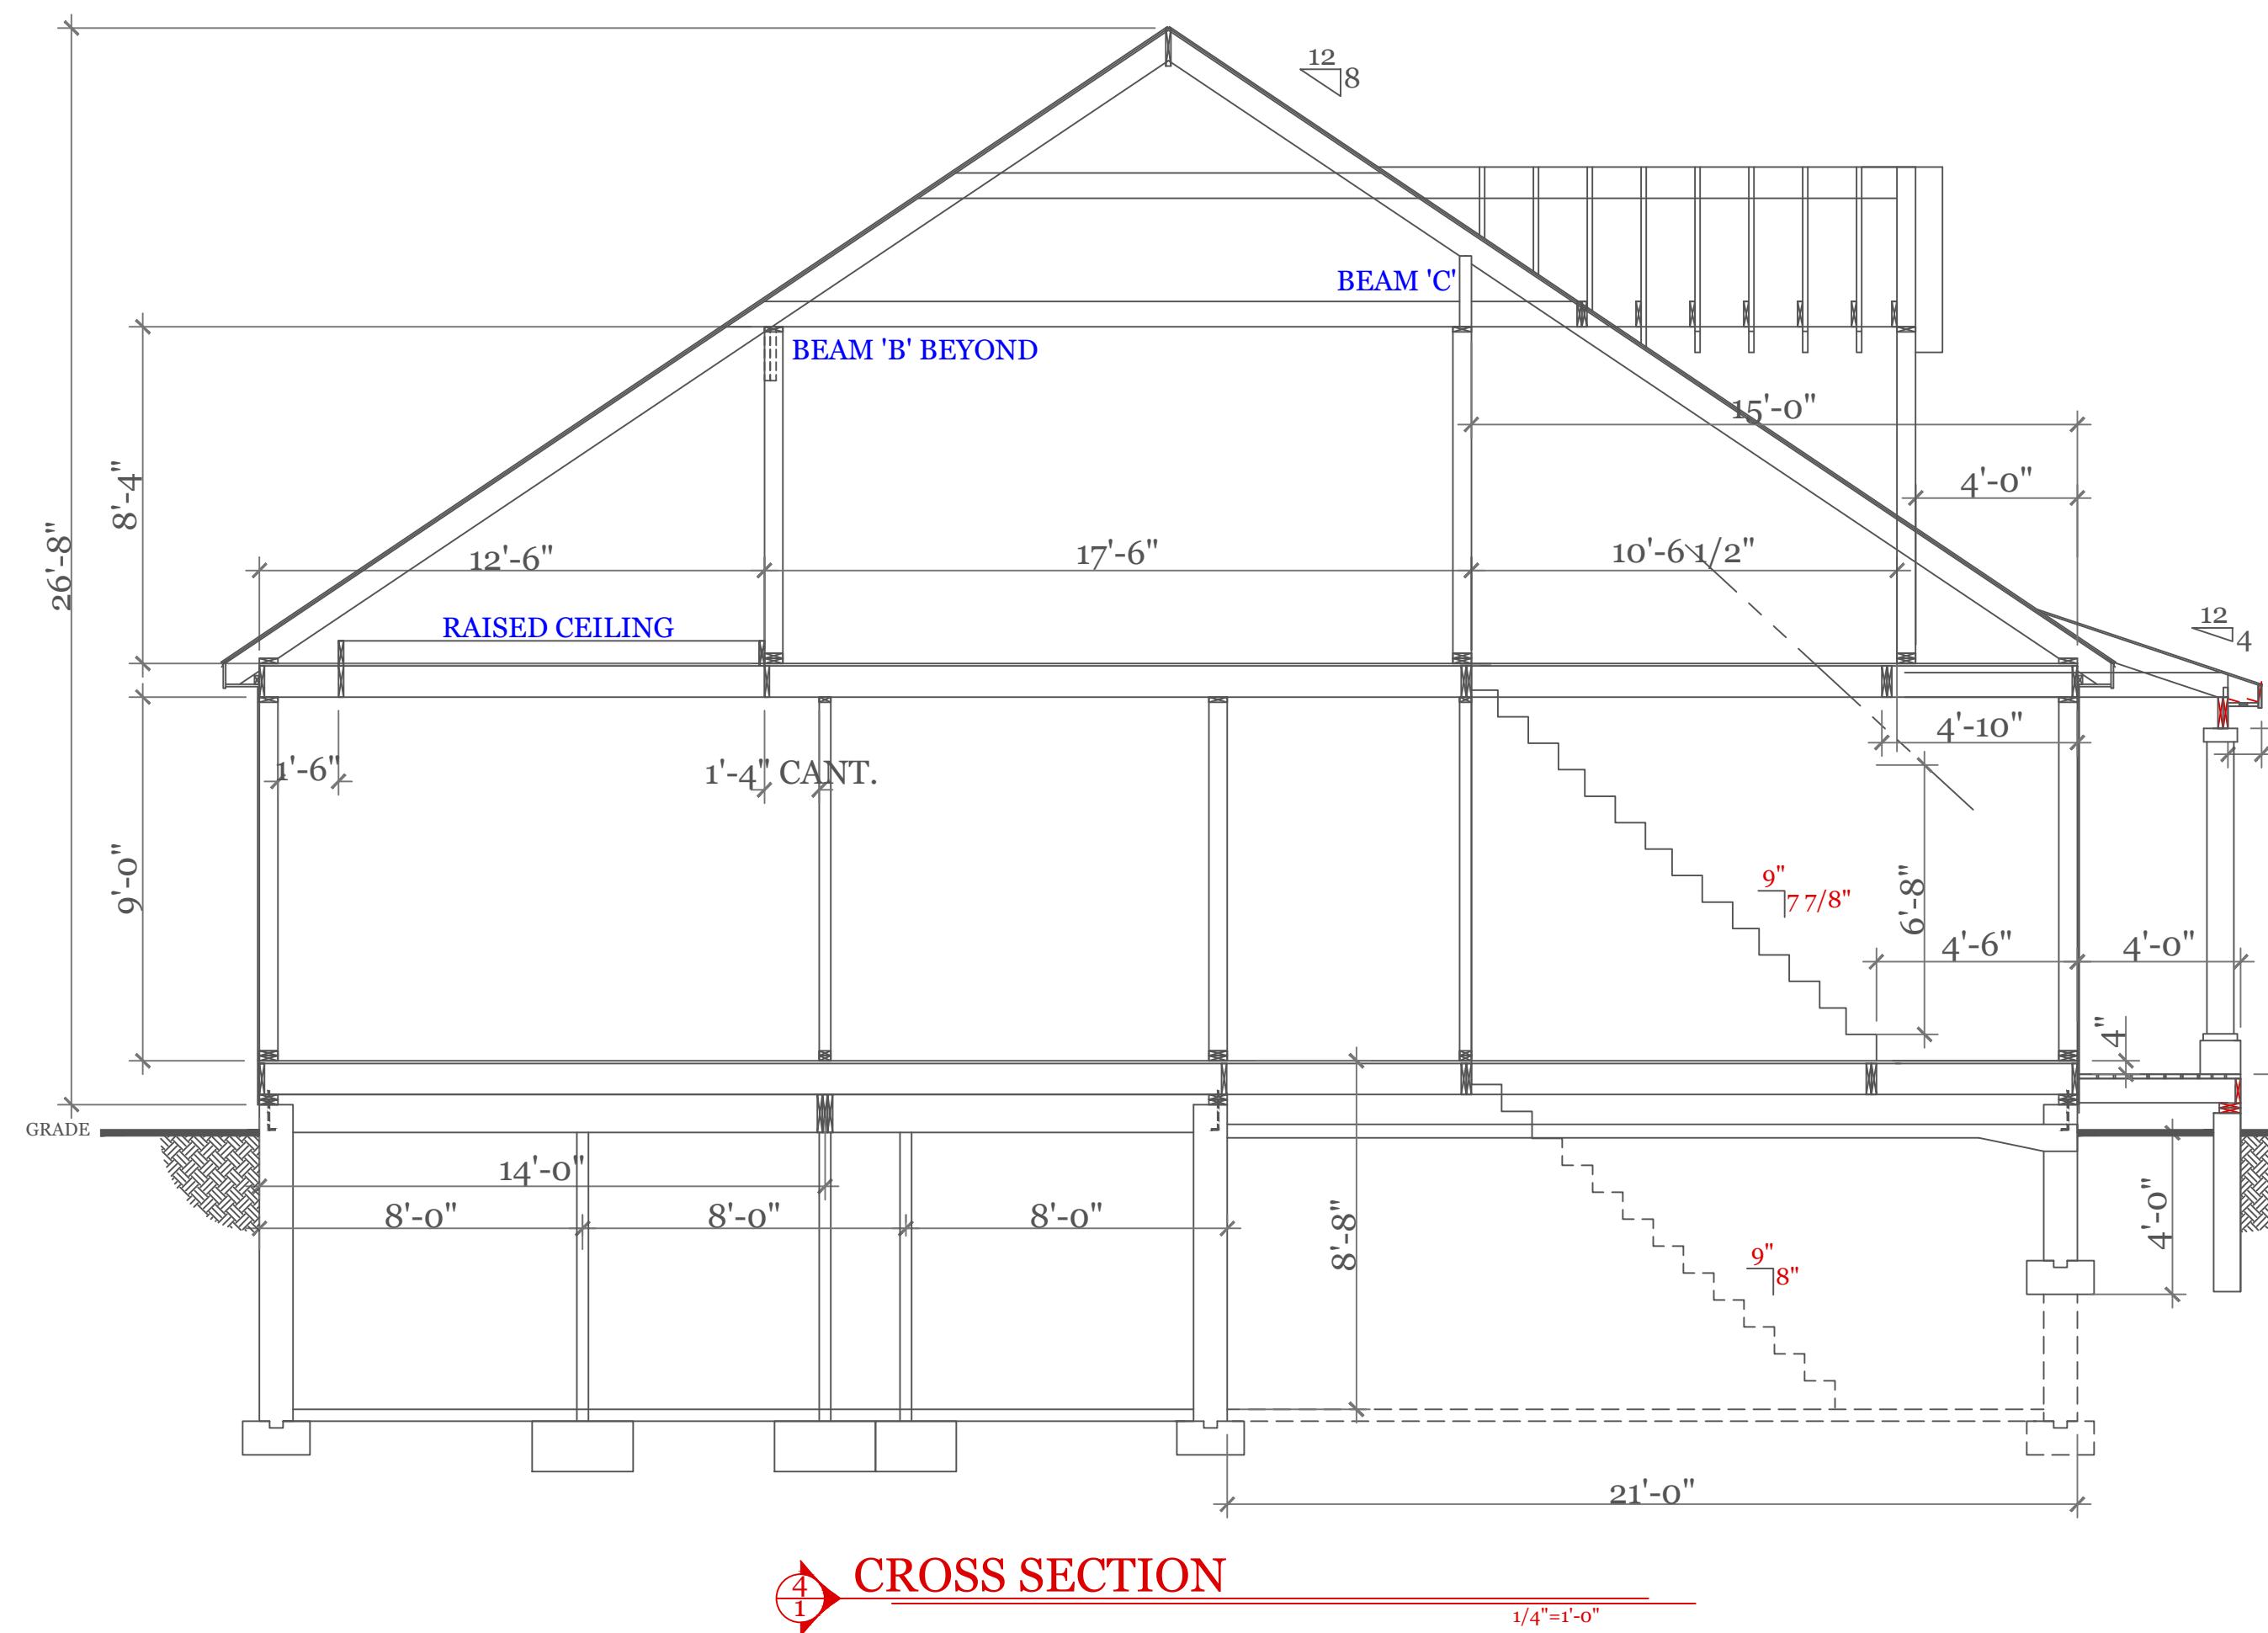

PORCH DETAILS

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CONSULTING
MICHAEL J. F.
299 SALISB
WORCEST
(508)450

BUILDING SECTION FIRE WALL U366 DETAILS

UNIT 'A' DPLX

DATE: 9/20-2022 R5/5/23

SCALE: AS NOTED


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CHECKED BY: MJ


Sheet 6 OF 8

6 OF

6

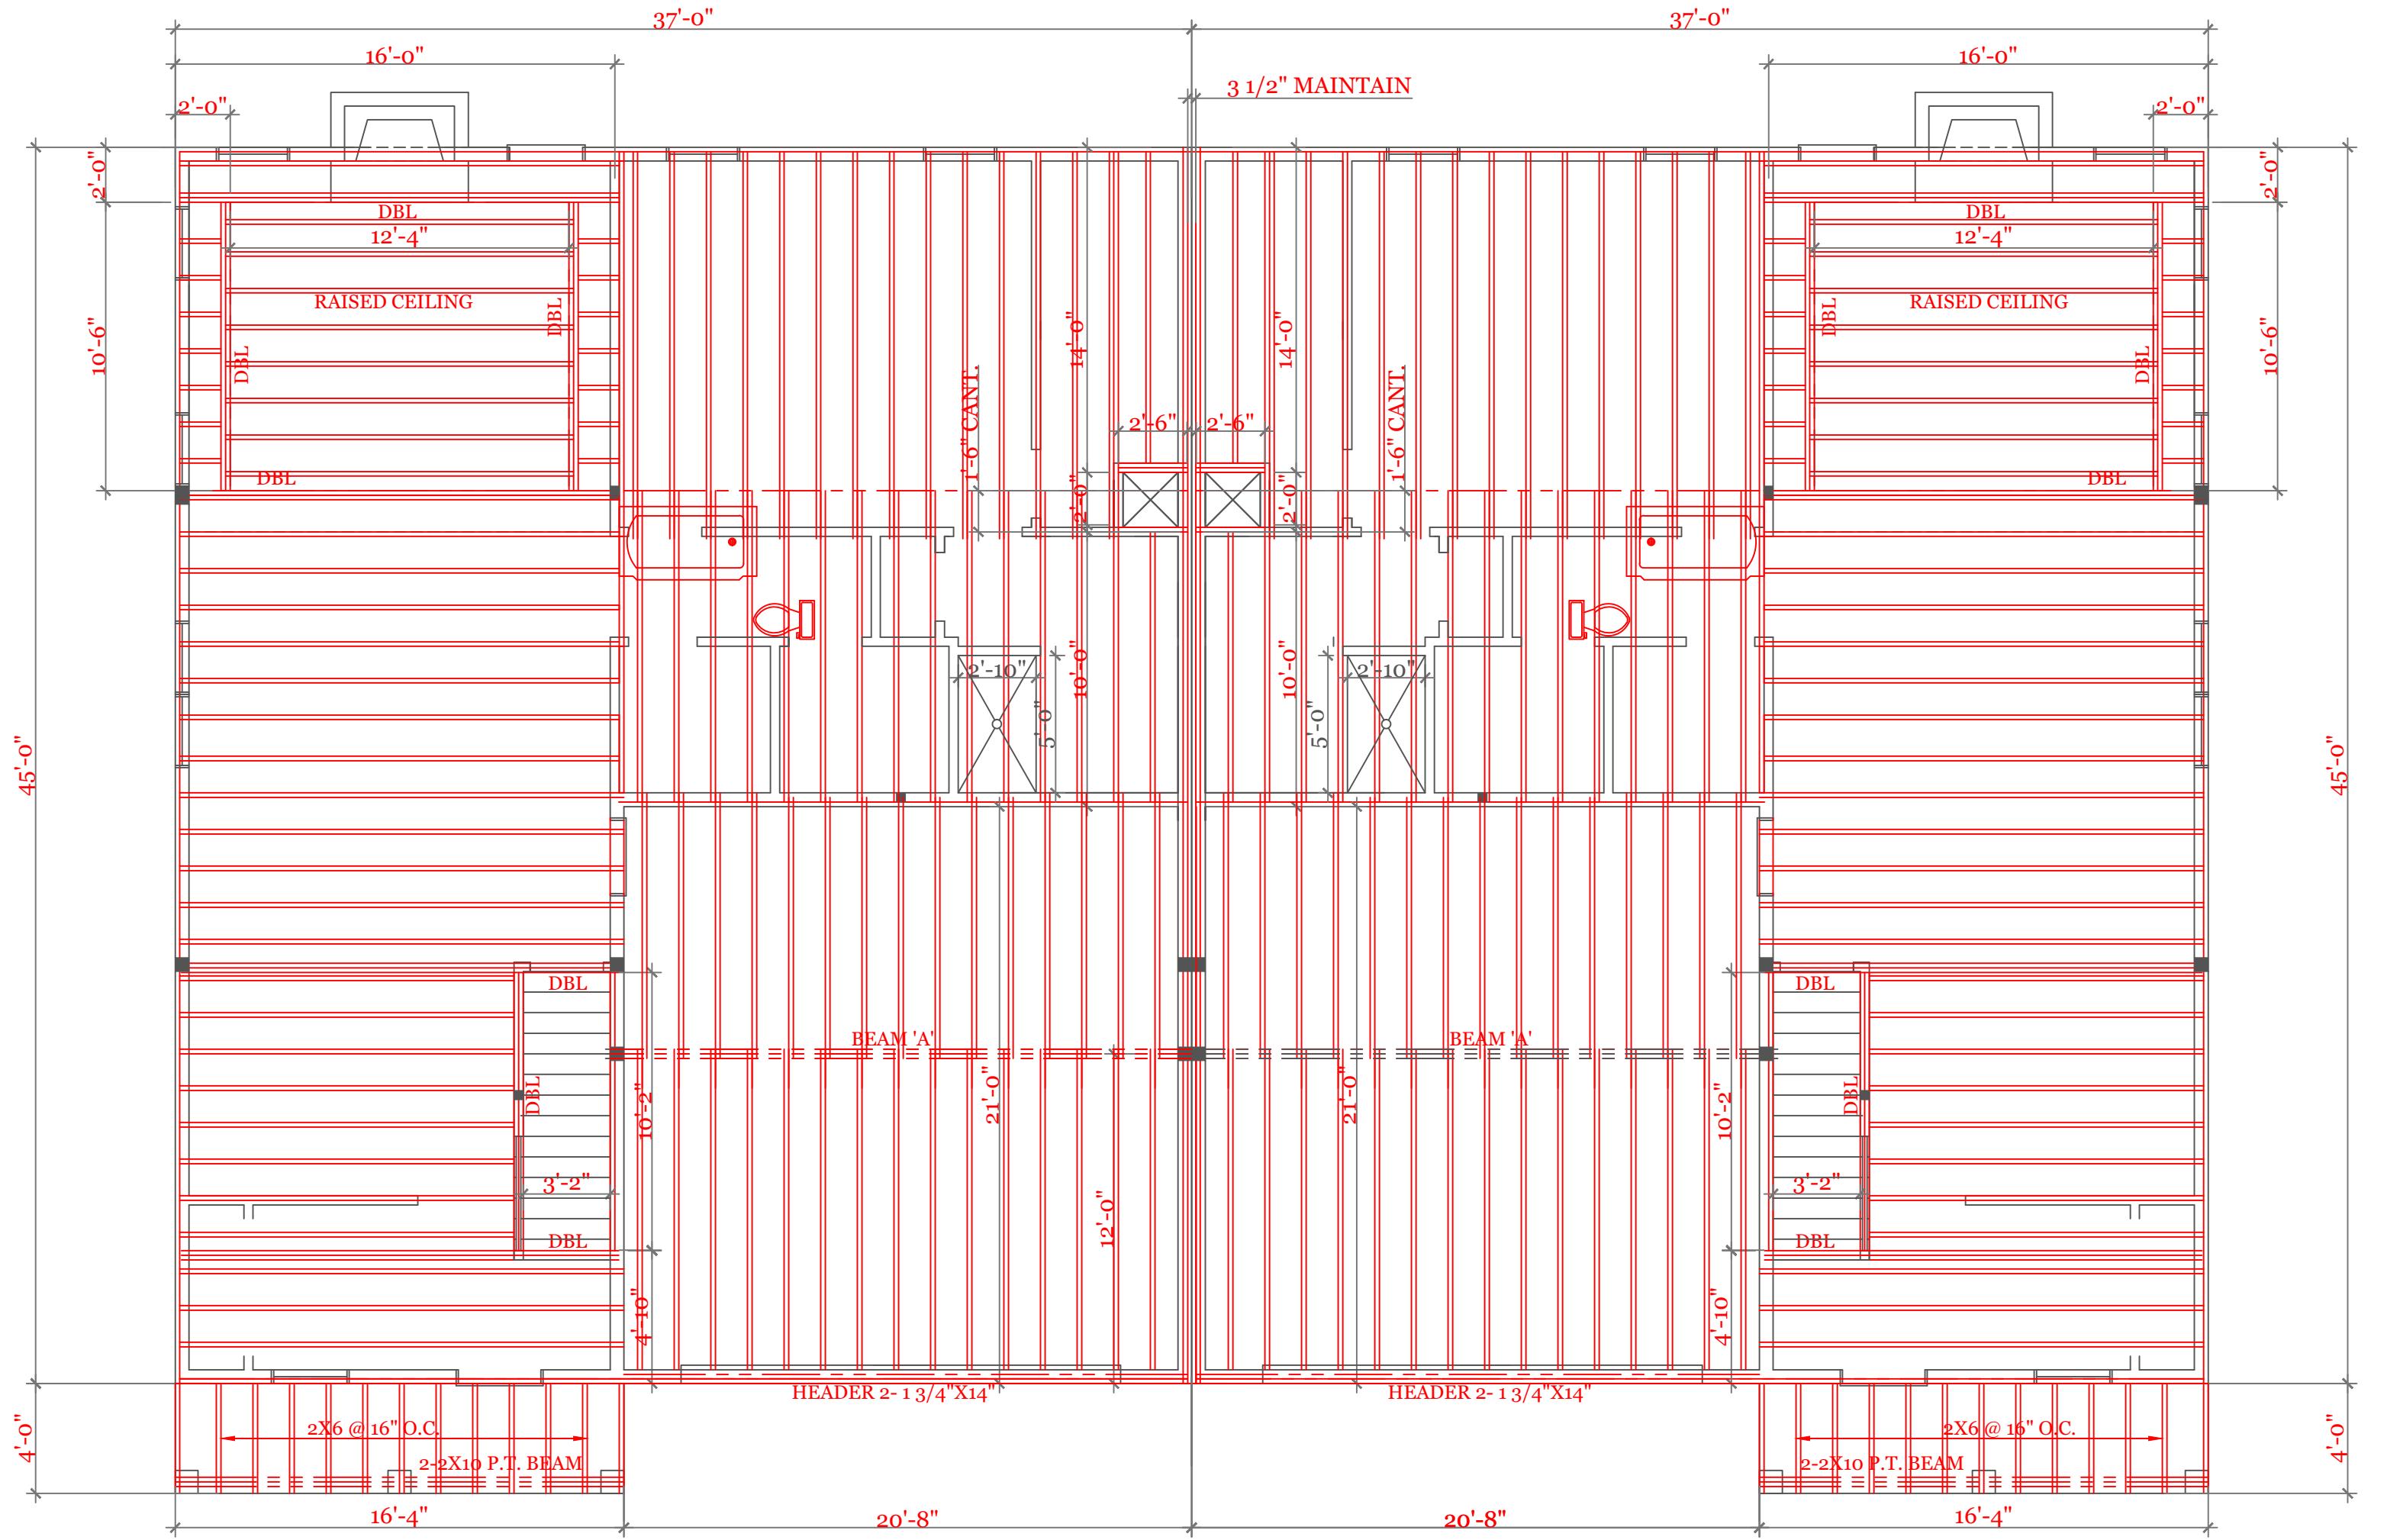

SECOND FLOOR FRAMING (2"X10"@16"O.C. UNLESS NOTED)
■ BEARING POINTS BLOCKED TO FOUNDATION & BEAM SUPPORTS

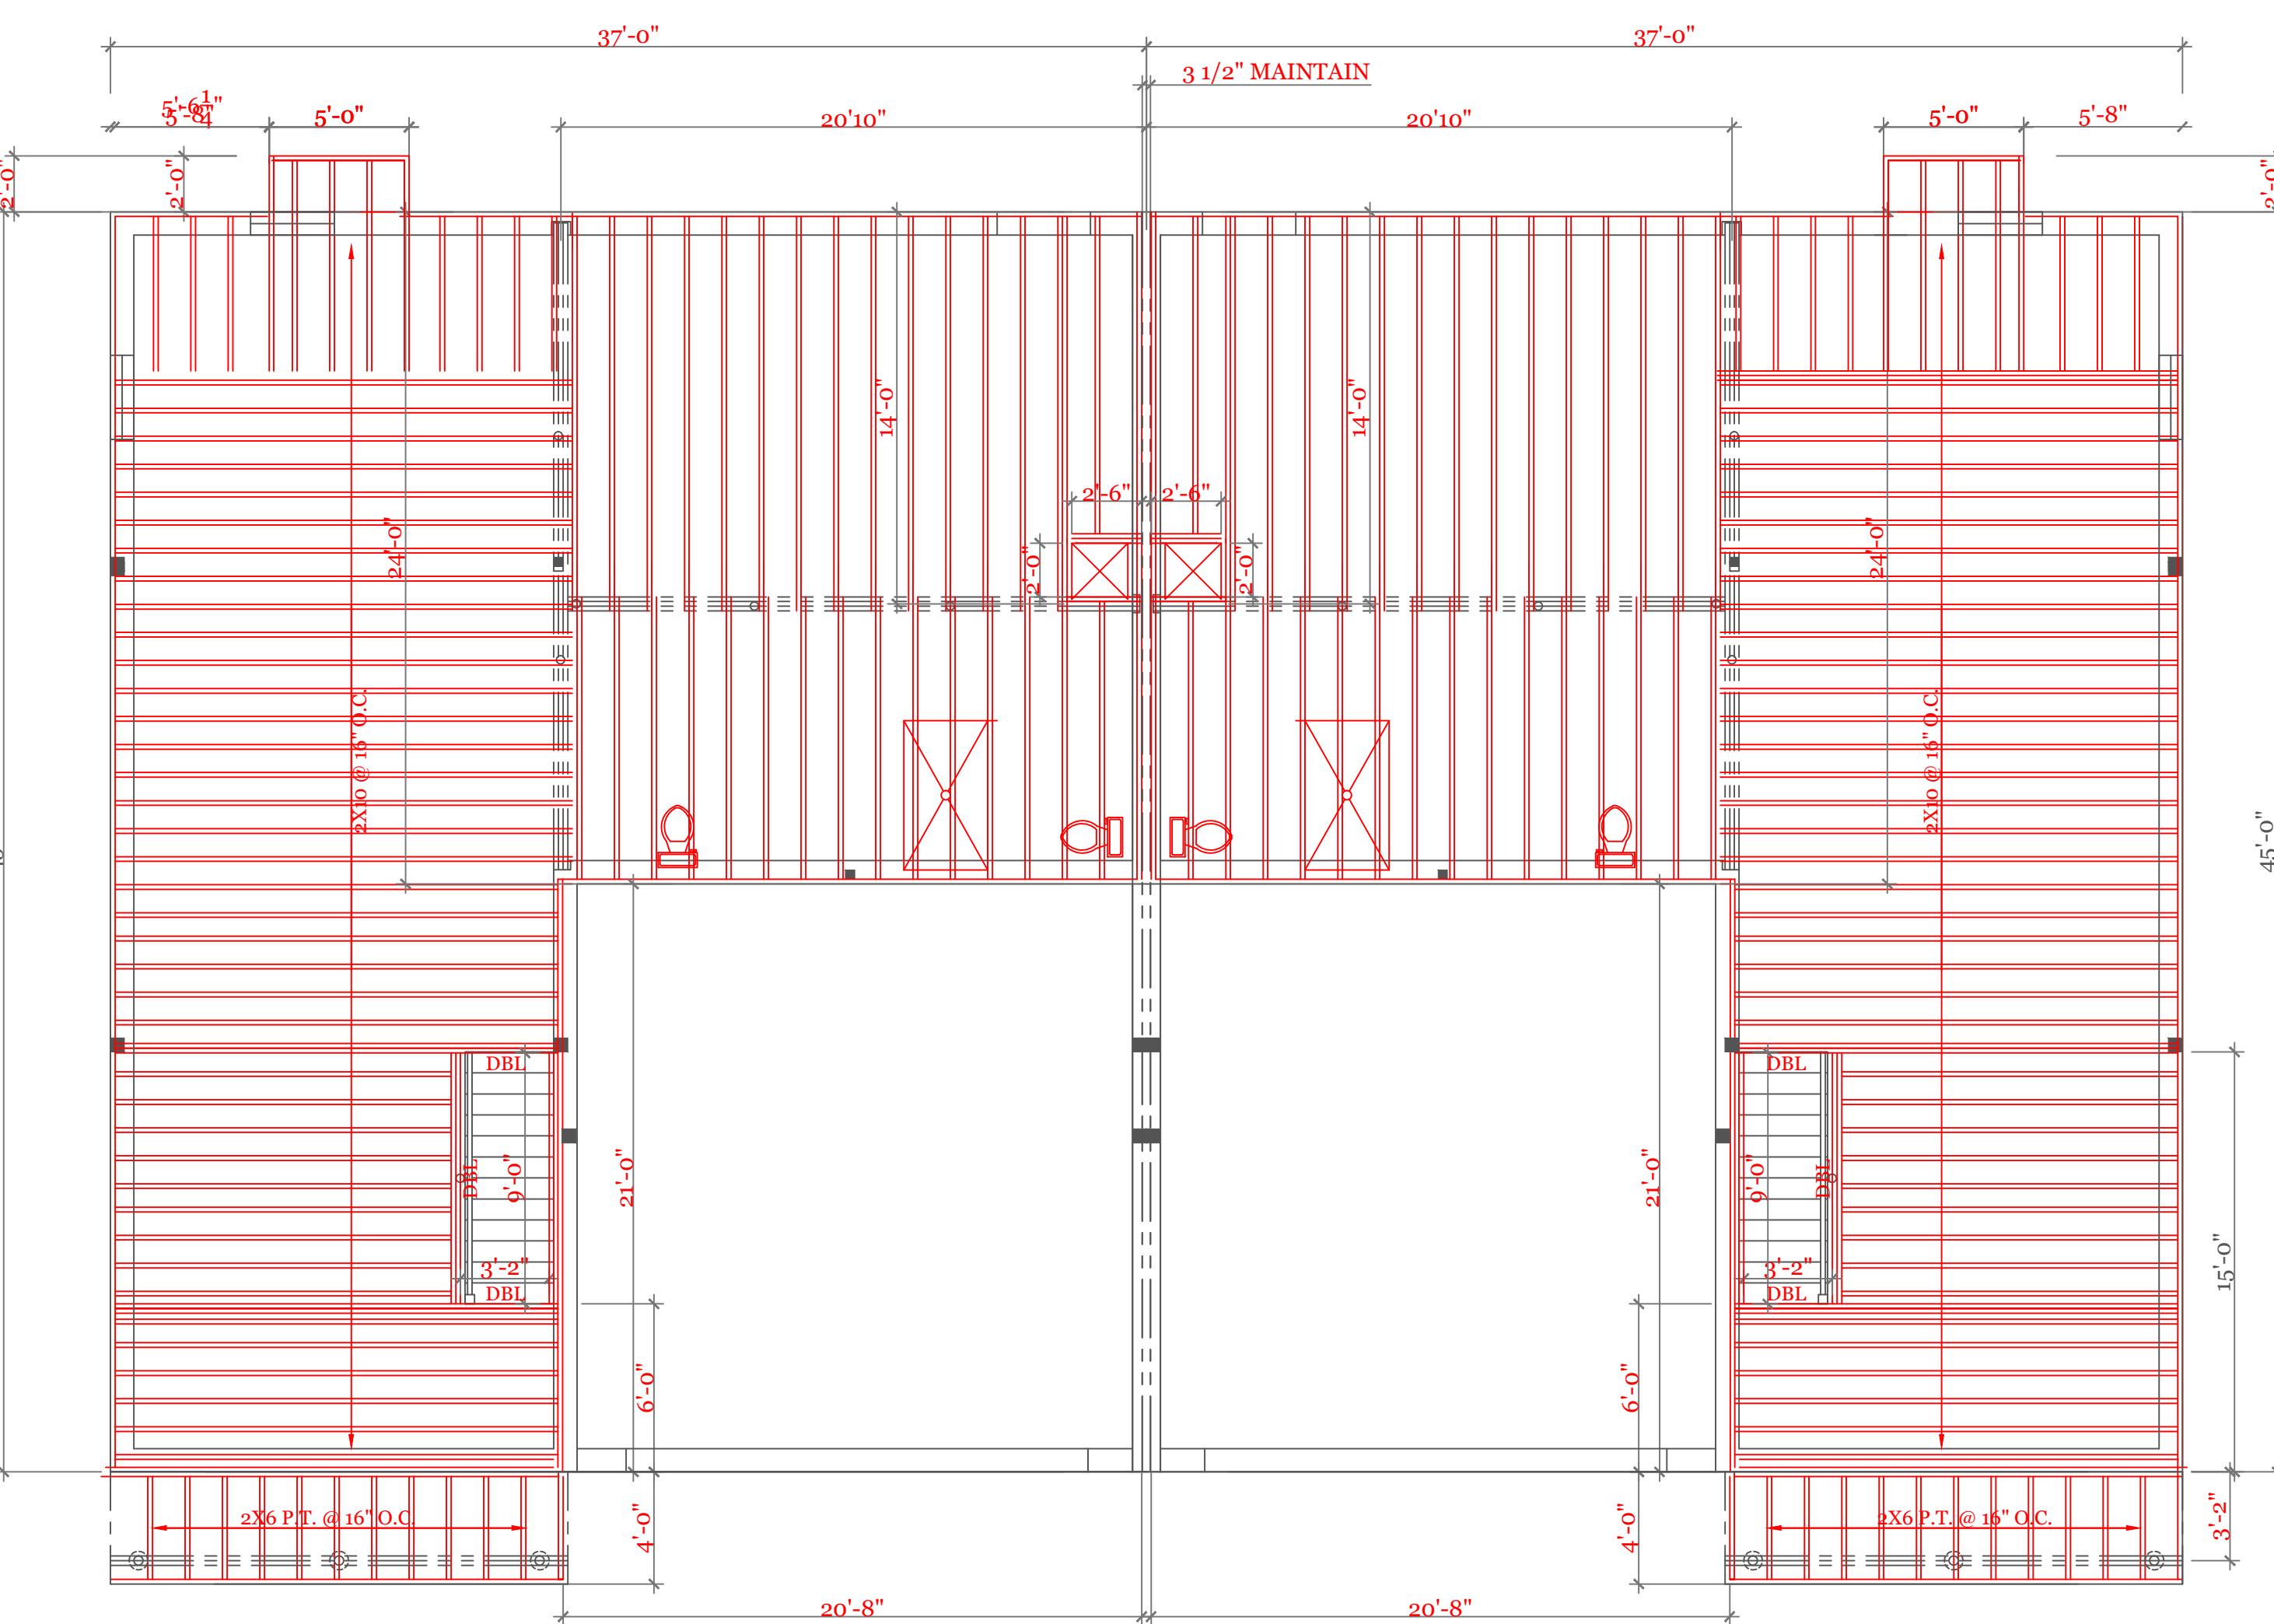

FIRST FLOOR FRAMING (2"X10"@16"O.C. UNLESS NOTED)
OPTION 2X12 @ 16" O.C.
■ BEARING POINTS BLOCKED TO FOUNDATION & BEAM SUPPORTS

BEAM CALCULATIONS						
BEAM	SIZE	SPAN	LIVE LOAD	TOTAL LOAD	MAX LIVE (PLF)	MAX TOTAL (PLF)
A	3 1/2" X 18" LVL	22'-0"	315	420	473	681
B	3 1/2" X 16" LVL	16'-0"	550	660	1296	1320
C	5 1/4" X 18" LVL	21'-0"	800	960	1065	1298

NOTES:

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WORCESTER, MA
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**UNIT 'A'
HIGGINS FARM AT
SALISBURY HILL**
**FIRST & SECOND FLOOR
FRAMING PLANS
BEAM SCHEDULE**

DATE: 9/20/2022 R5/5/23

SCALE: 3/16" = 1'-0"


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CHECKED BY: MJB


Sheet 7 OF 8

7

NOTES:

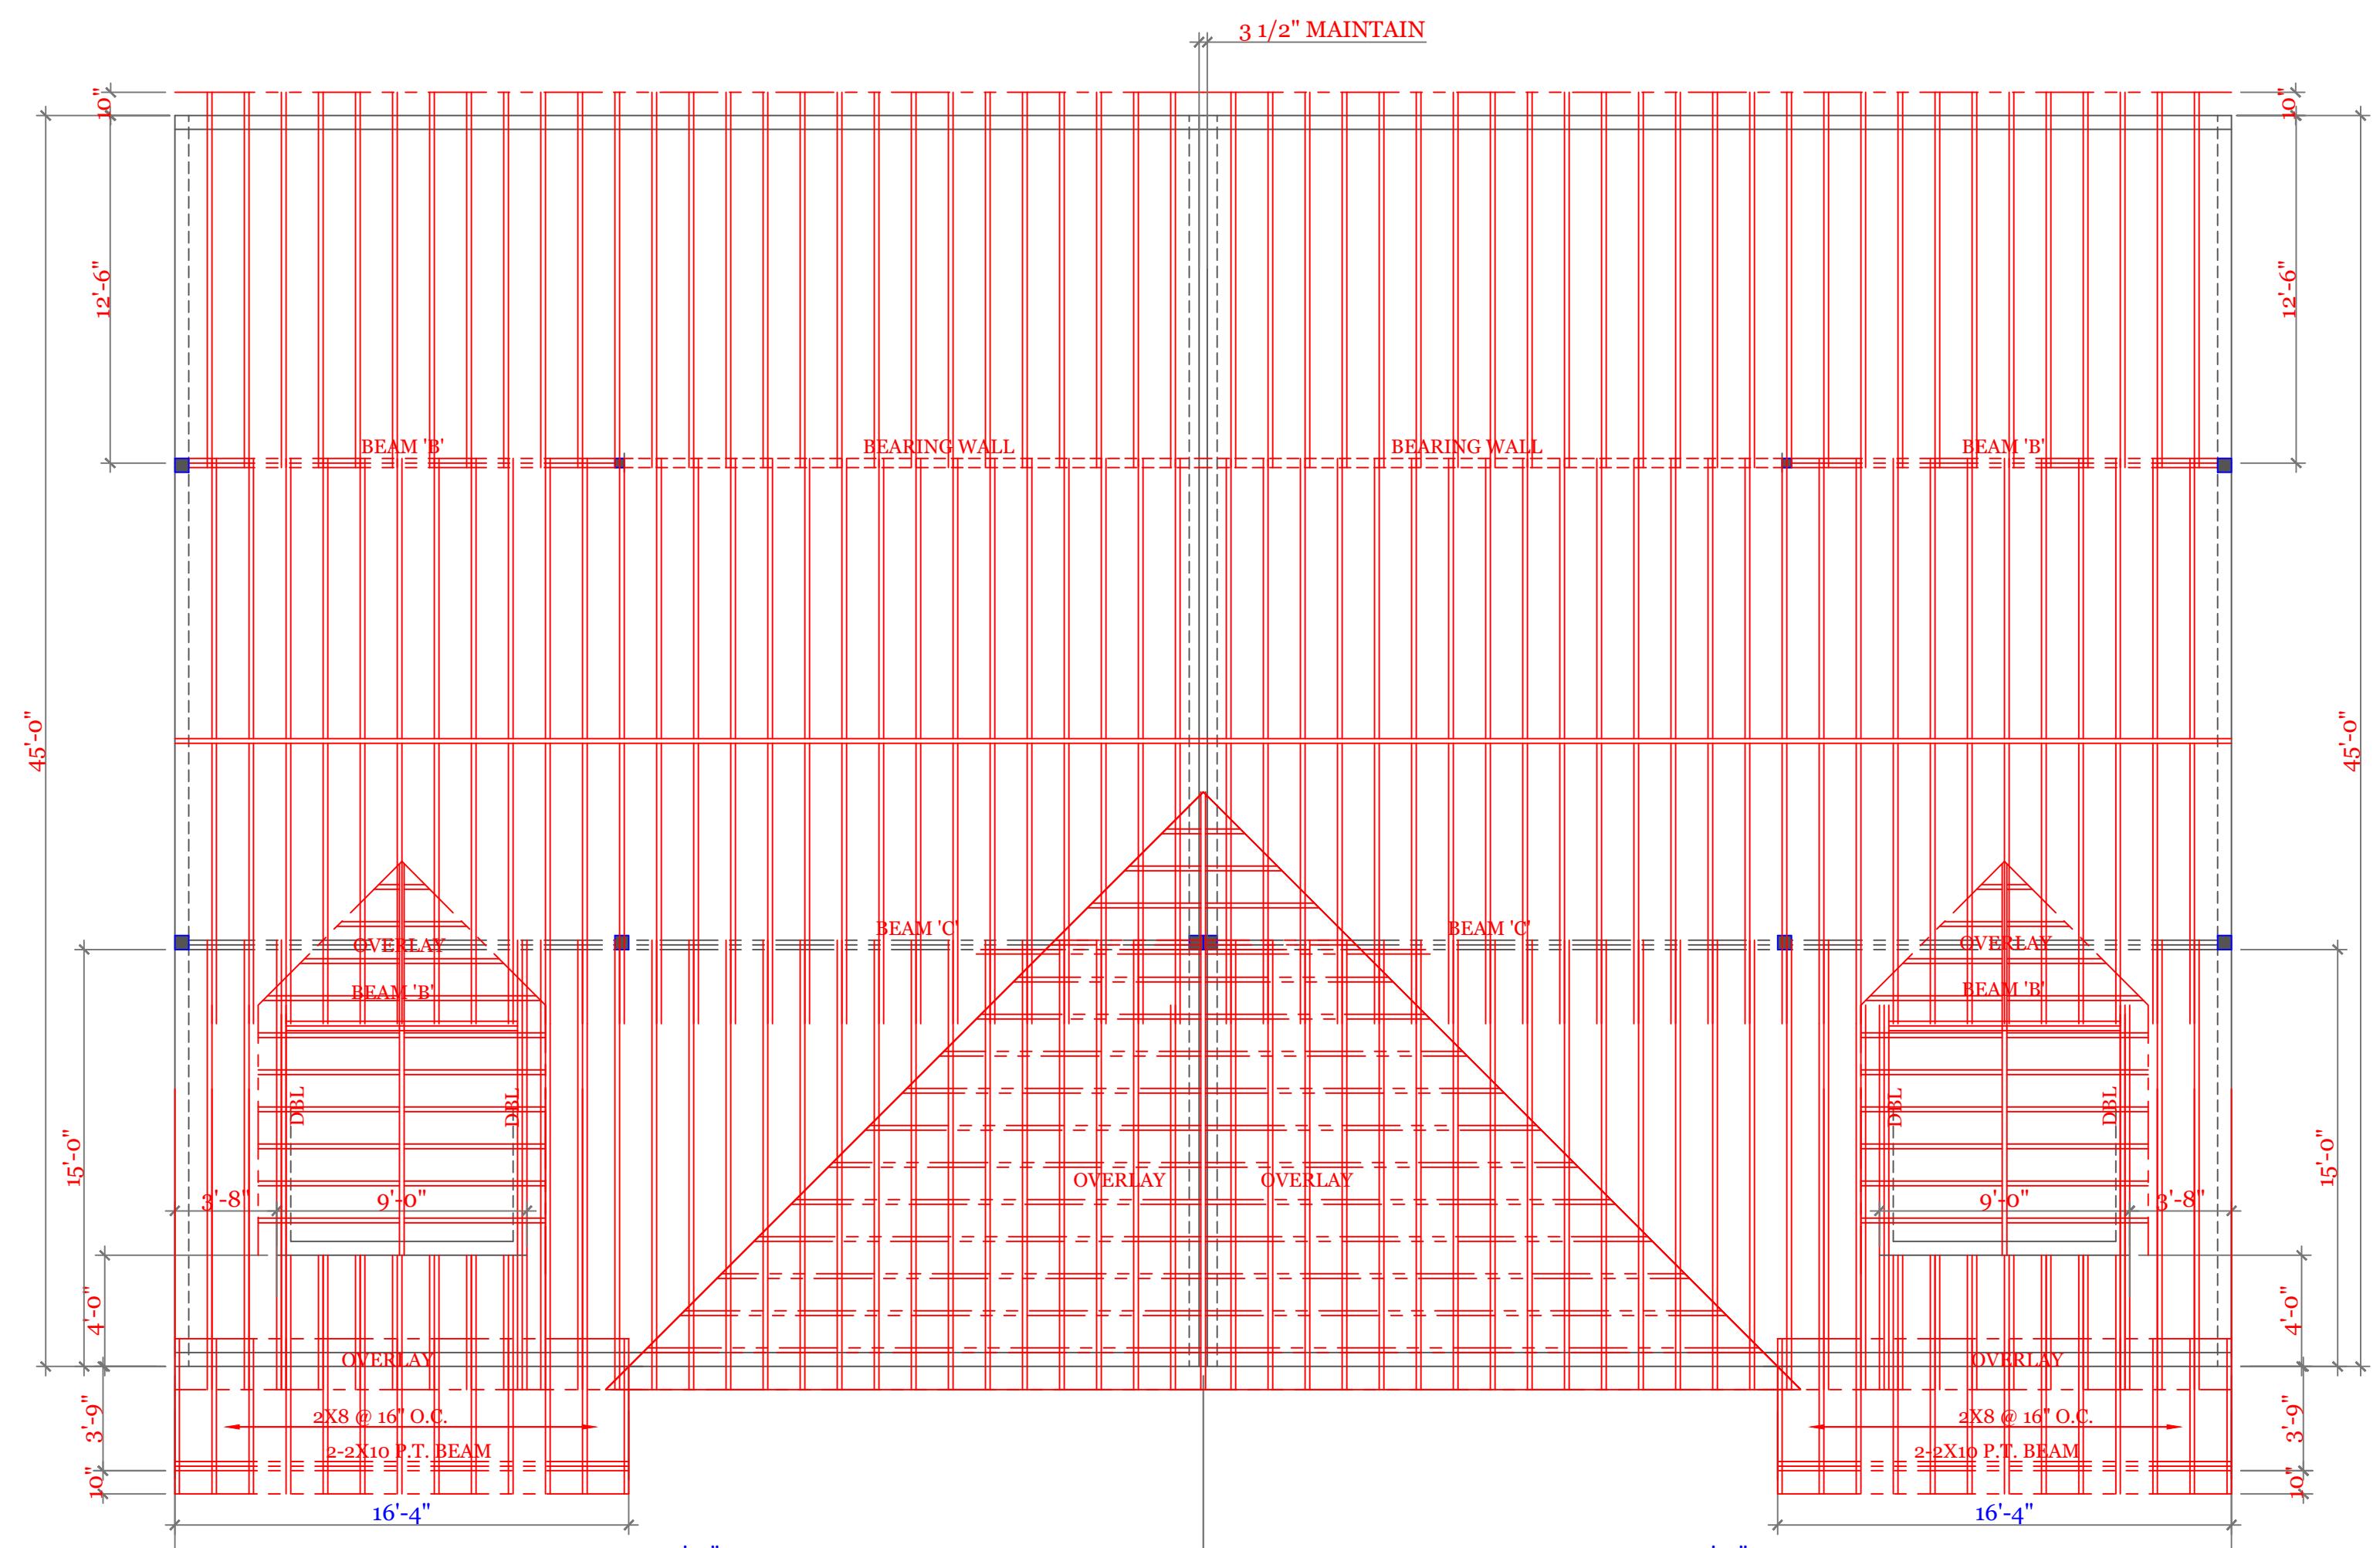

BEAM CALCULATIONS						
BEAM	SIZE	SPAN	LIVE LOAD	TOTAL LOAD	MAX LIVE (PLF)	MAX TOTAL (PLF)
A	3 1/2" X 18" LVL	22'-0"	315	420	473	681
B	3 1/2" X 16" LVL	16'-0"	550	660	1296	1320
C	5 1/4" X 18" LVL	21'-0"	800	960	1065	1298

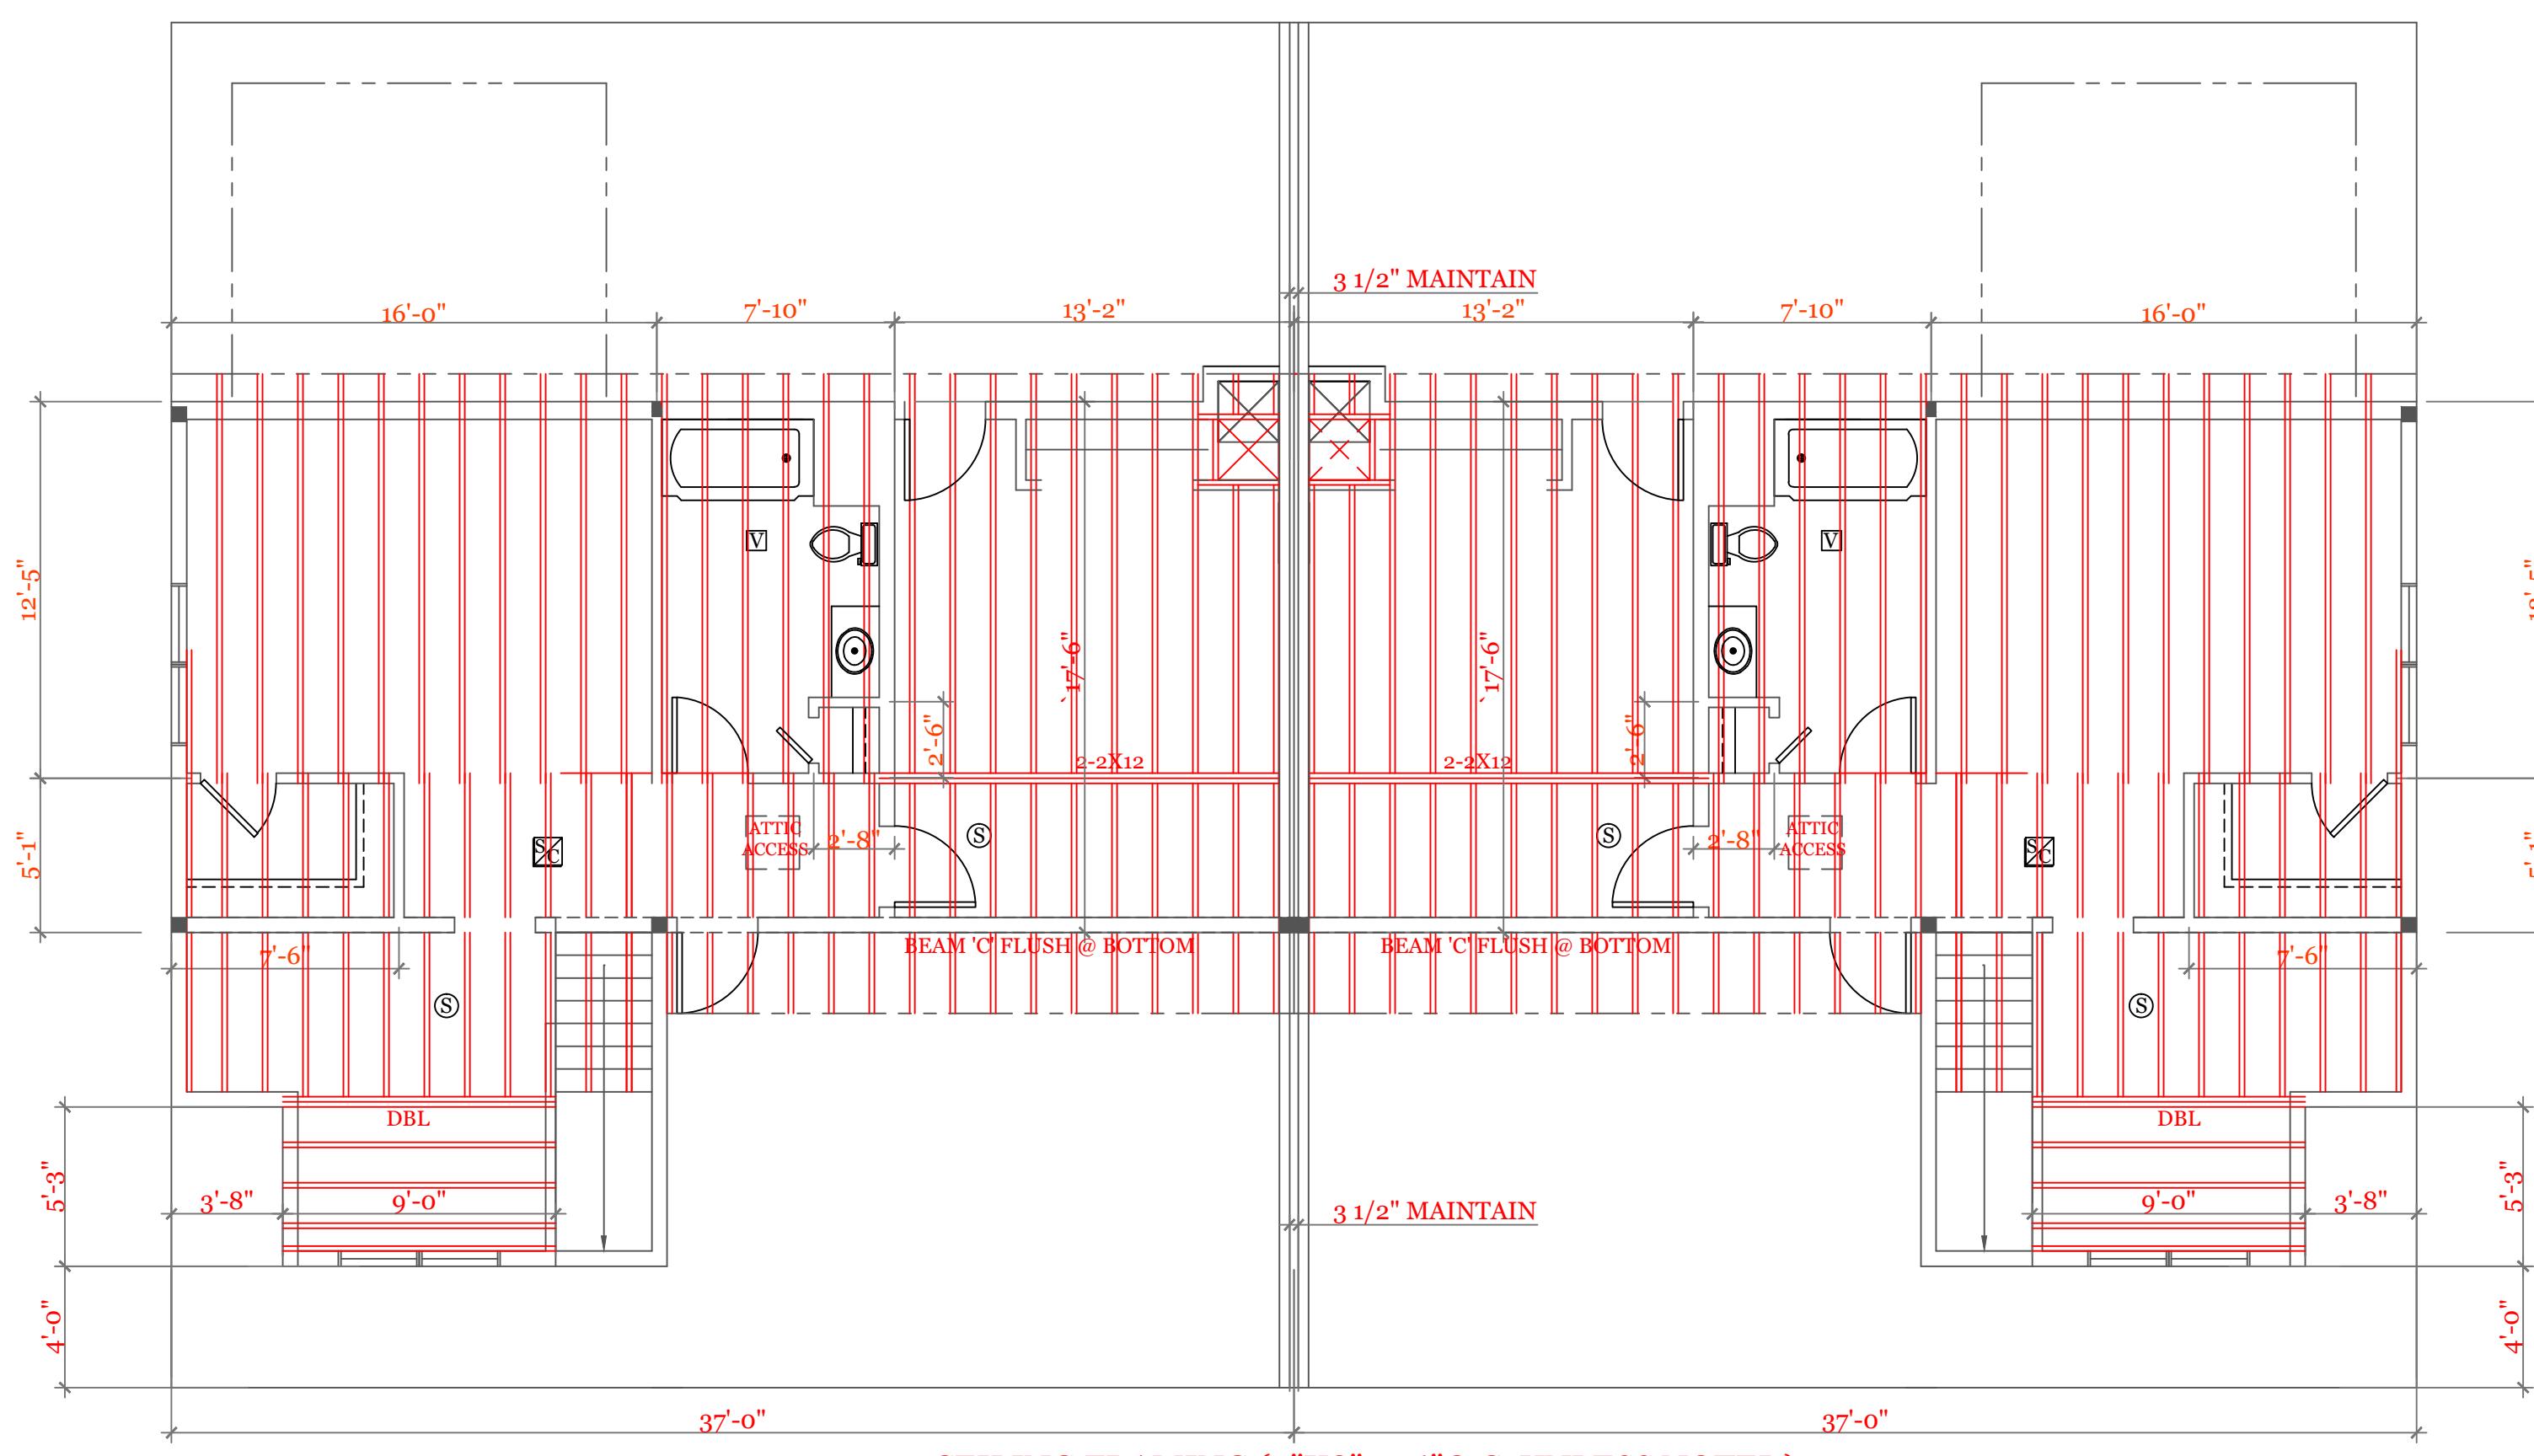

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WORCESTER, MA
(508)450-3461

UNIT 'A' DUPLEX
HIGGINS FARM AT
SALISBURY HILL

CEILING & ROOF
FRAMING PLANS
BEAM SCHEDULE

DATE: 9/20/2022 R5/5/23


SCALE: 3/16" = 1'-0"

DRAWN BY: RCS

CHECKED BY: MJB


Sheet 8 OF 8

8

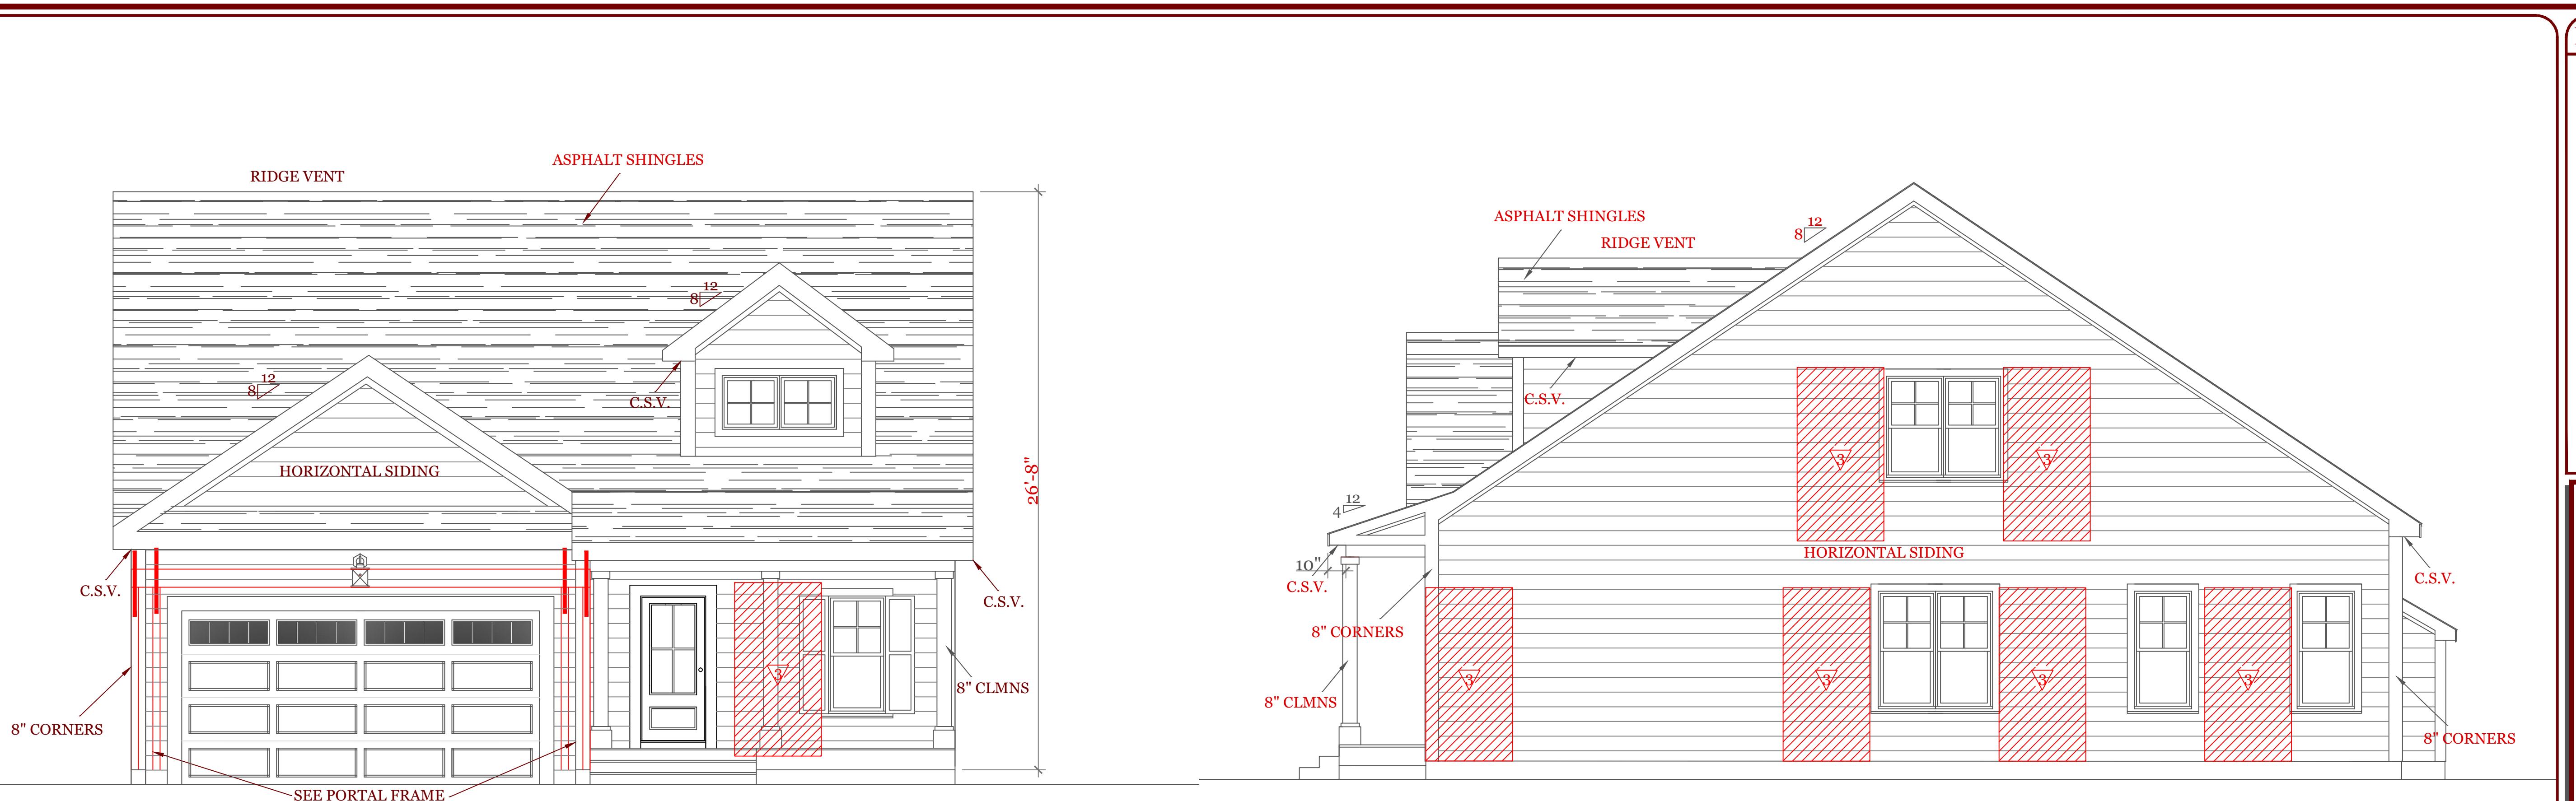


FRONT ELEVATION (1799 s.f.)


3/4" WOOD STRUCTURAL PANEL 15/32 CDX PLY WD. SHEATHING ON 16" STUD SPACING PANELS INSTALLED VERTICALLY
W/ 6d COMMON NAIL 6" O.C. @ EDGES & 12" O.C. INTERMEDIATE SUPPORTS

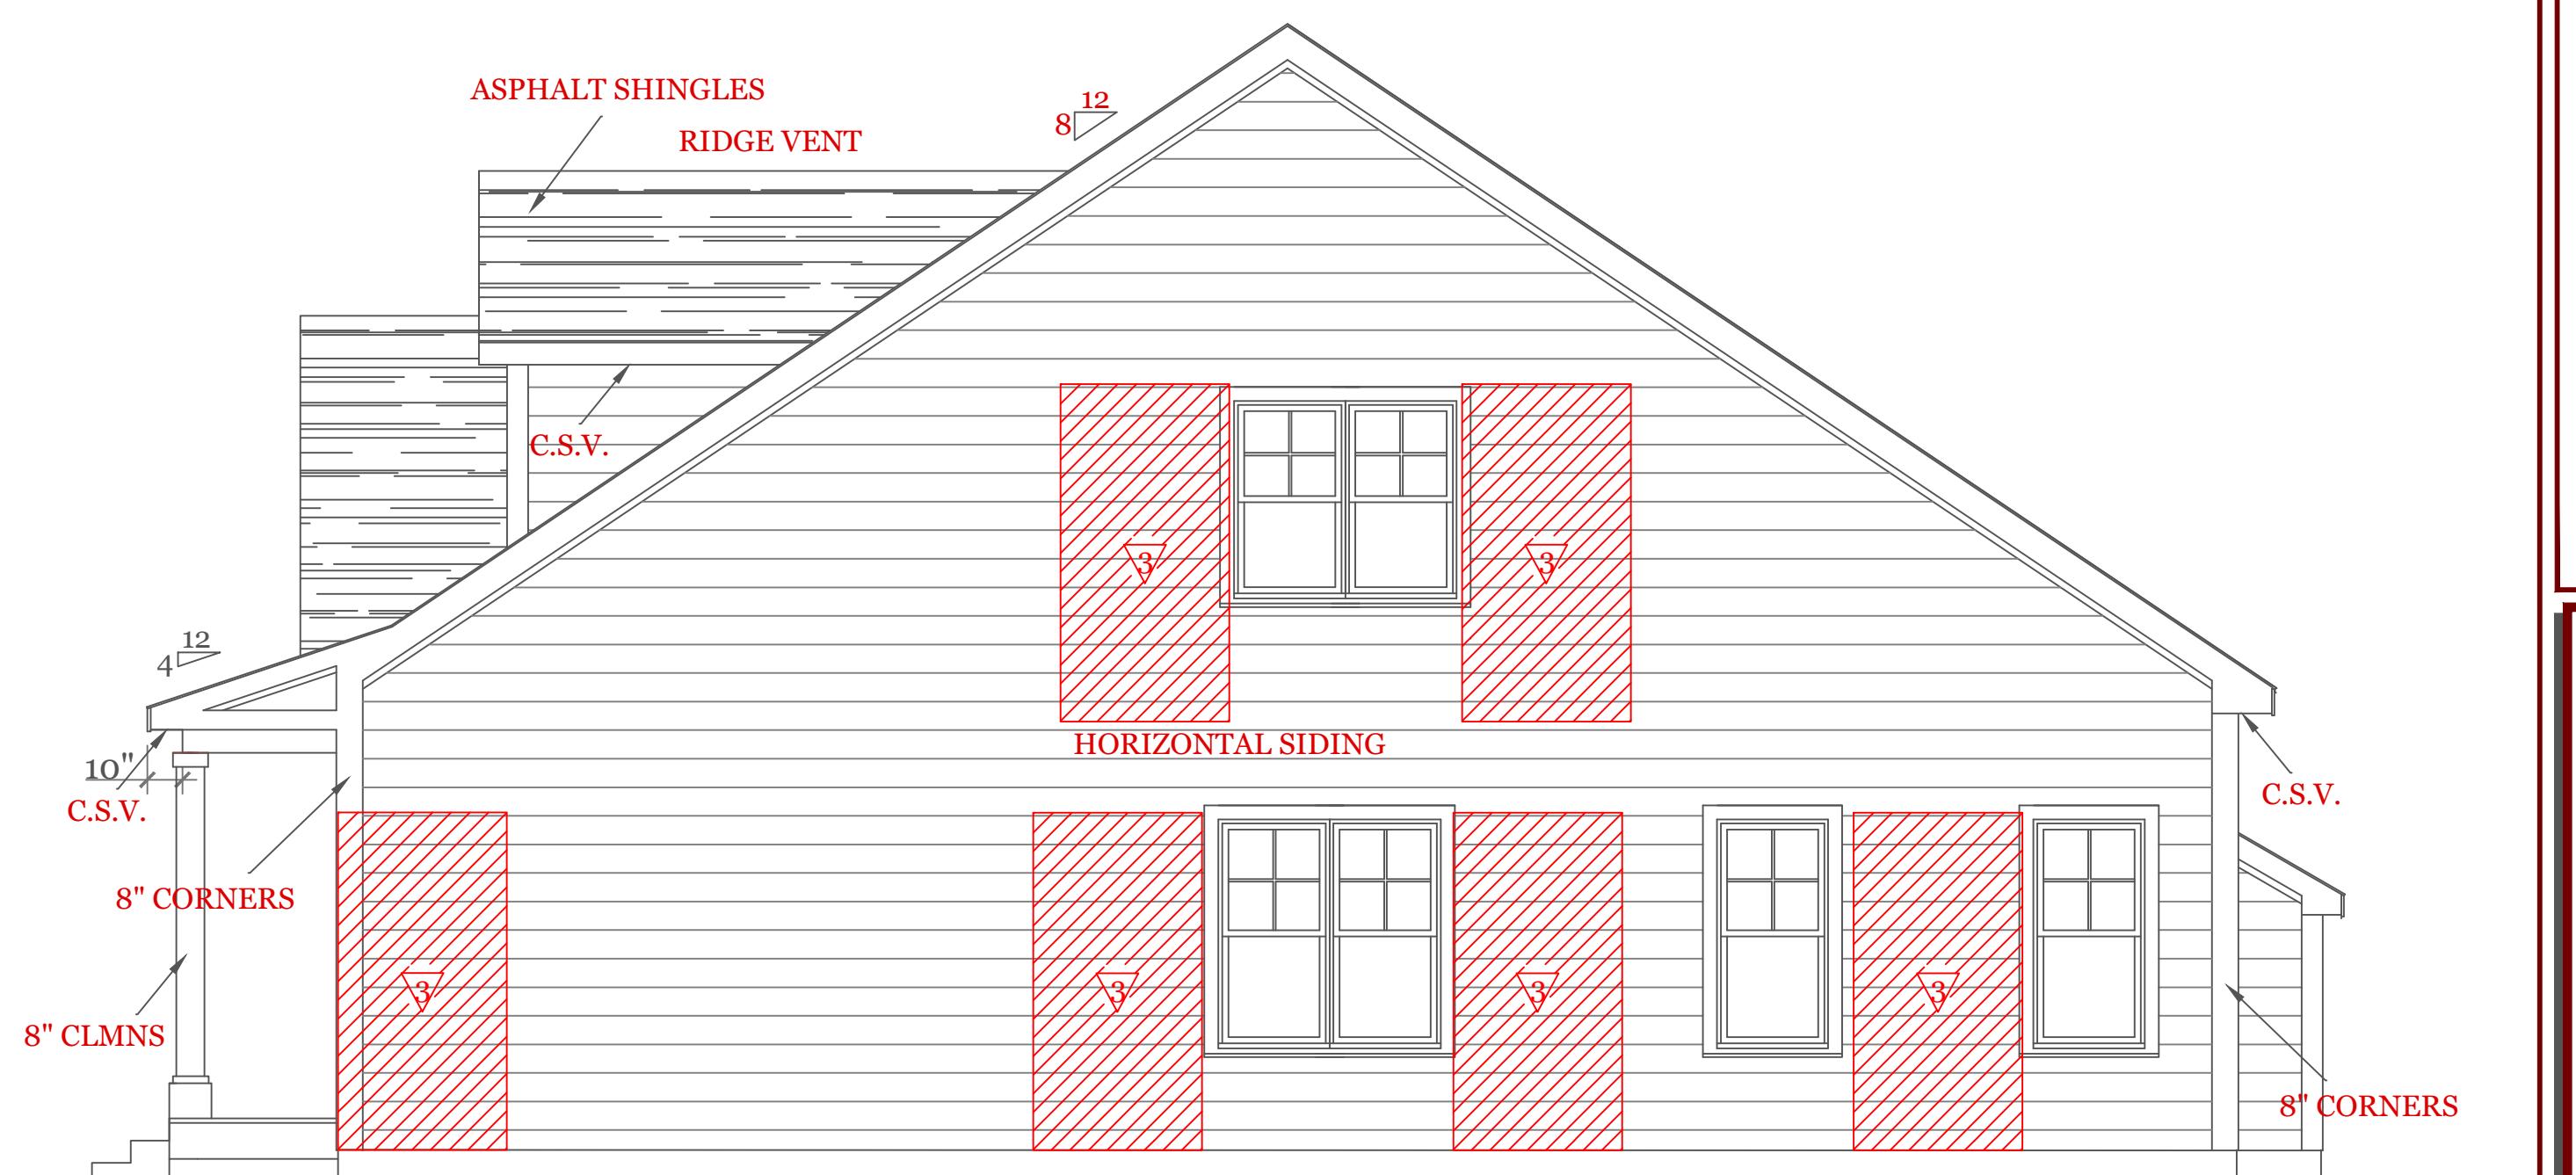

RIGHT SIDE ELEVATION

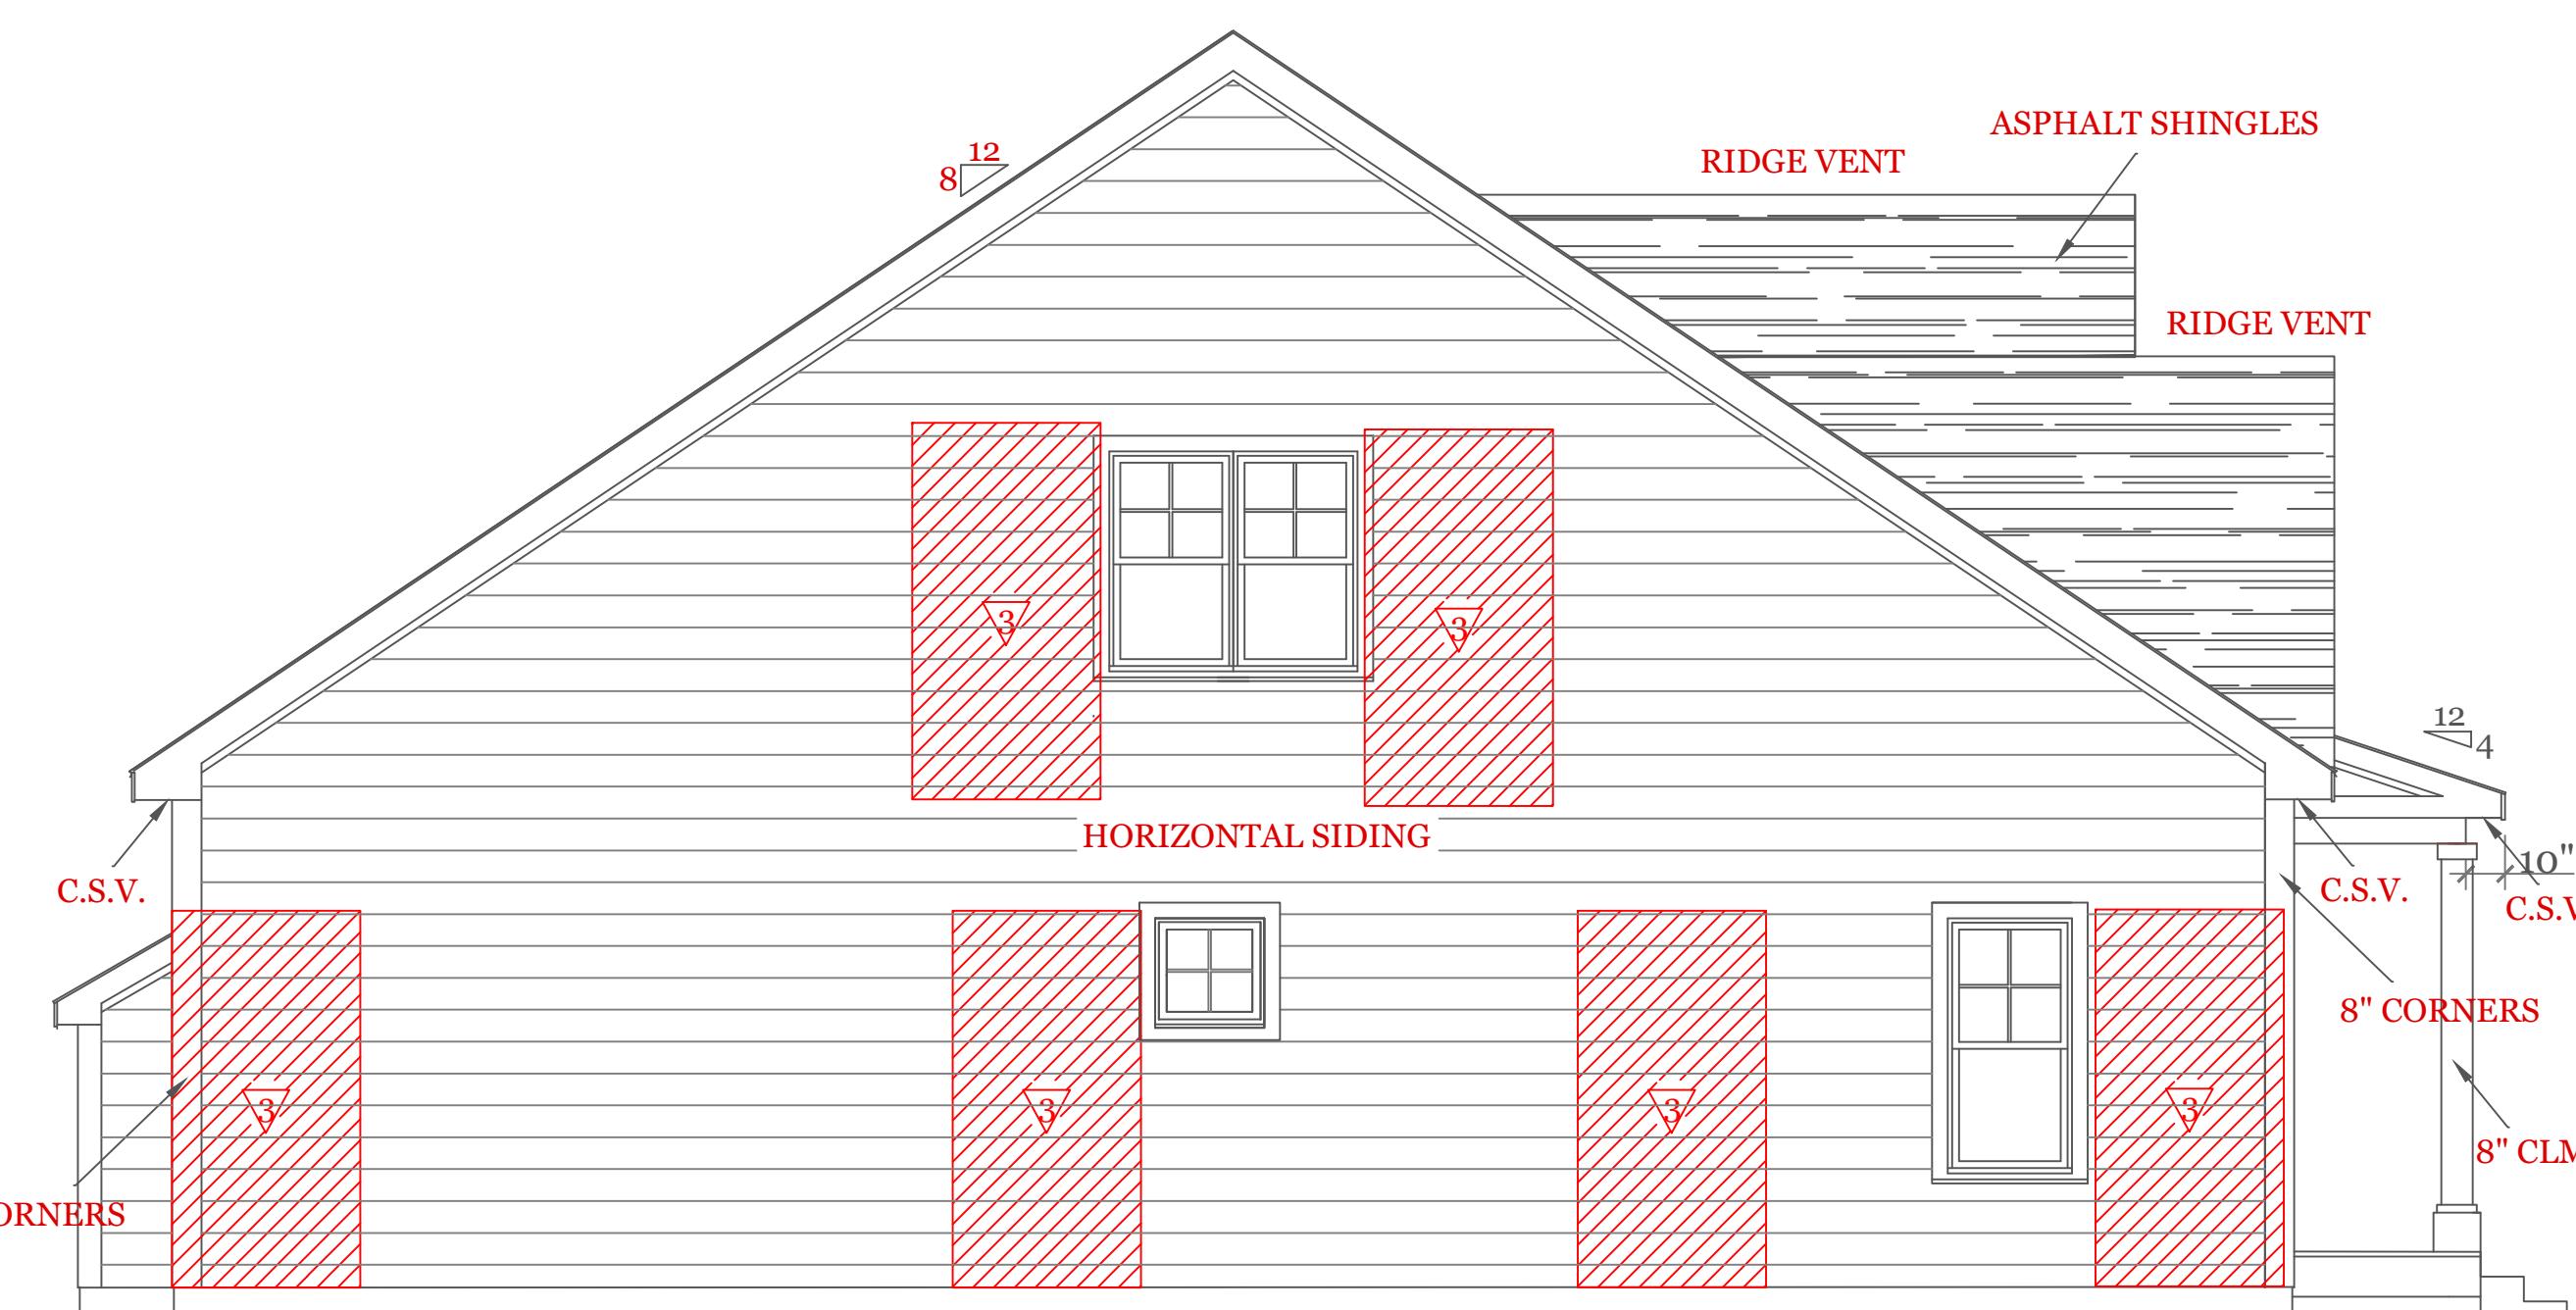

LEFT SIDE ELEVATION

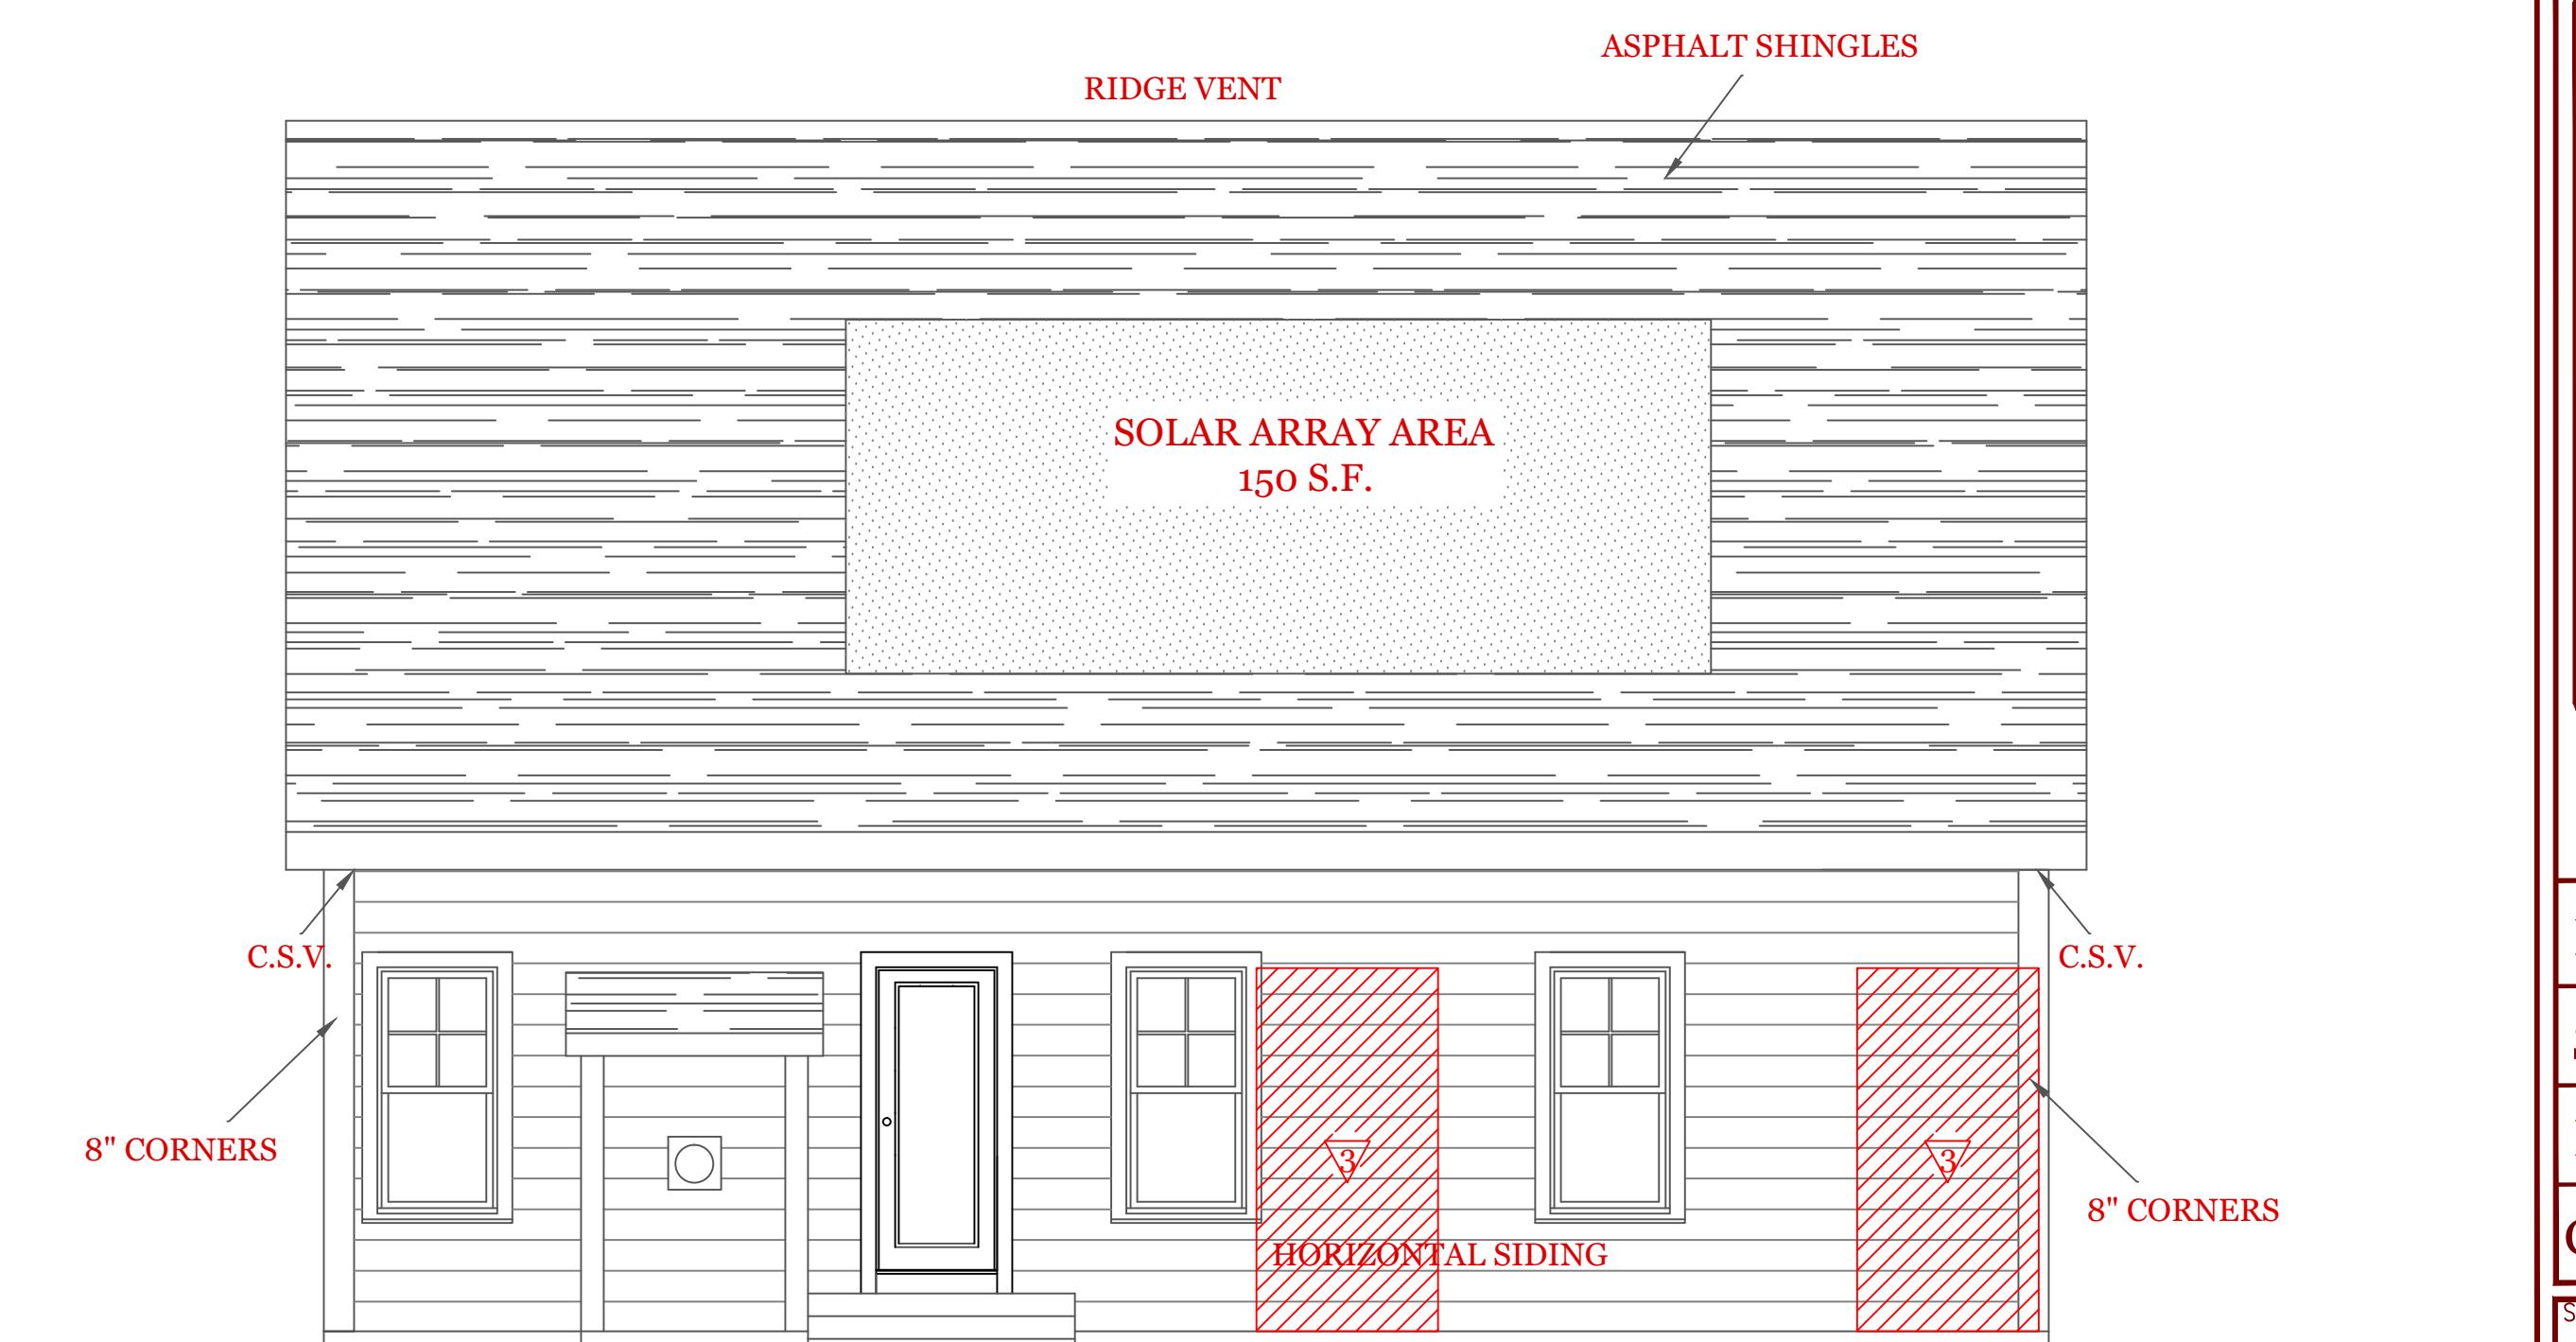

REAR ELEVATION

NOTES:

GENERAL NOTES:

1. These plans are drawn as required for construction by an experienced licensed general contractor.
2. The General contractor shall fully comply with the 9TH Edition of the Massachusetts State Building Code, IRC2015 and all additional local requirements.
3. Written dimensions shall have precedence over scaled dimensions. The general contractor shall verify and is responsible for all dimensions (including rough openings) and conditions on the job and must notify this office of any variations from these drawings. Any defects in the construction documents shall be brought to the attention of this office before proceeding with work. Reasonable time not allowed this office to correct defects shall place the burden of cost and liability from such defects upon the contractor.

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**UNIT A - 1676 S.F.
HIGGINS FARM AT
SALISBURY HILL**



ELEVATION & FLOOR PLANS

UNIT 'A' GL

DATE: 9/20/22 R-5/5/23
SCALE: 1/4"=1'-0"
DRAWN BY: RCS
CHECKED BY: MJB

heet 1 OF 5

1

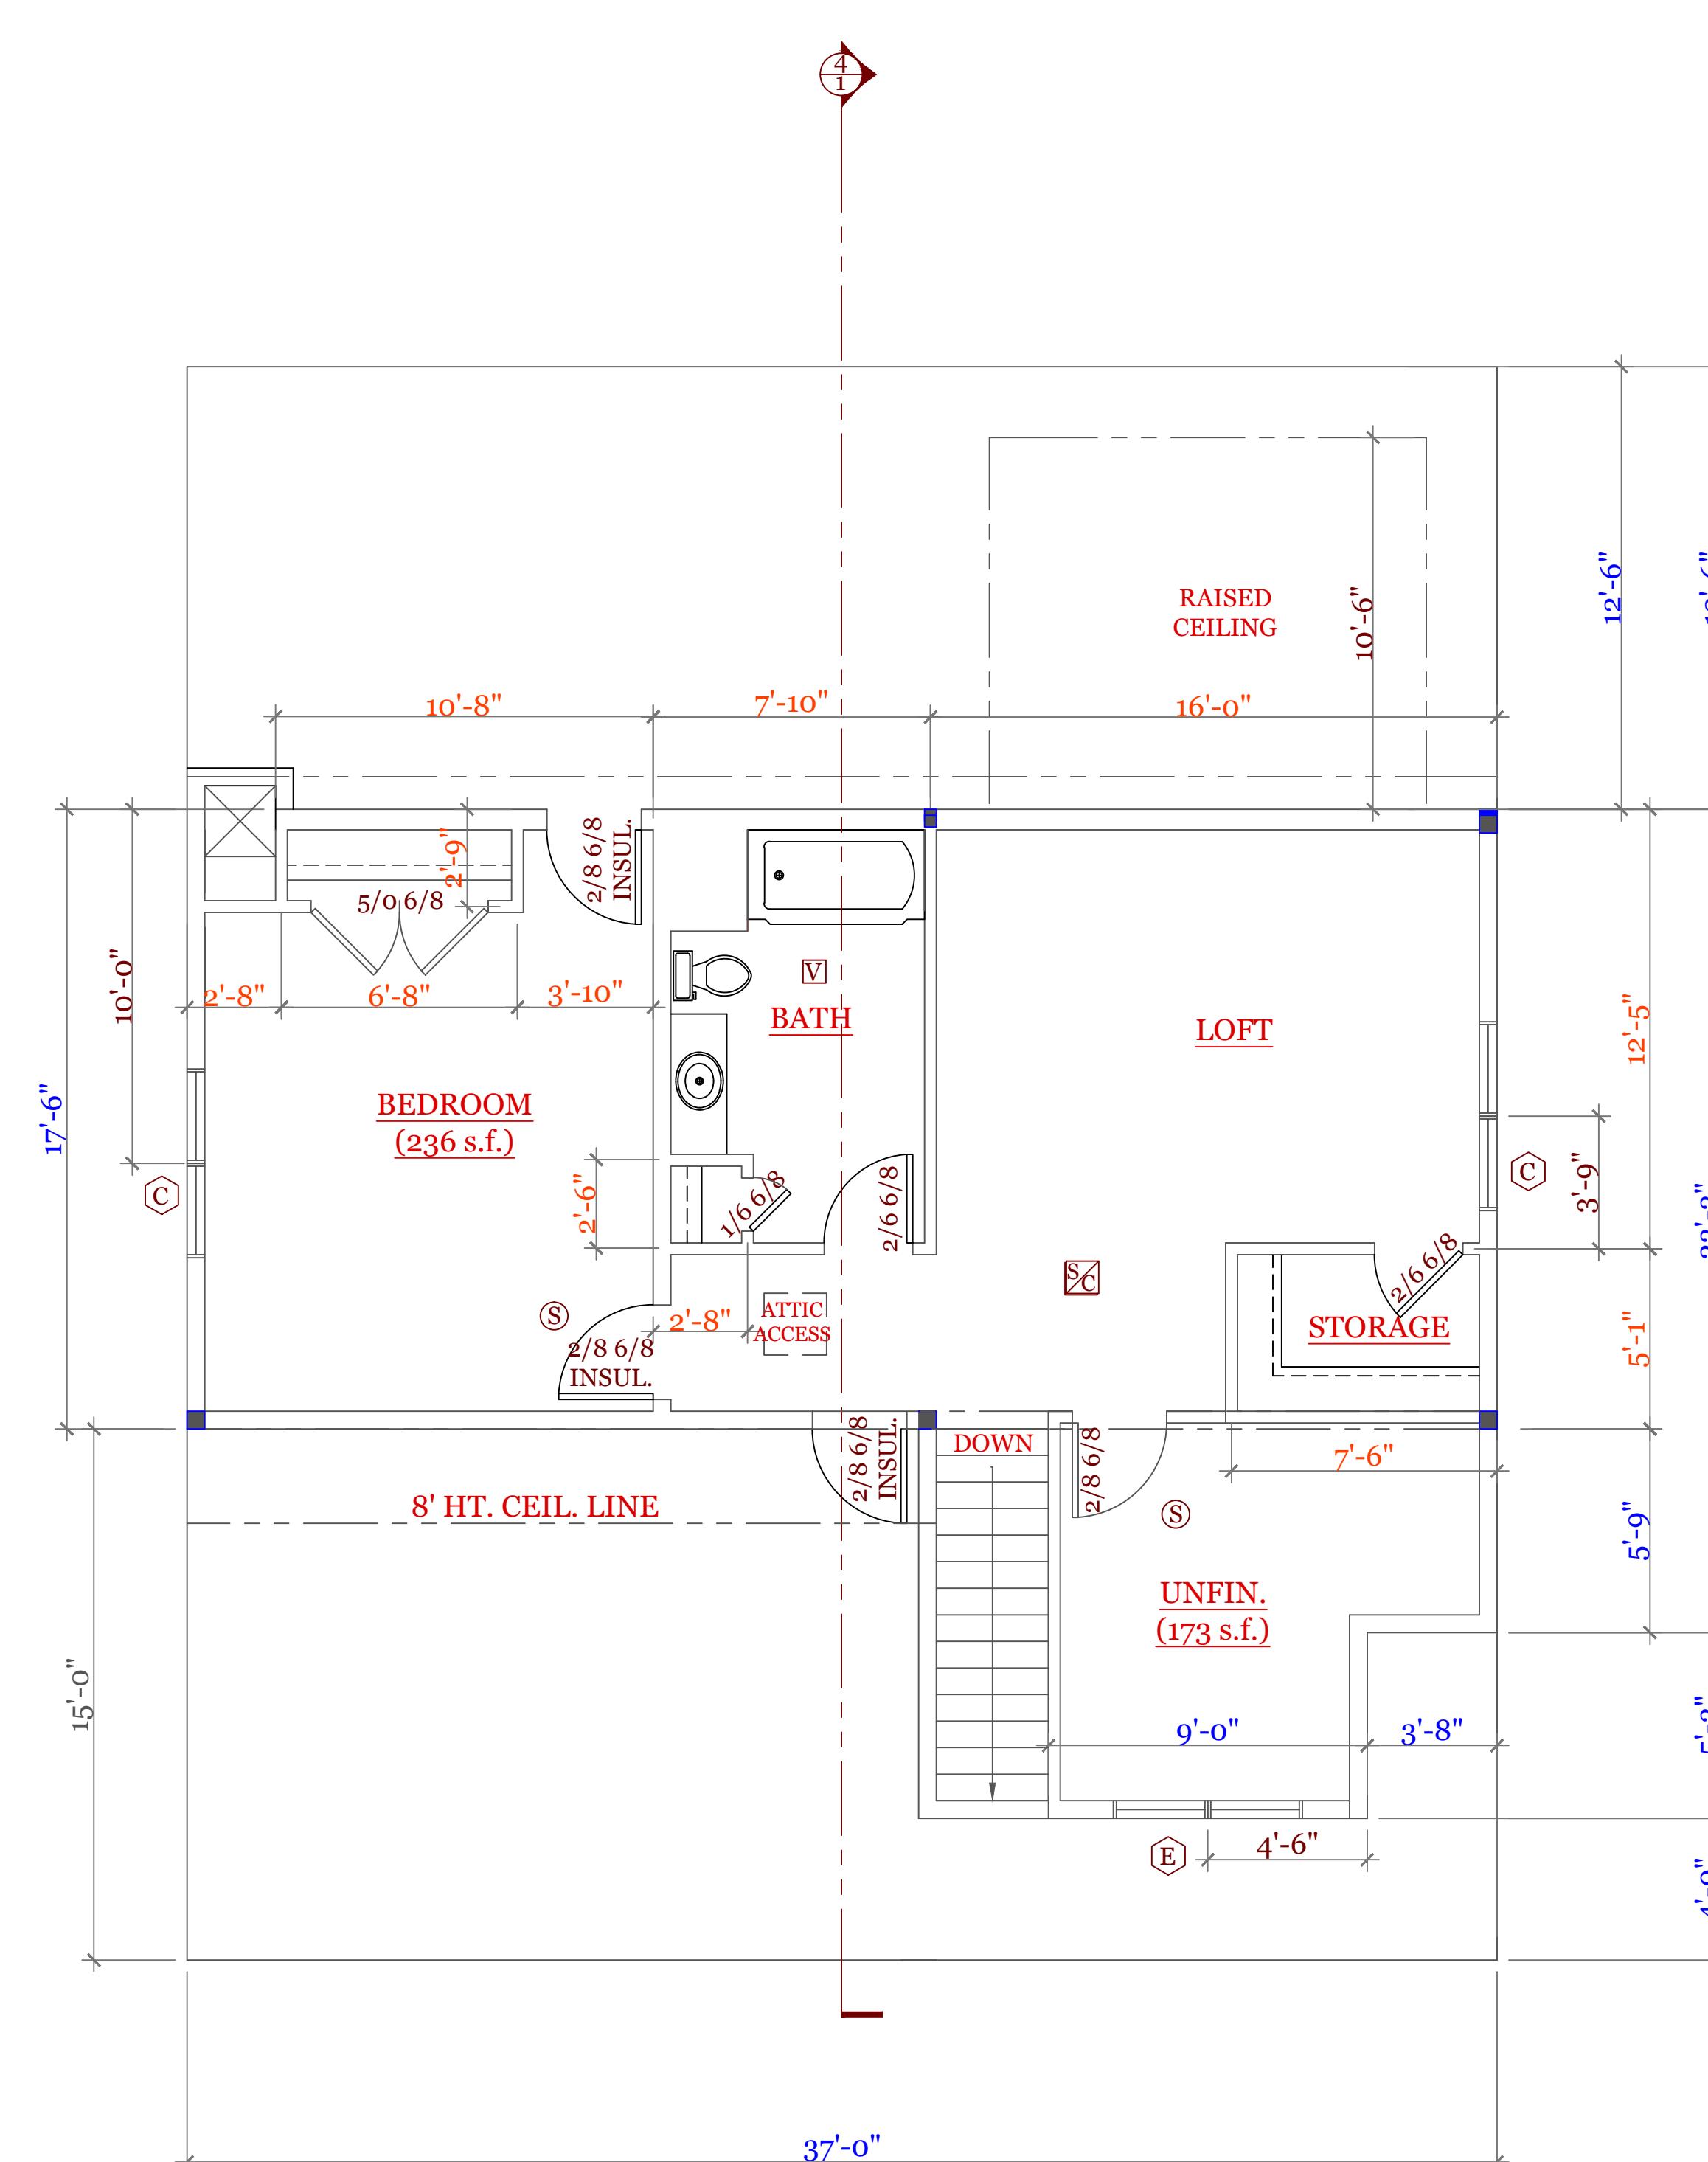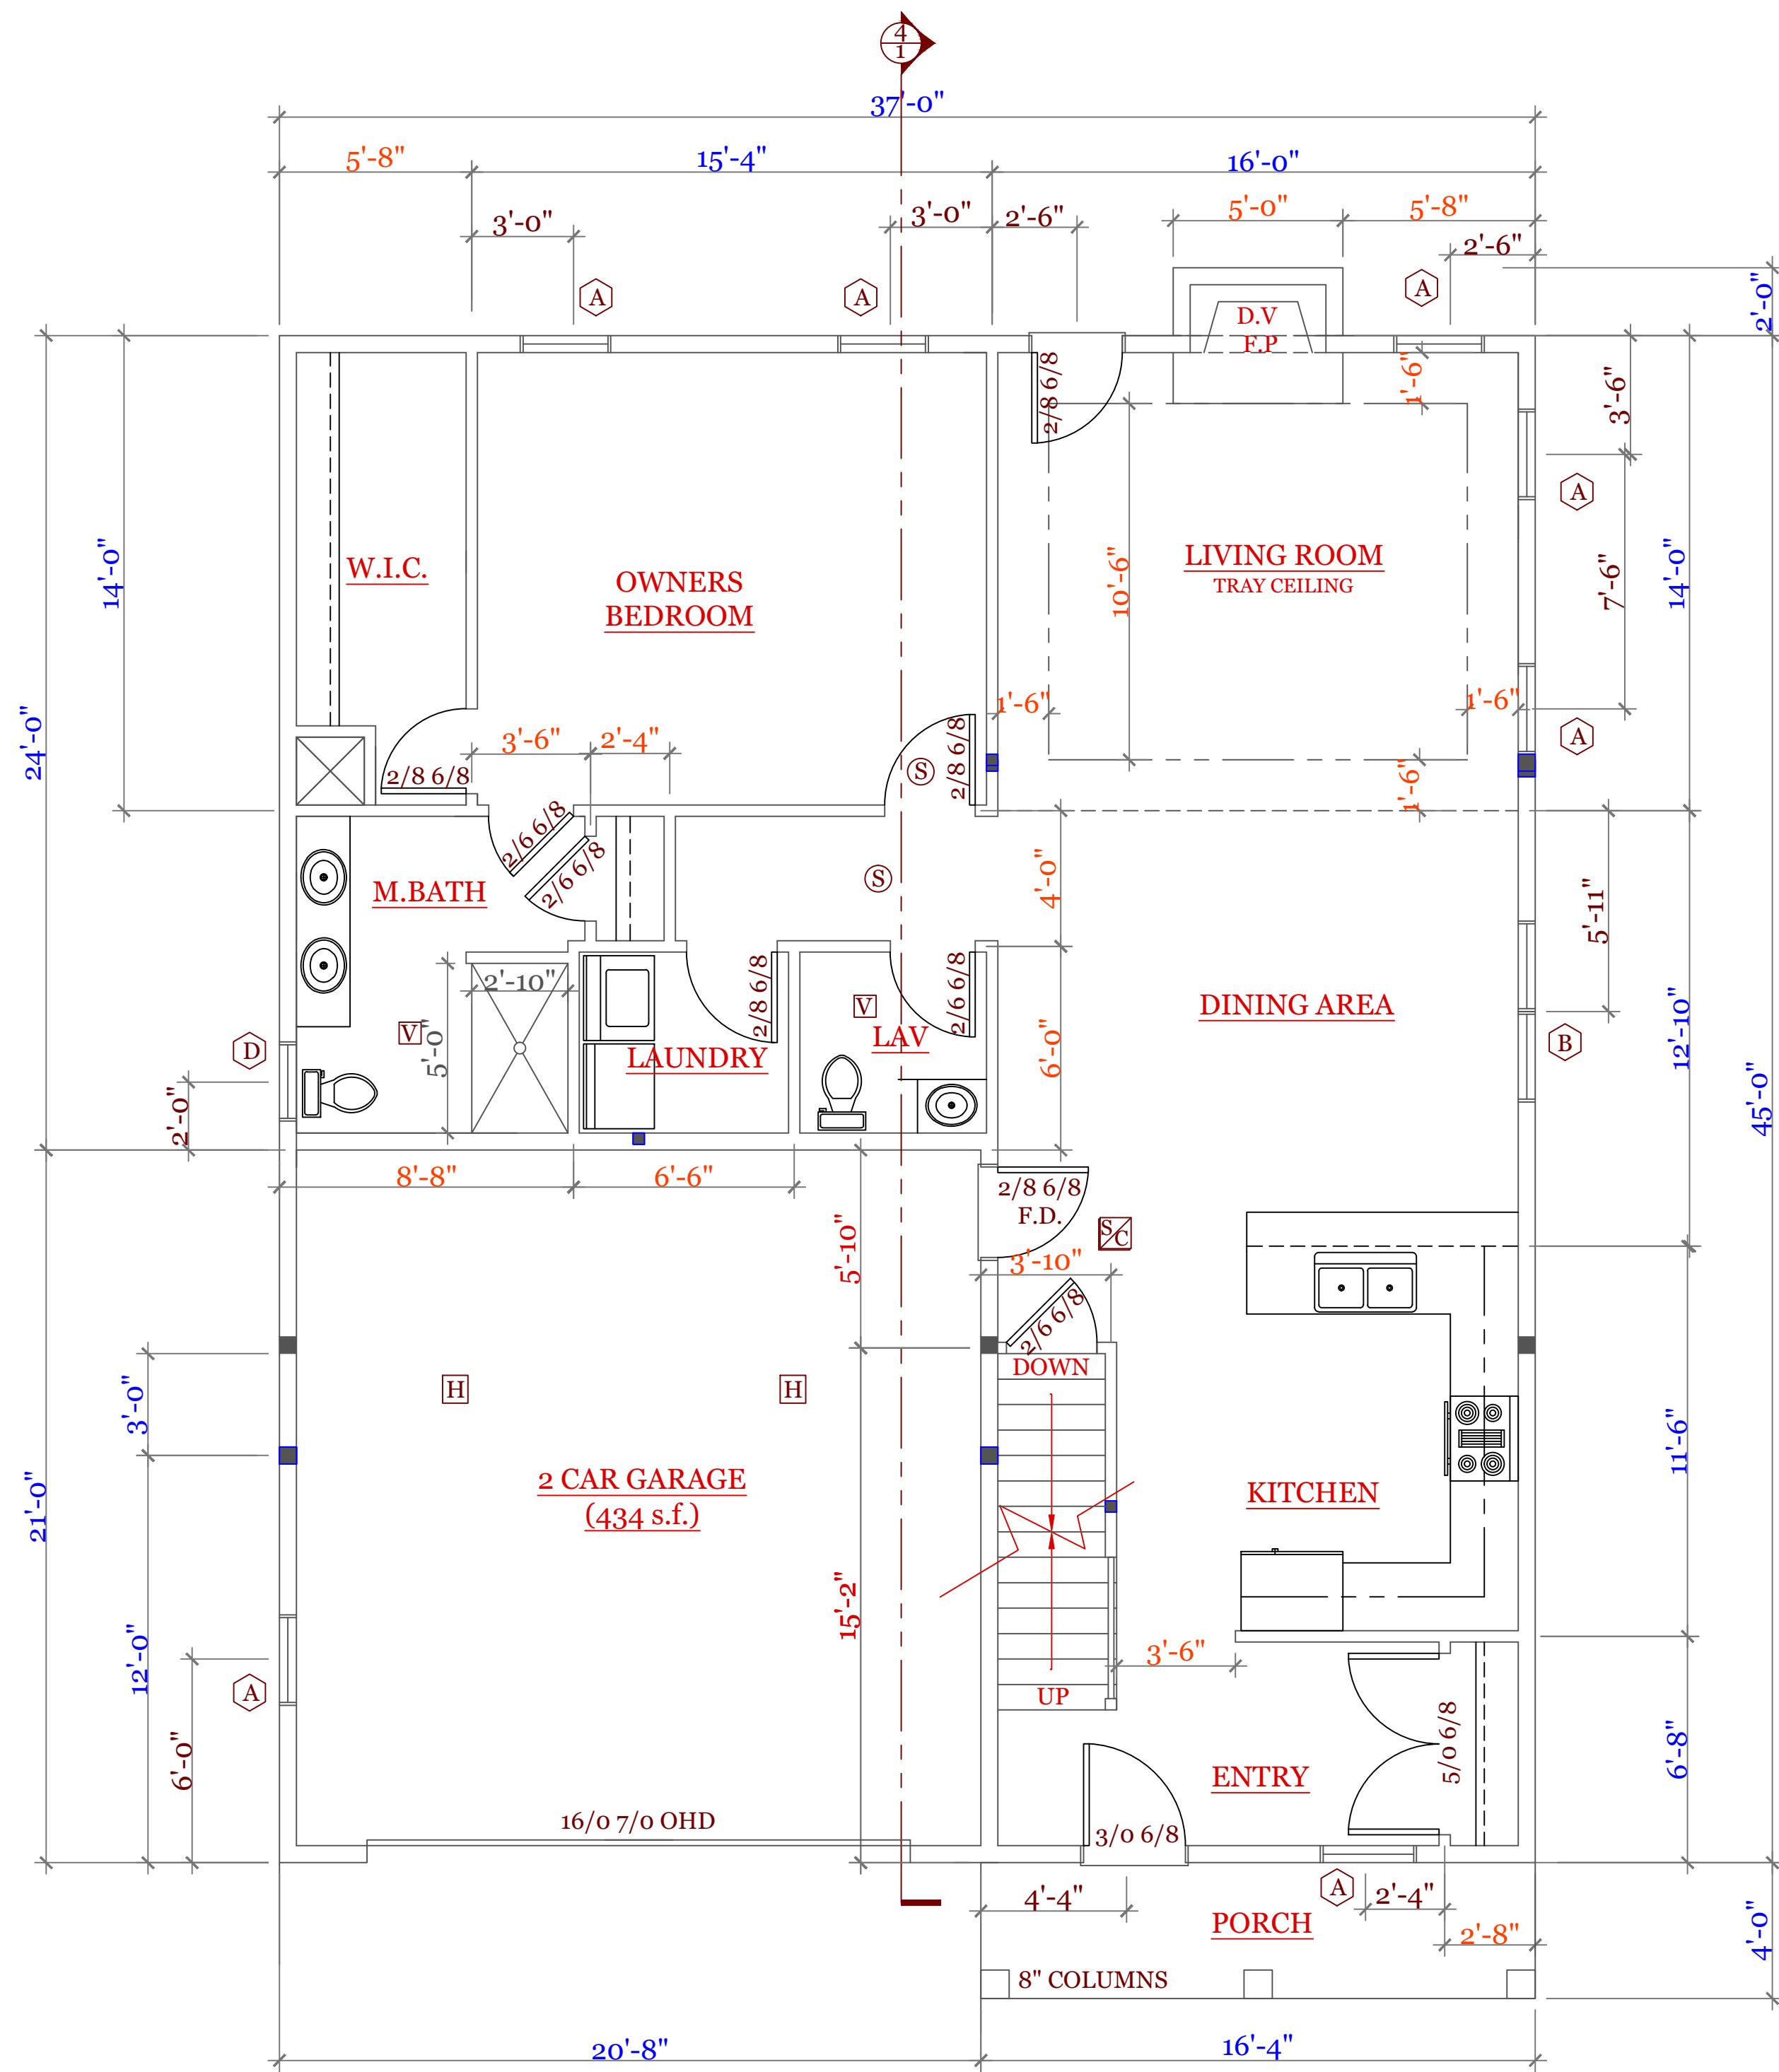

WINDOW & EXTERIOR DOOR SCHEDULE: HARVEY			
INDEX	QUA	CATALOG	ROUGH OPENING
A	7	10000-1	2'-8 1/4" X 5'-6 1/4"
B	1	11000-1	5'-4 3/4" X 5'-6 1/4"
C	2	12000-1	5'-4 1/2" X 4'-9 1/4"
D*	1	13000-1 (T)	2'-8 1/8" X 2'-8 1/8"
E	1	A2281	5'-3 1/4" X 2'-0 5/8"
F	1	15000-1	5'-4 1/2" X 6'-10 1/2"
G	1	16000-1	3'-2 1/2" X 6'-10 1/2"

NOTES: CONSULT TABLE 603.7(1) JACKS & HEADERS
*D WINDOW TEMPERED IN BATH

NOTES:

SYMBOL SCHEDULE:
 V VENT
 SC SMOKE AND CARBON DETECTOR
 S SMOKE DETECTOR
 H HEAT DETECTOR
 B BEARING POINT W/ SQUASH BLOCK

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UNIT 'A'
HIGGINS FARM AT
SALISBURY HILL
FIRST & SECOND
FLOOR PLAN
WINDOW SCHEDULE




UNIT 'A' GL

DATE: 9/20/22 R-5/5/23
SCALE: 1/4"=1'-0"
DRAWN BY: RCS
CHECKED BY: MJB

Sheet 3 OF 5

3


TYPICAL BUILDING SECTION

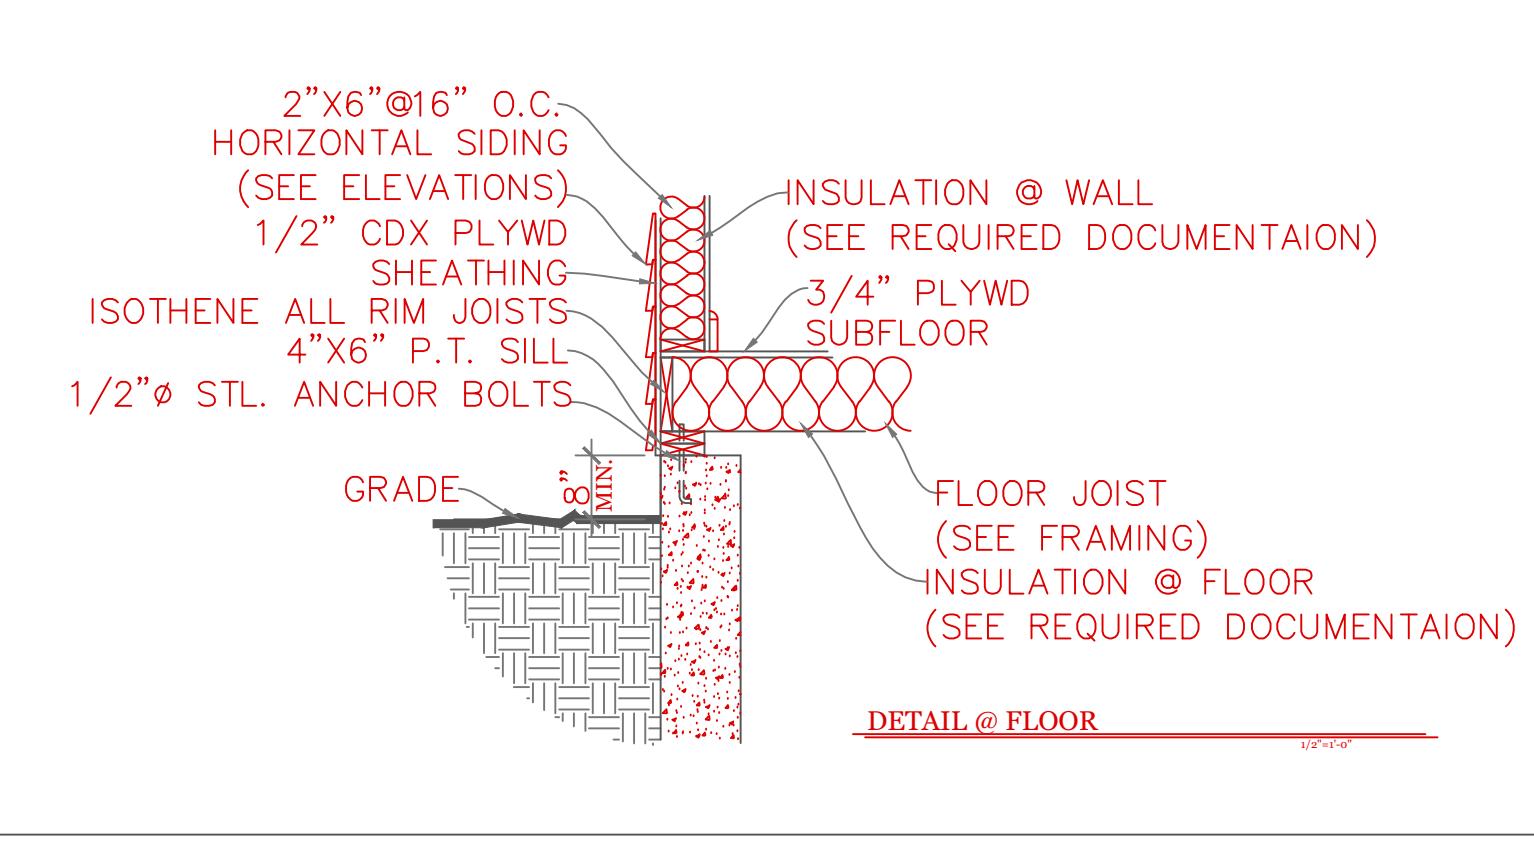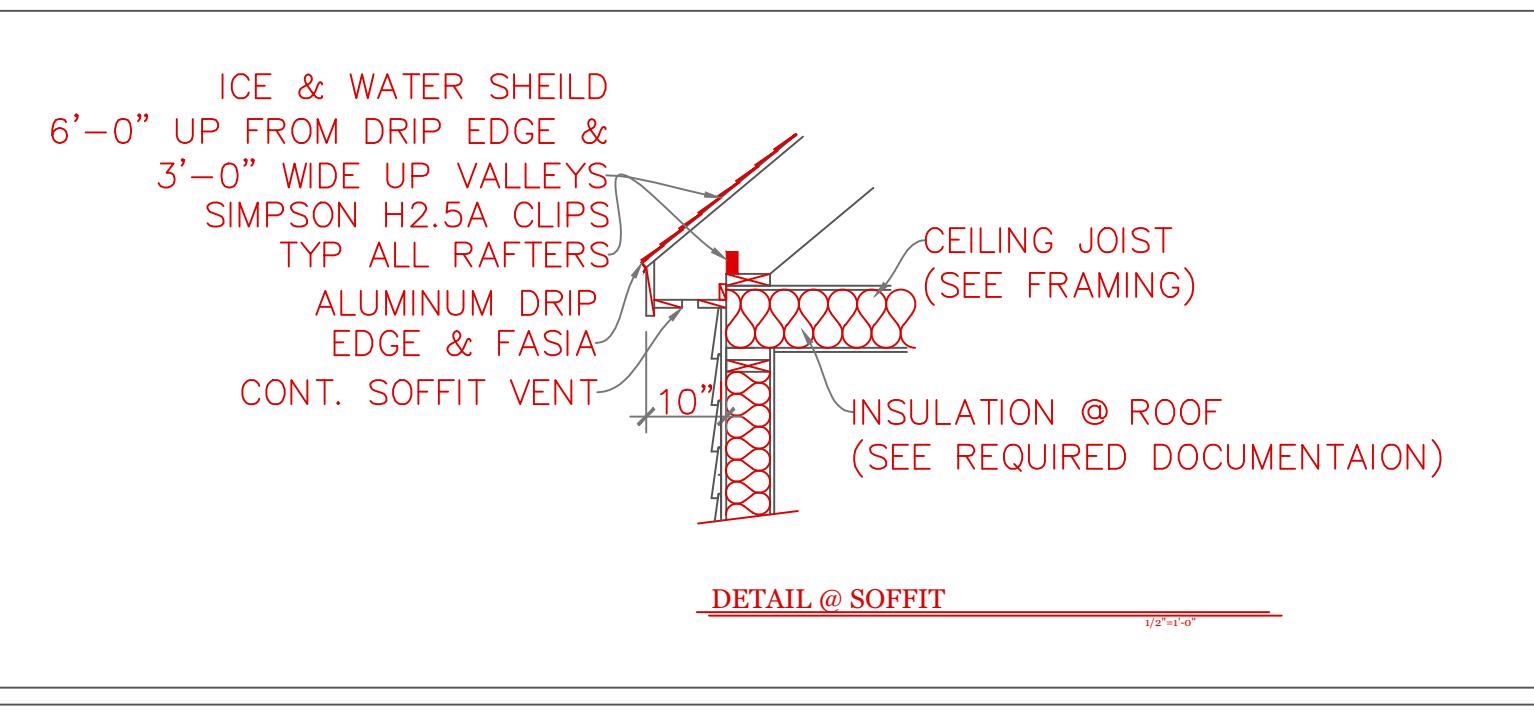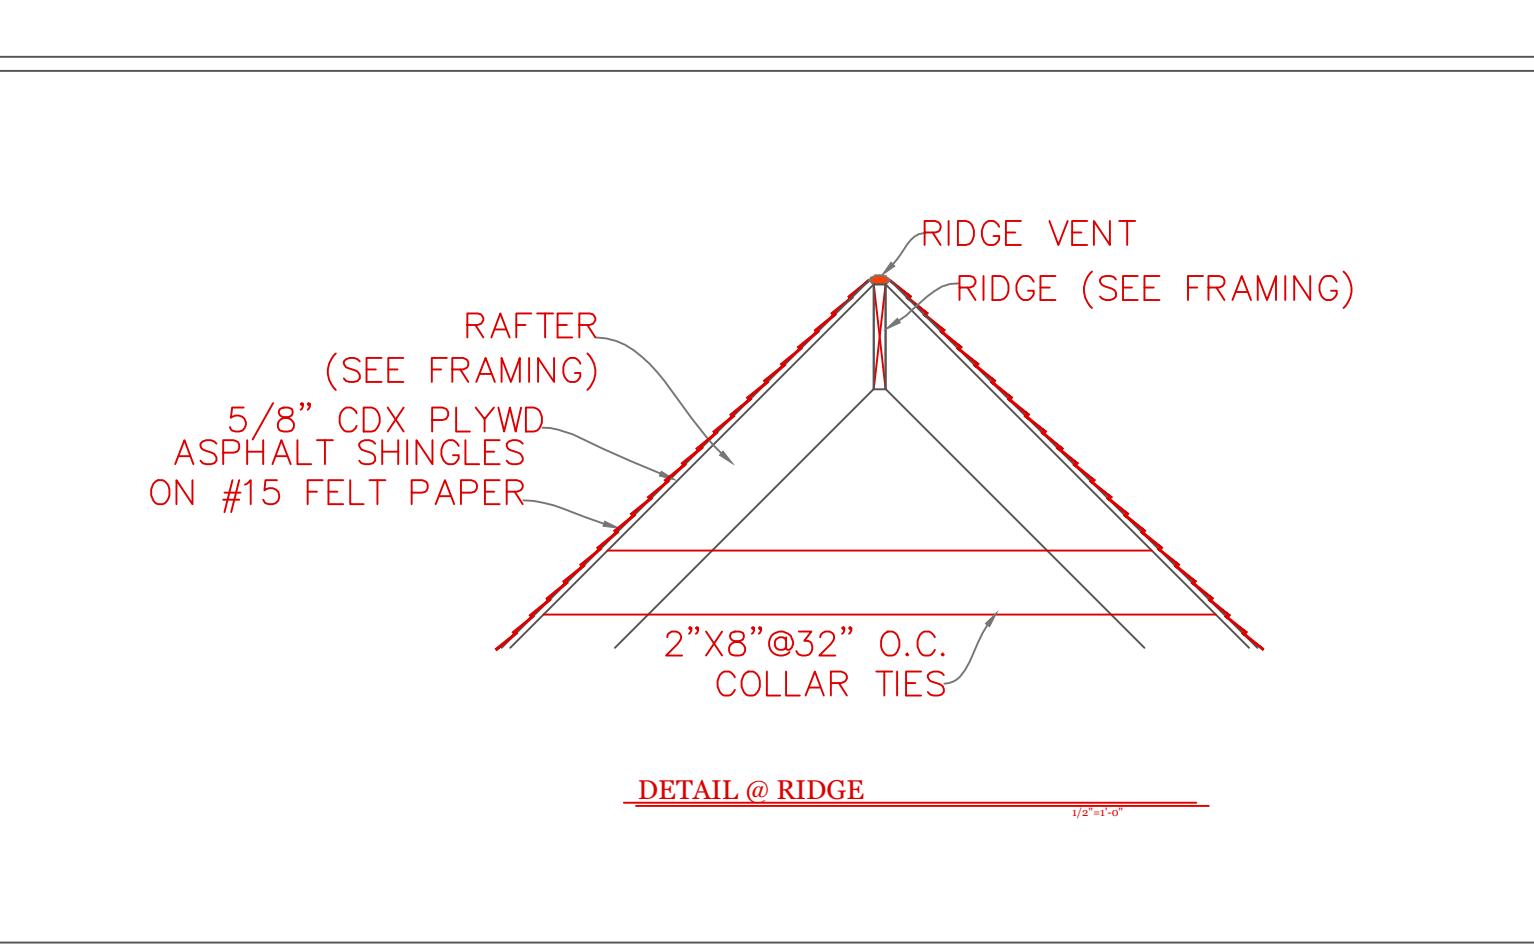

CONSTRUCTION SCHEDULE:	
(UNLESS NOTED OTHERWISE ON PLAN)	
1	RIDGE BOARD: 2X12
2	ROOF MATERIAL: ASPHALT SHINGLES ON 15# ROOF FELT
3	ROOF SHEATHING 1/2" O.S.B. w/ 15# ROOF FELT
4	ROOF RAFTER: SEE FRAMING
5	COLLAR TIES: 1X8 @ 32" O.C.
6	DRIP EDGE: ALUMINUM DRIP EDGE
7	SOFFIT: CONT. SOFFIT VENT
8	CEILING JOIST SEE FRAMING
9	ATTIC INSULATION: R-38
10	EXT WALL: 2"X6" @ 16" O.C.
11	EXT. SHEATHING: 1/2" O.S.B. w/ HOUSE WRAP
12	EXT. FINISH: SEE ELEVATIONS
13	INSULATION@WALL: R-21
14	INTERIOR WALL: 2"X4" @16"O.C.
15	SUB FLOOR: 3/4" ADVANTEK GLUED & NAILED
16	JOIST: SEE FRAMING.
17	SILL: 2"X6" P.T. SILL W/ 2X6 KD TOP PLATE
18	INSULATION @ FLOOR: R-30
19	ANCHOR: 1/2"Ø STL ANCHOR BOLTS
20	BEAM: SEE FRAMING PLAN
21	COLUMN: 3 1/2" L.C.
22	FND. WALL: 10"X7"-10" CONC. WALL
23	SLAB: SEE FOUNDATION NOTES
24	FOOTING: 20"X10" CONT. KEYED FTNG
25	CONC. PAD: 30"X30"X15" CONC. PAD

NOTES: -ISOTHENE ALL RIM JOISTS (OPTIONAL)
-ICE & WATER SHEILD 6'-0" UP FROM DRIP EDGE
& 3'-0" WIDE UP VALLEYS
-SIMPSON H2.5A CLIPS TYP ALL RAFTERS

DUPLEX BUILDING ONLY

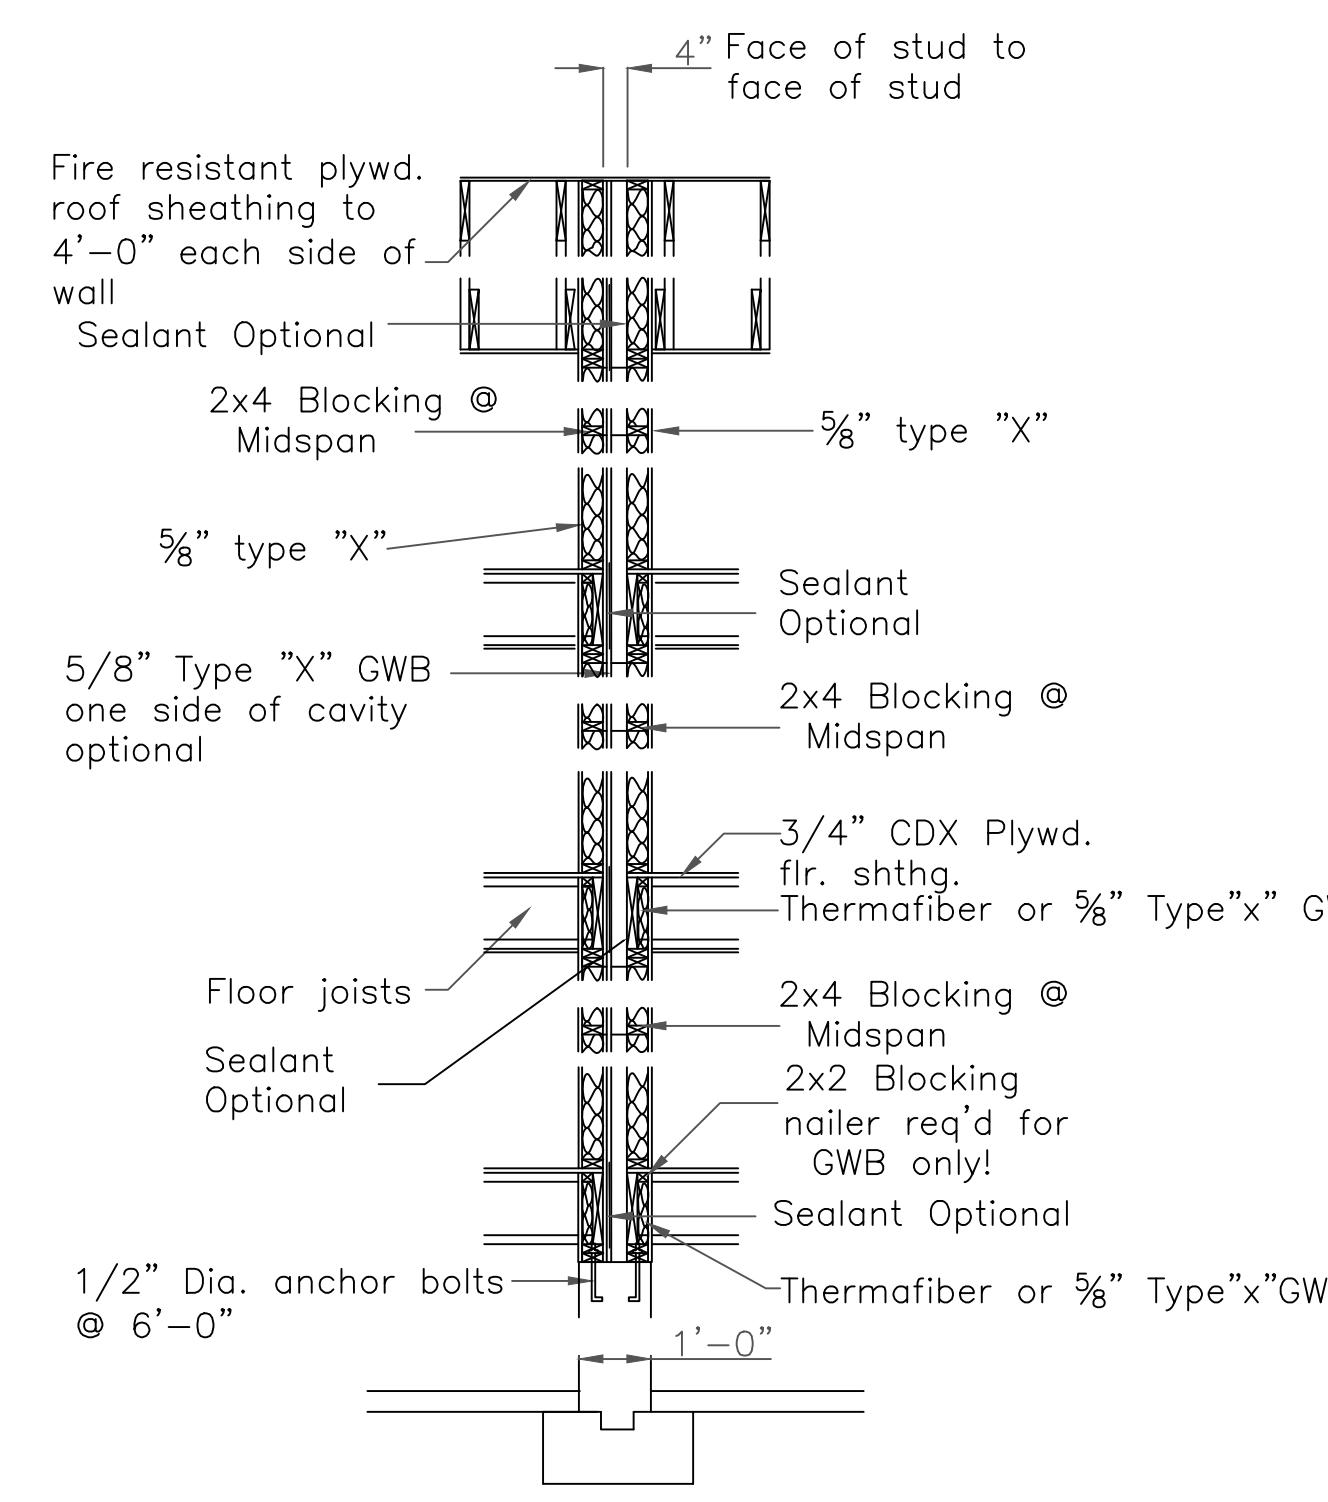

A Fire Resistance rated wall section
For more information see U.L. LISTING --- U-305
STC Rating = 56
Bearing wall Rating = 1 HR.
3/8"-1'-0"

TABLE 402.1.2
INSULATION AND FENESTRATION REQUIREMENTS BY COMPONENT^a

CLIMATE ZONE	FENESTRATION U-FACTOR ^b	SKYLIGHT ^b U-FACTOR	GLAZED FENESTRATION SHGC ^{b,e}	CEILING R-VALUE	WOOD FRAME WALL R-VALUE	MASS WALL R-VALUE	FLOOR R-VALUE	BASEMENT ^c WALL R-VALUE	SLAB ^d R-VALUE & DEPTH	CRAWL SPACE ^c WALL R-VALUE
5 and Marine 4	0.30	0.55	NR	49	20 or 13+5 ^h	13/17	30g	15/19	10, 2 ft	15/19


2018 INTERNATIONAL ENERGY CONSERVATION CODE® AND MASSACHUSETTES 780 CMR 9TH EDITION

- For SI: 1 foot = 304.8 mm.
- a. R-values are minimums. U-factors and SHGC are maximums. R-19 batts compressed into a nominal 2 x 6 framing cavity such that the R-value is reduced by R-1 or more shall be marked with the compressed batt R-value in addition to the full thickness R-value.
 - b. The fenestration U-factor column excludes skylights. The SHGC column applies to all glazed fenestration.
 - c. "15/19" means R-15 continuous insulated sheathing on the interior or exterior of the home or R-19 cavity insulation at the interior of the basement wall. "15/19" shall be permitted to be met with R-13 cavity insulation on the interior of the basement wall plus R-5 continuous insulated sheathing on the interior or exterior of the home. "10/13" means R-10 continuous insulated sheathing on the interior or exterior of the home or R-13 cavity insulation at the interior of the basement wall.
 - d. R-5 shall be added to the required slab edge R-values for heated slabs. Insulation depth shall be the depth of the footing or 2 feet, whichever is less in Zones 1 through 3 for heated slabs.
 - e. There are no SHGC requirements in the Marine Zone.
 - f. Basement wall insulation is not required in warm-humid locations as defined by Figure 301.1 and Table 301.1.
 - g. Or insulation sufficient to fill the framing cavity, R-19 minimum.
 - h. "13+5" means R-13 cavity insulation plus R-5 insulated sheathing. If structural sheathing covers 25 percent or less of the exterior, insulating sheathing is not required where structural sheathing is used. If structural sheathing covers more than 25 percent of exterior, structural sheathing shall be supplemented with insulated sheathing of at least R-2.
 - i. The second R-value applies when more than half the insulation is on the interior of the mass wall.
 - j. For impact rated fenestration complying with Section R301.21.2 of the International Residential Code or Section 1608.1.2 of the International Building Code, the maximum U-factor shall be 0.75 in Zone 2 and 0.65 in Zone 3.

DESIGN CRITERIA

GROUND SNOW LOAD	WIND SPEED (MPH)	SEISMIC DESIGN	WEATHERING	FROST LINE DEPTH	TERMITE	DECAY	WINTER DESIGN TEMP	ICE SHIELD UNDERLAYMENT REQUIRED	FLOOD HAZARD	AIR FREEZING INDEX	MEAN ANNUAL TEMP
TABLE 5301.2(5)	TABLE 5301.2(4)	N/A	FIGURE 5301.2(3)	4 ft. minimum unless engineered data shows otherwise	FIGURE 5301.2(6)	APPENDIX 780 CMR 120-J TABLE 120.J-3.2.1	FIGURE 5301.2(7)	As required by the exterior roof covering manufacturer; roof pitch and local climate must also be considered	Refer to applicable Flood Insurance Rate Map (FIRM)	Only utilized in the design and construction of firm protected foundations	Only utilized in the design and construction of firm protected shallow foundations

50 psf 124 mph N/A SEVERE \$5403.1-4 MODERATE TO HEAVY SLIGHT TO MODERATE N/A \$5905.0 FIRM MAPS SEE NOTE J TABLE 5301.2(5) SEE NOTE K TABLE 5301.2(6)

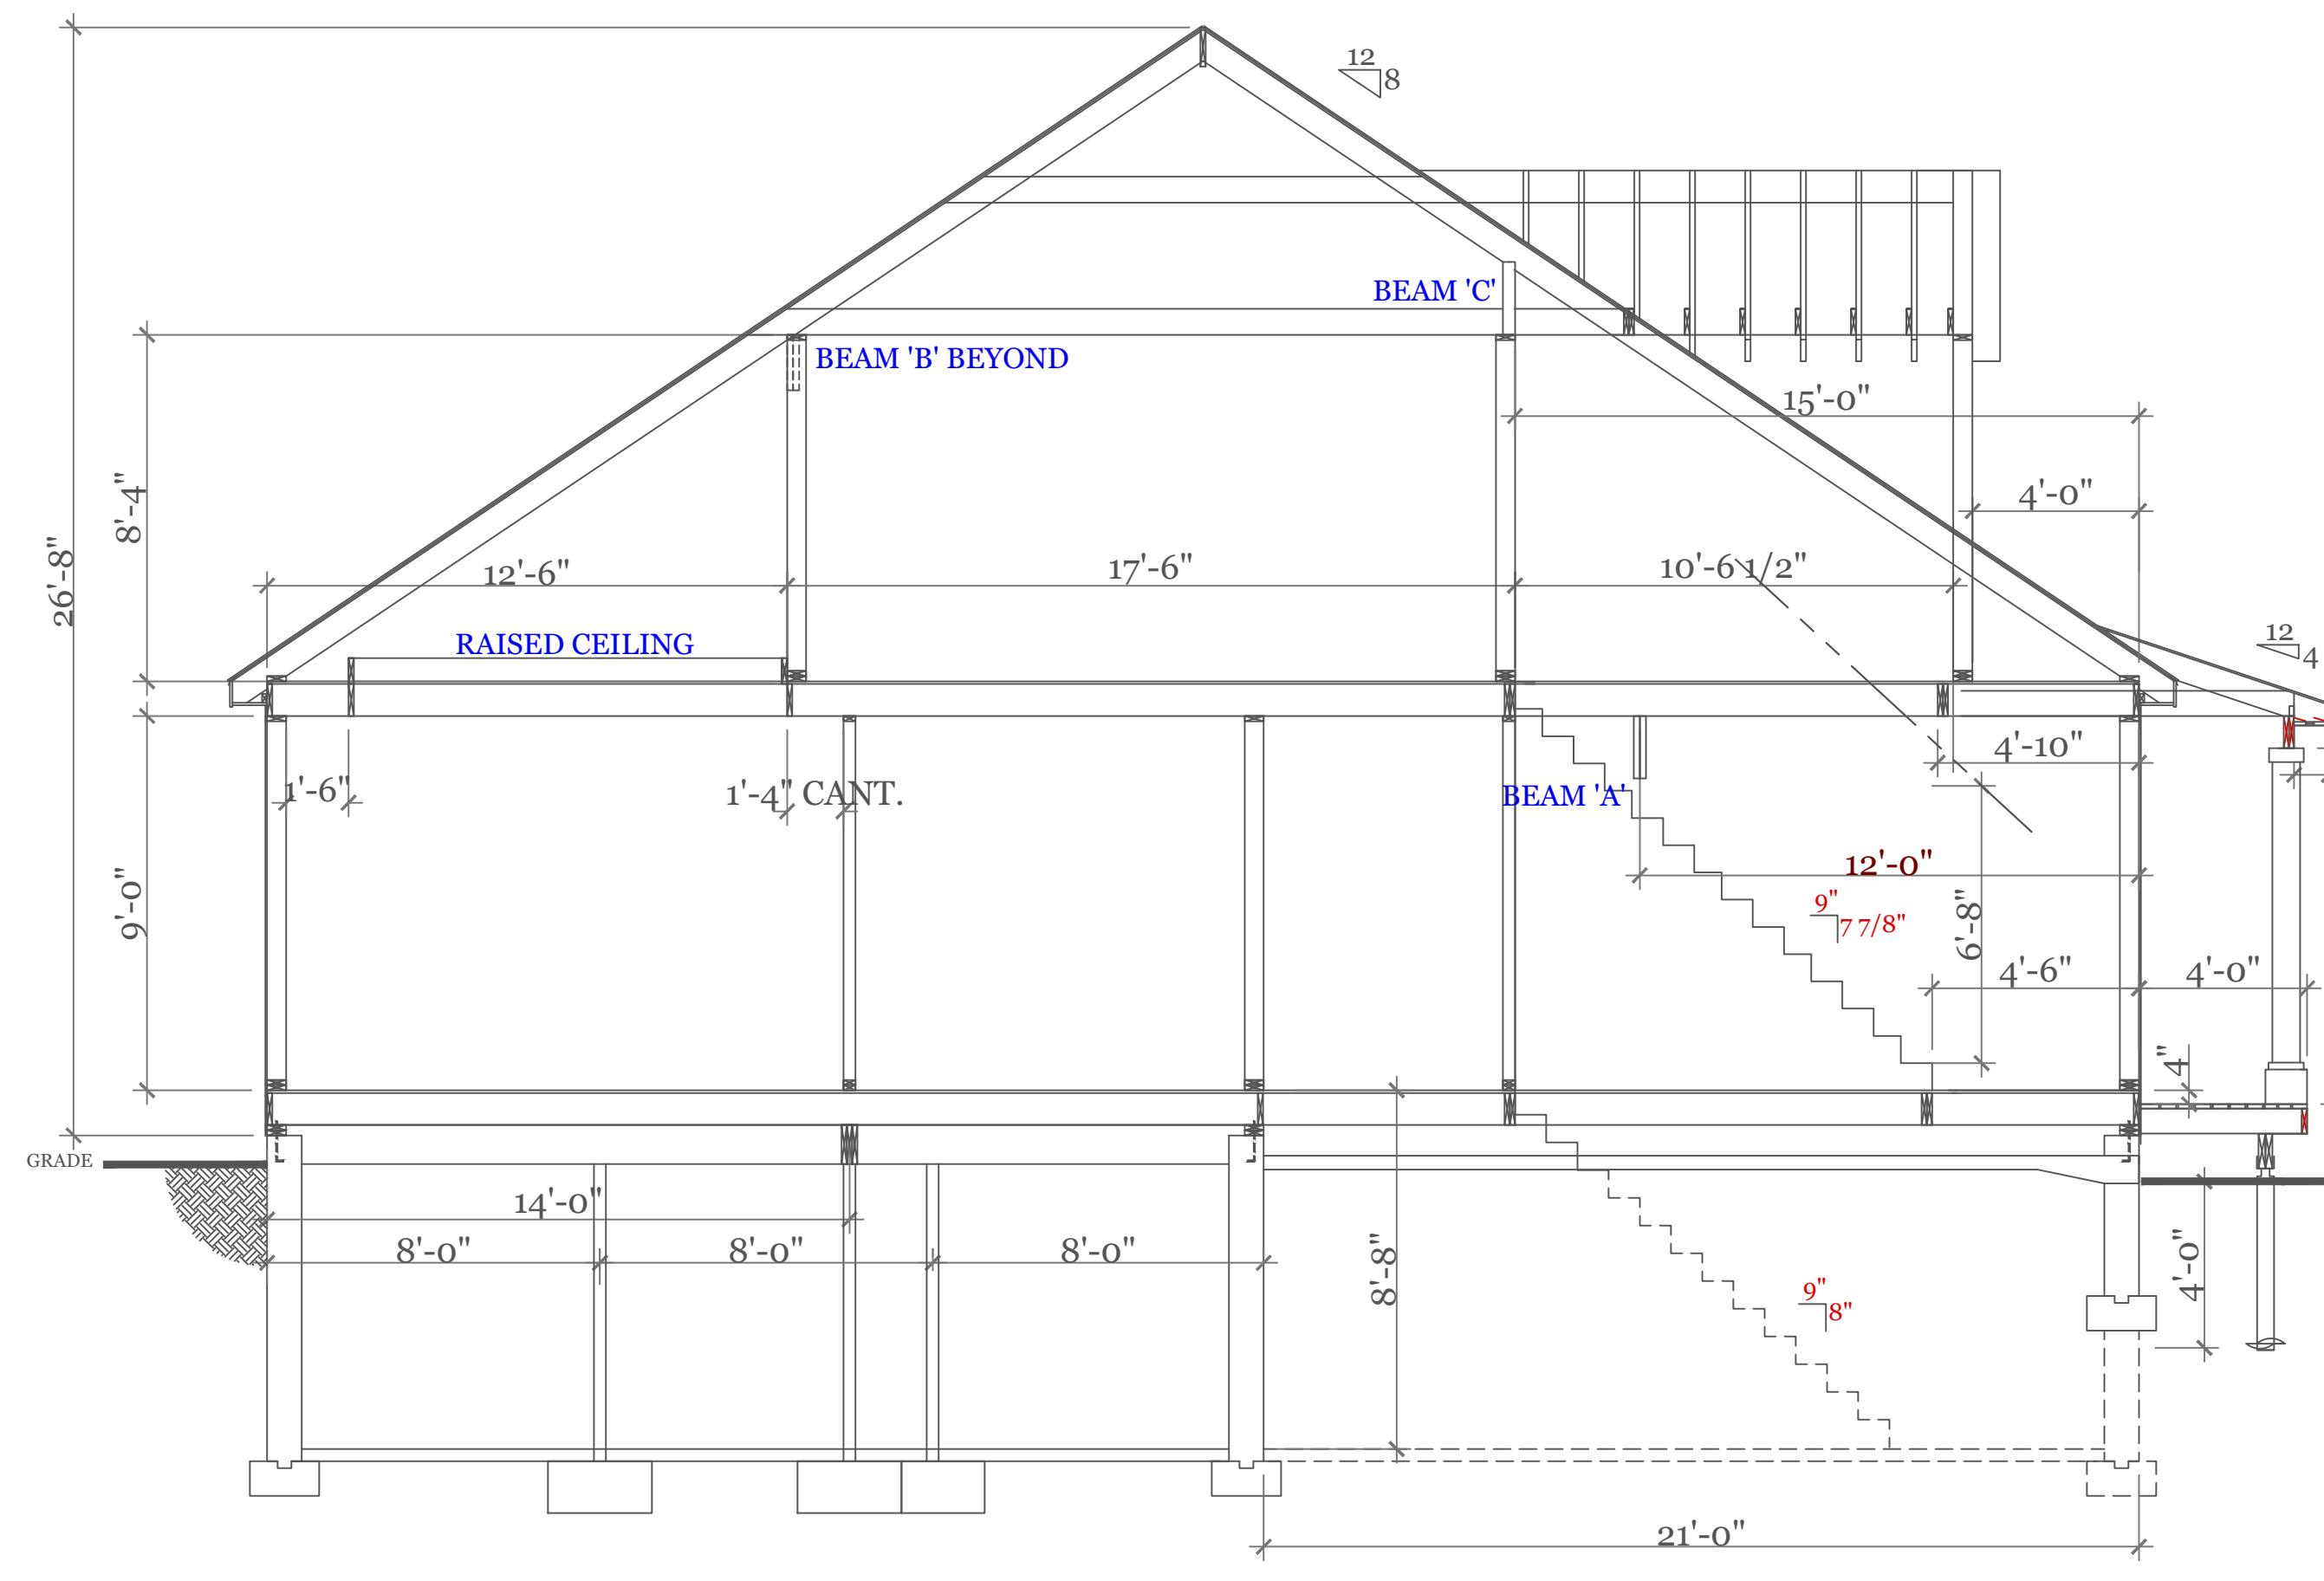

CROSS SECTION

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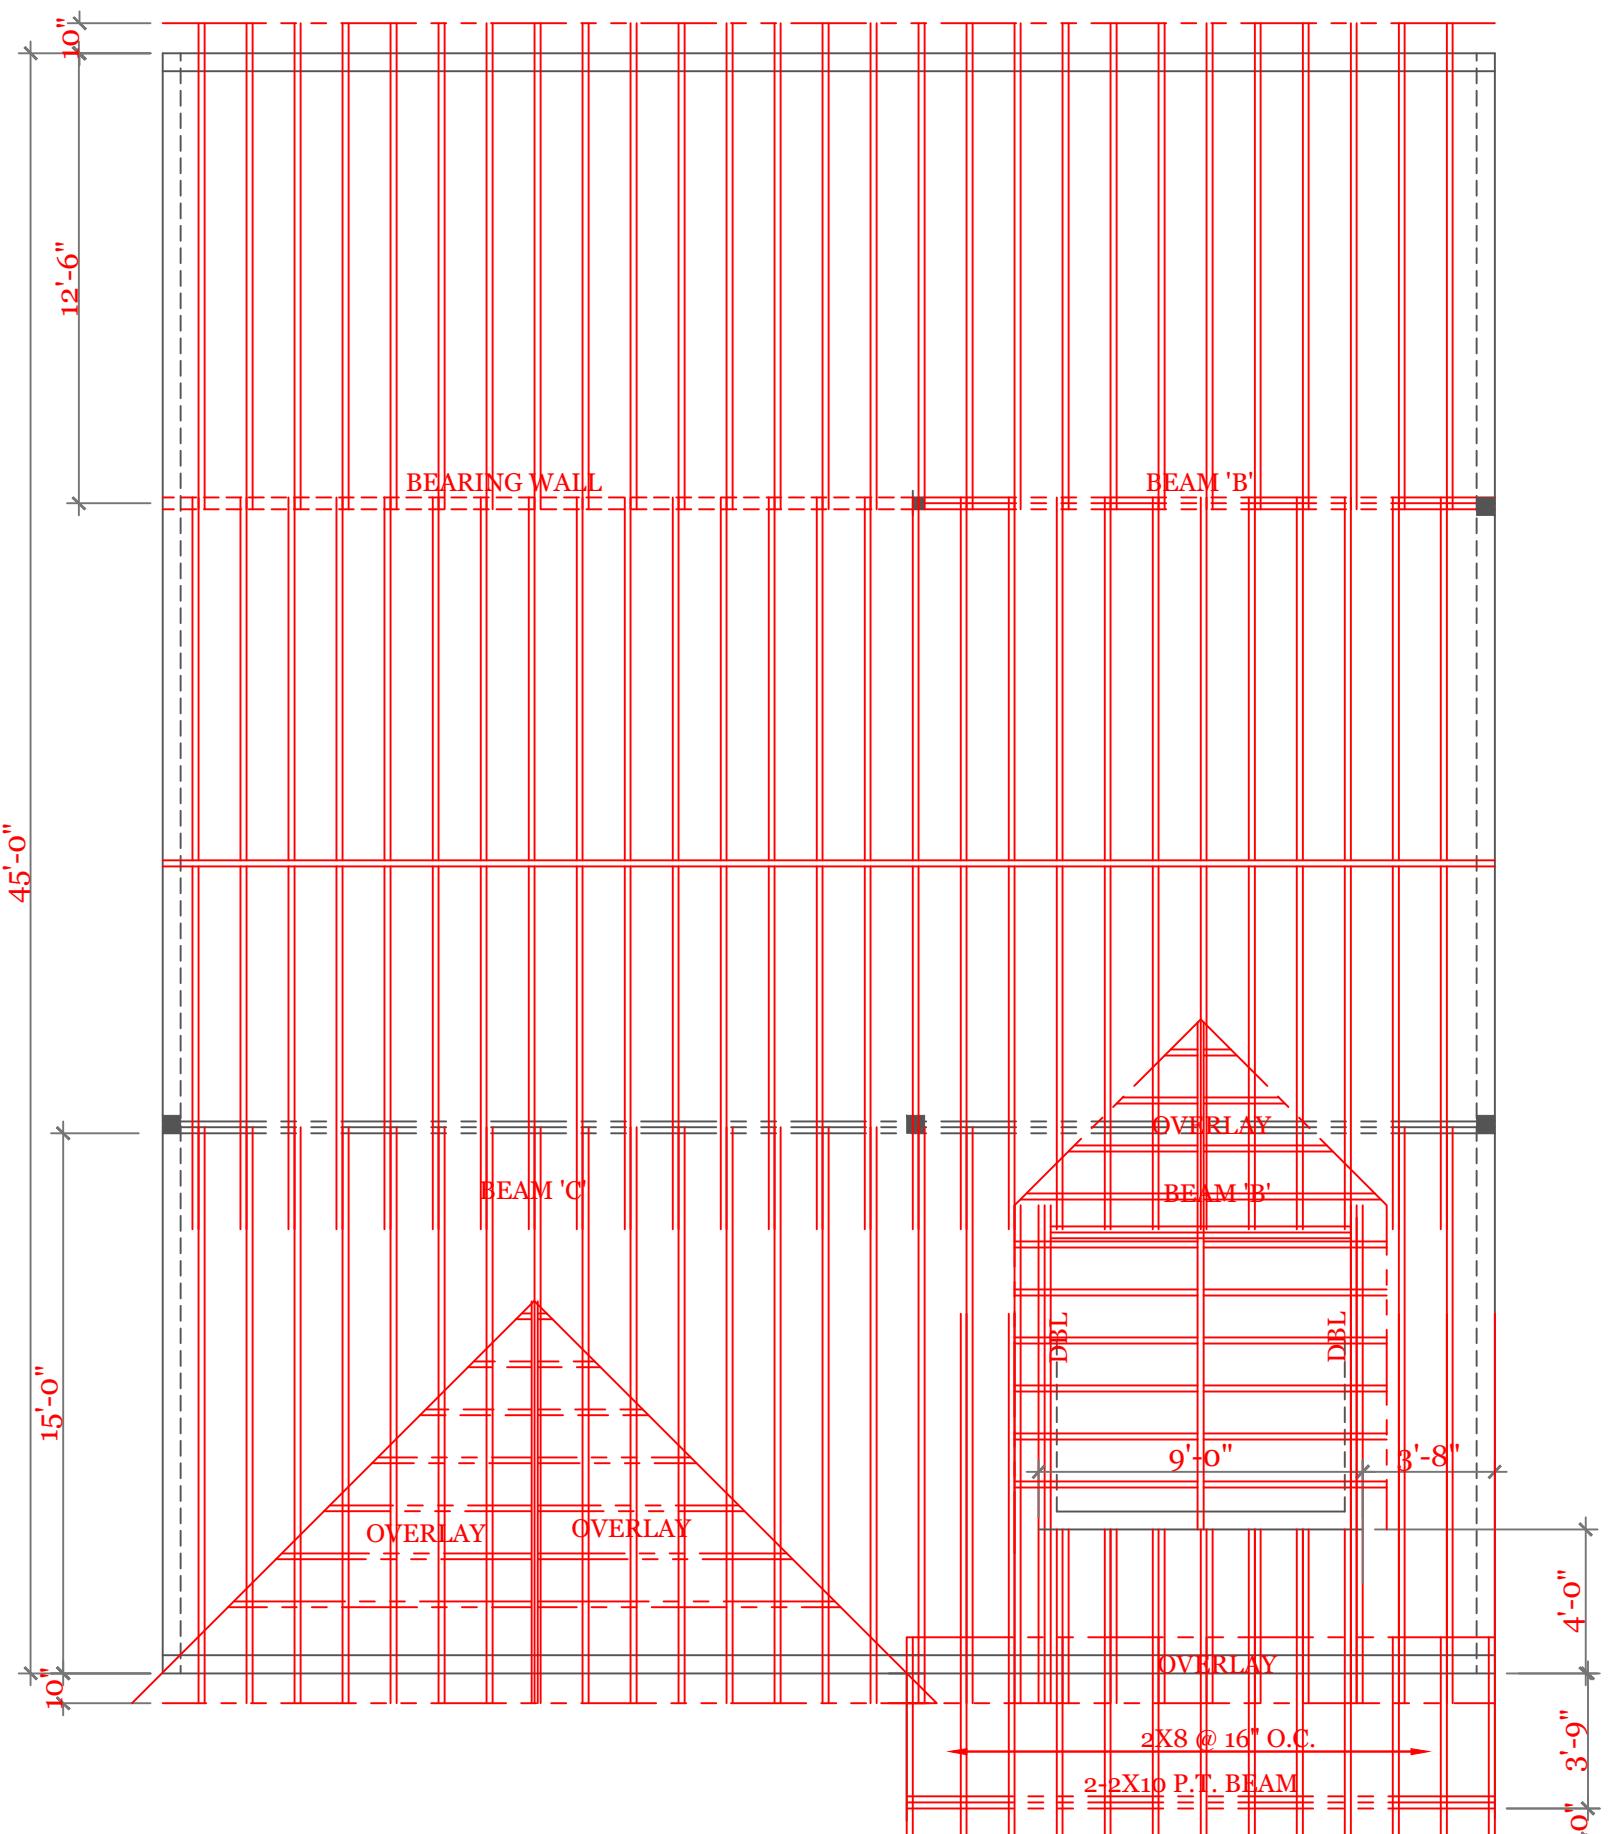
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299 SALISBURY STR.
WORCESTER, MA
(508)450-3461

UNIT 'A'
HIGGINS FARM AT
SALISBURY HILL
BUILDING
SECTIONS &
DETAILS
UNIT 'A' GL
DATE: 9/20/22 R-5/5/23
SCALE: AS NOTED
DRAWN BY: RCS
CHECKED BY: MJB
Sheet 4 OF 5

4

NOTES:


NOTES:




ROOF FRAMING (2"X8"@16"O.C. UNLESS NOTED)

BEAM CALCULATIONS


BEAM	SIZE	SPAN	LIVE LOAD	TOTAL LOAD	MAX LIVE (PLF)	MAX TOTAL (PLF)
A	3 1/2" X 18" LVL	22'-0"	315	420	473	681
B	3 1/2" X 16" LVL	16'-0"	550	660	1296	1320
C	5 1/4" X 18" LVL	21'-0"	800	960	1065	1298

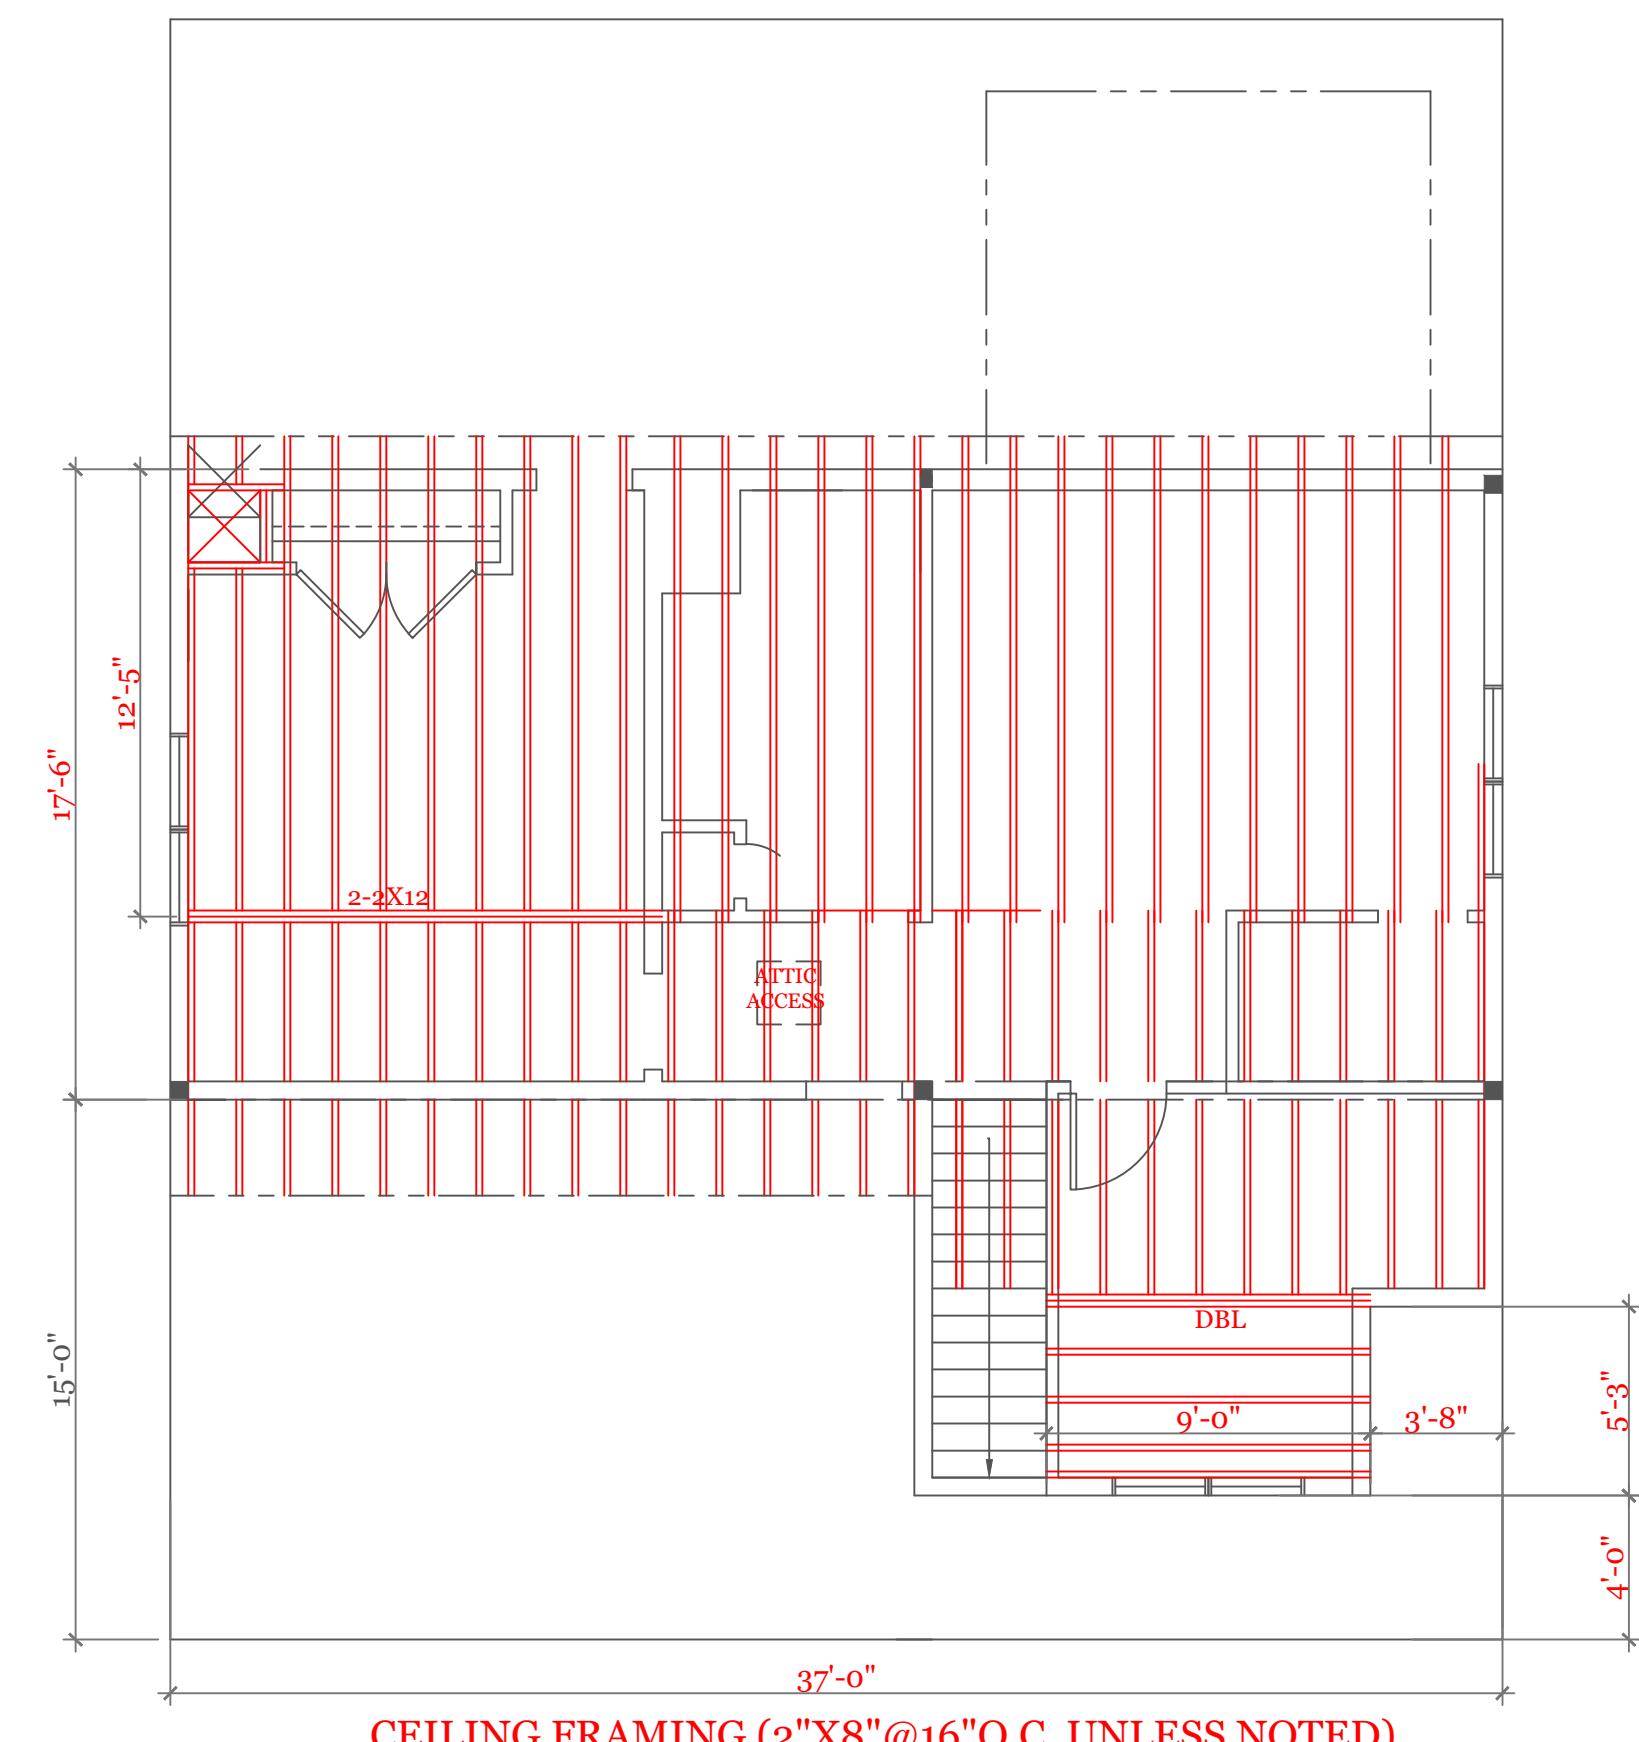

CEILING FRAMING (2"X8"@16"O.C. UNLESS NOTED)

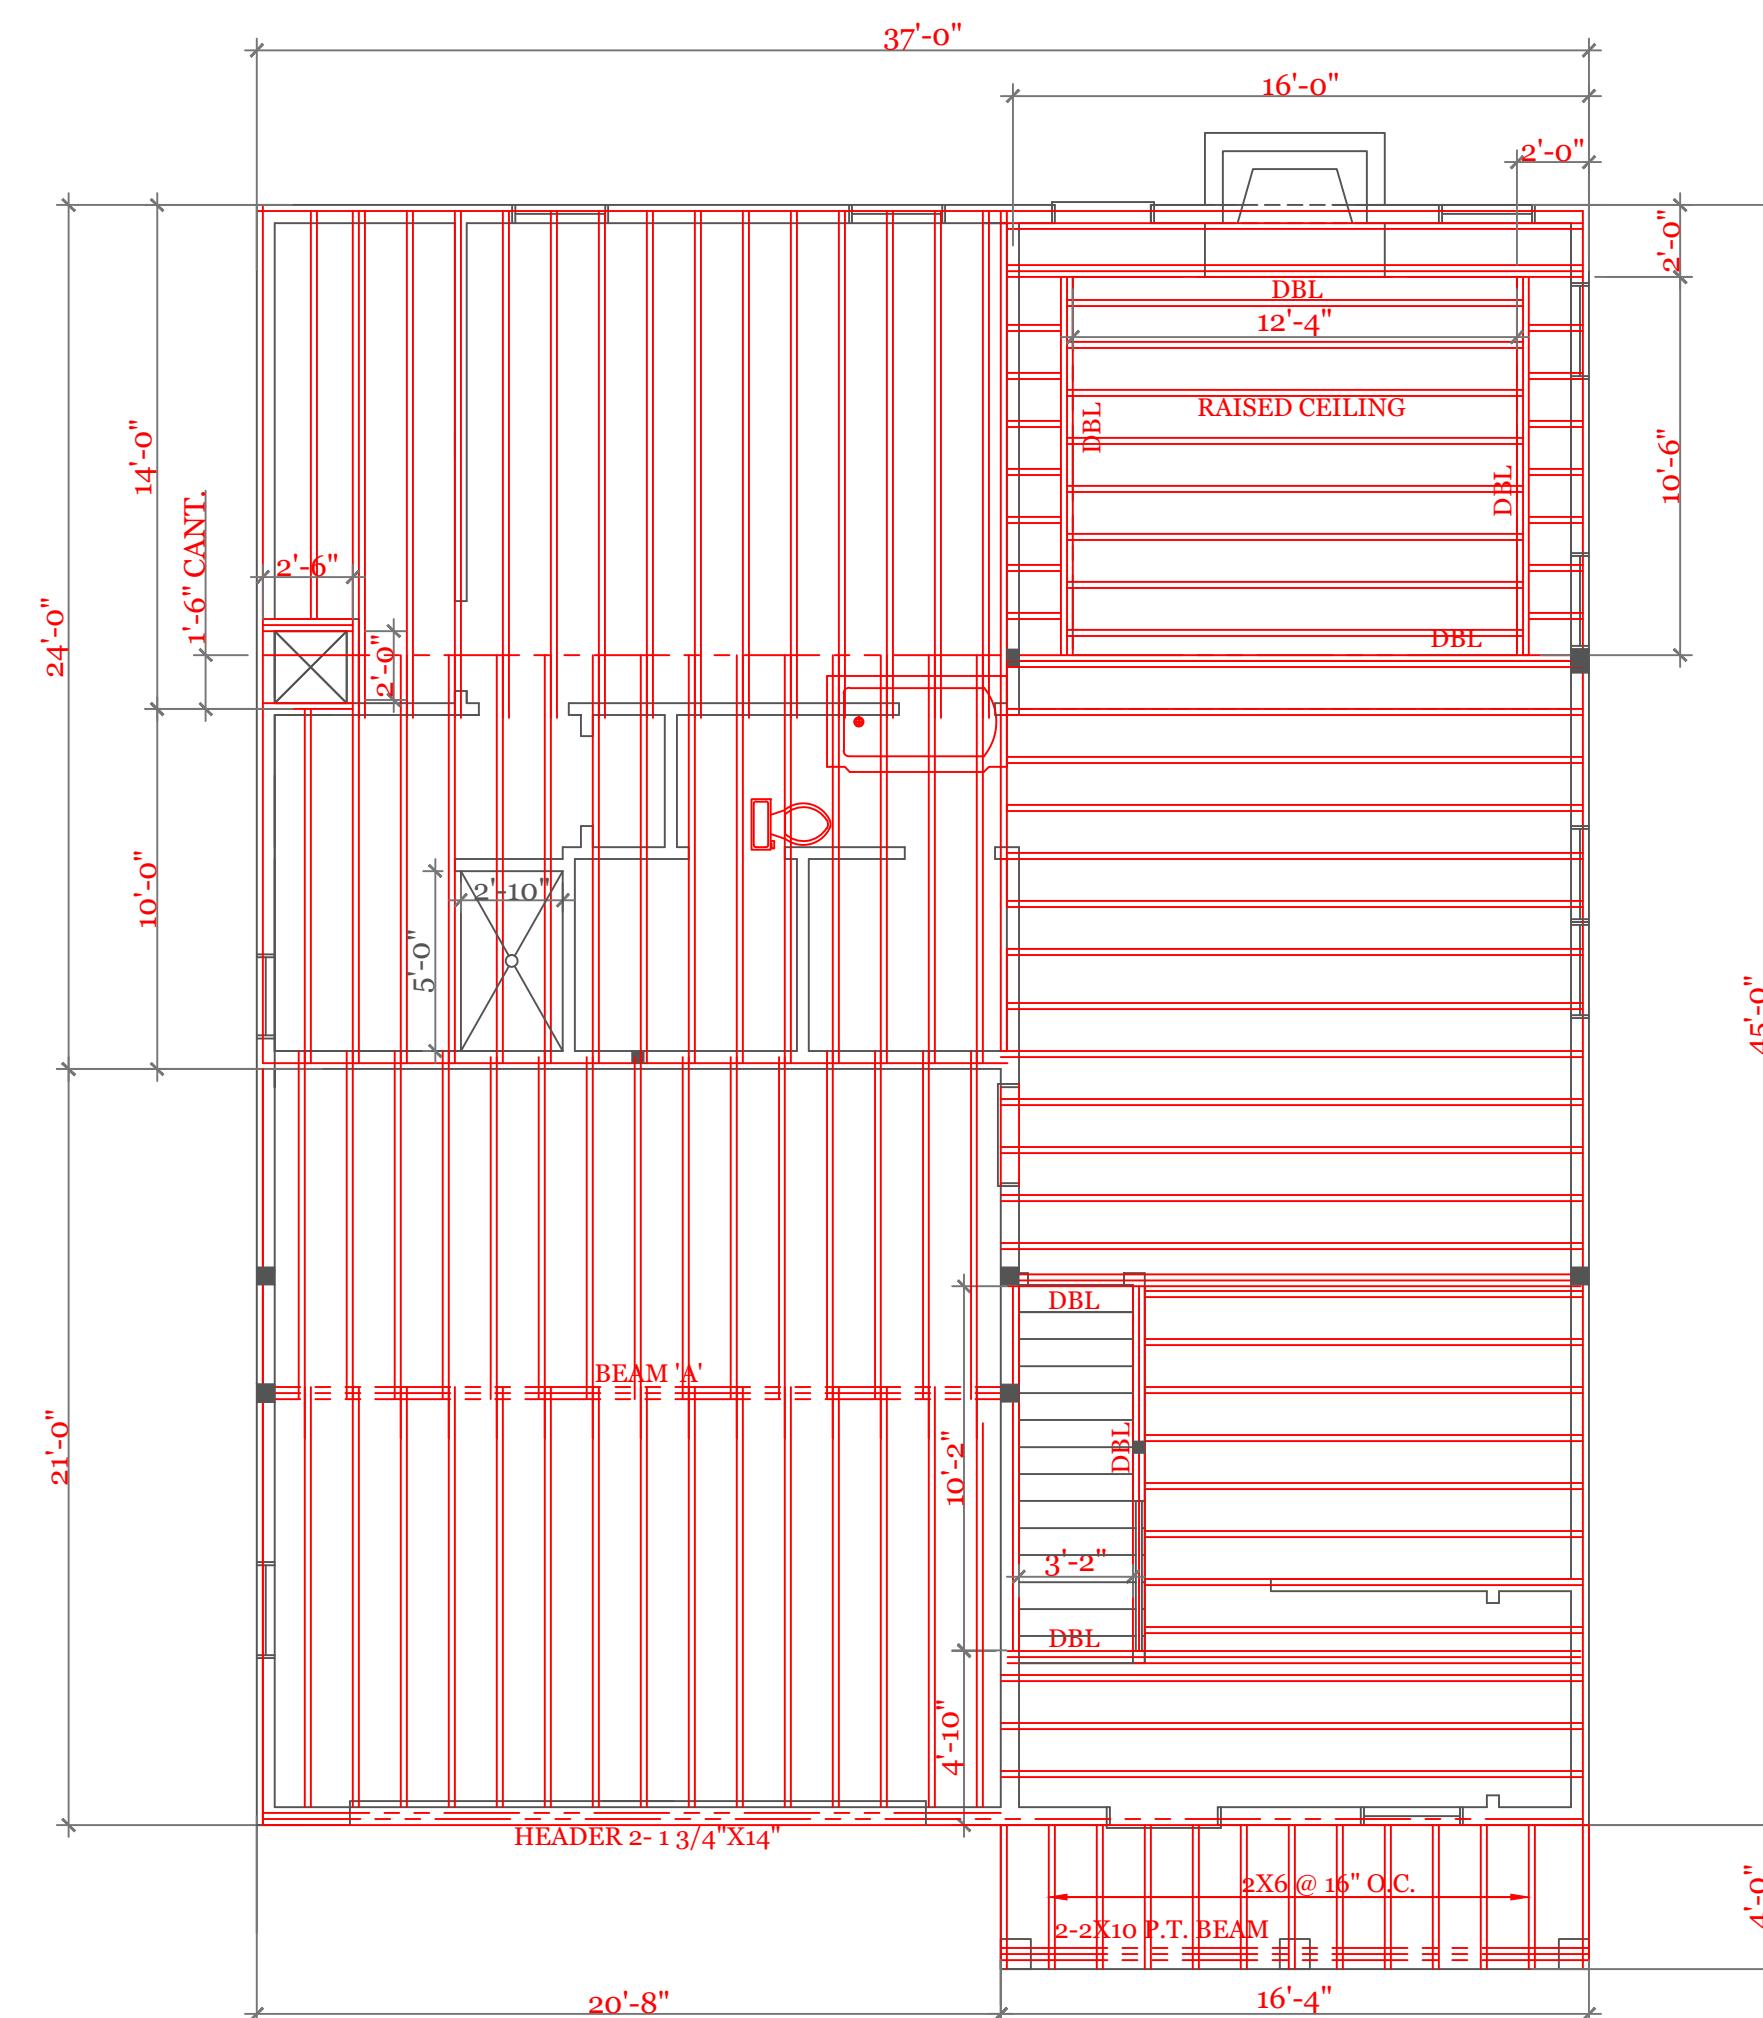

SECOND FLOOR FRAMING (2"X10"@16"O.C. UNLESS NOTED)

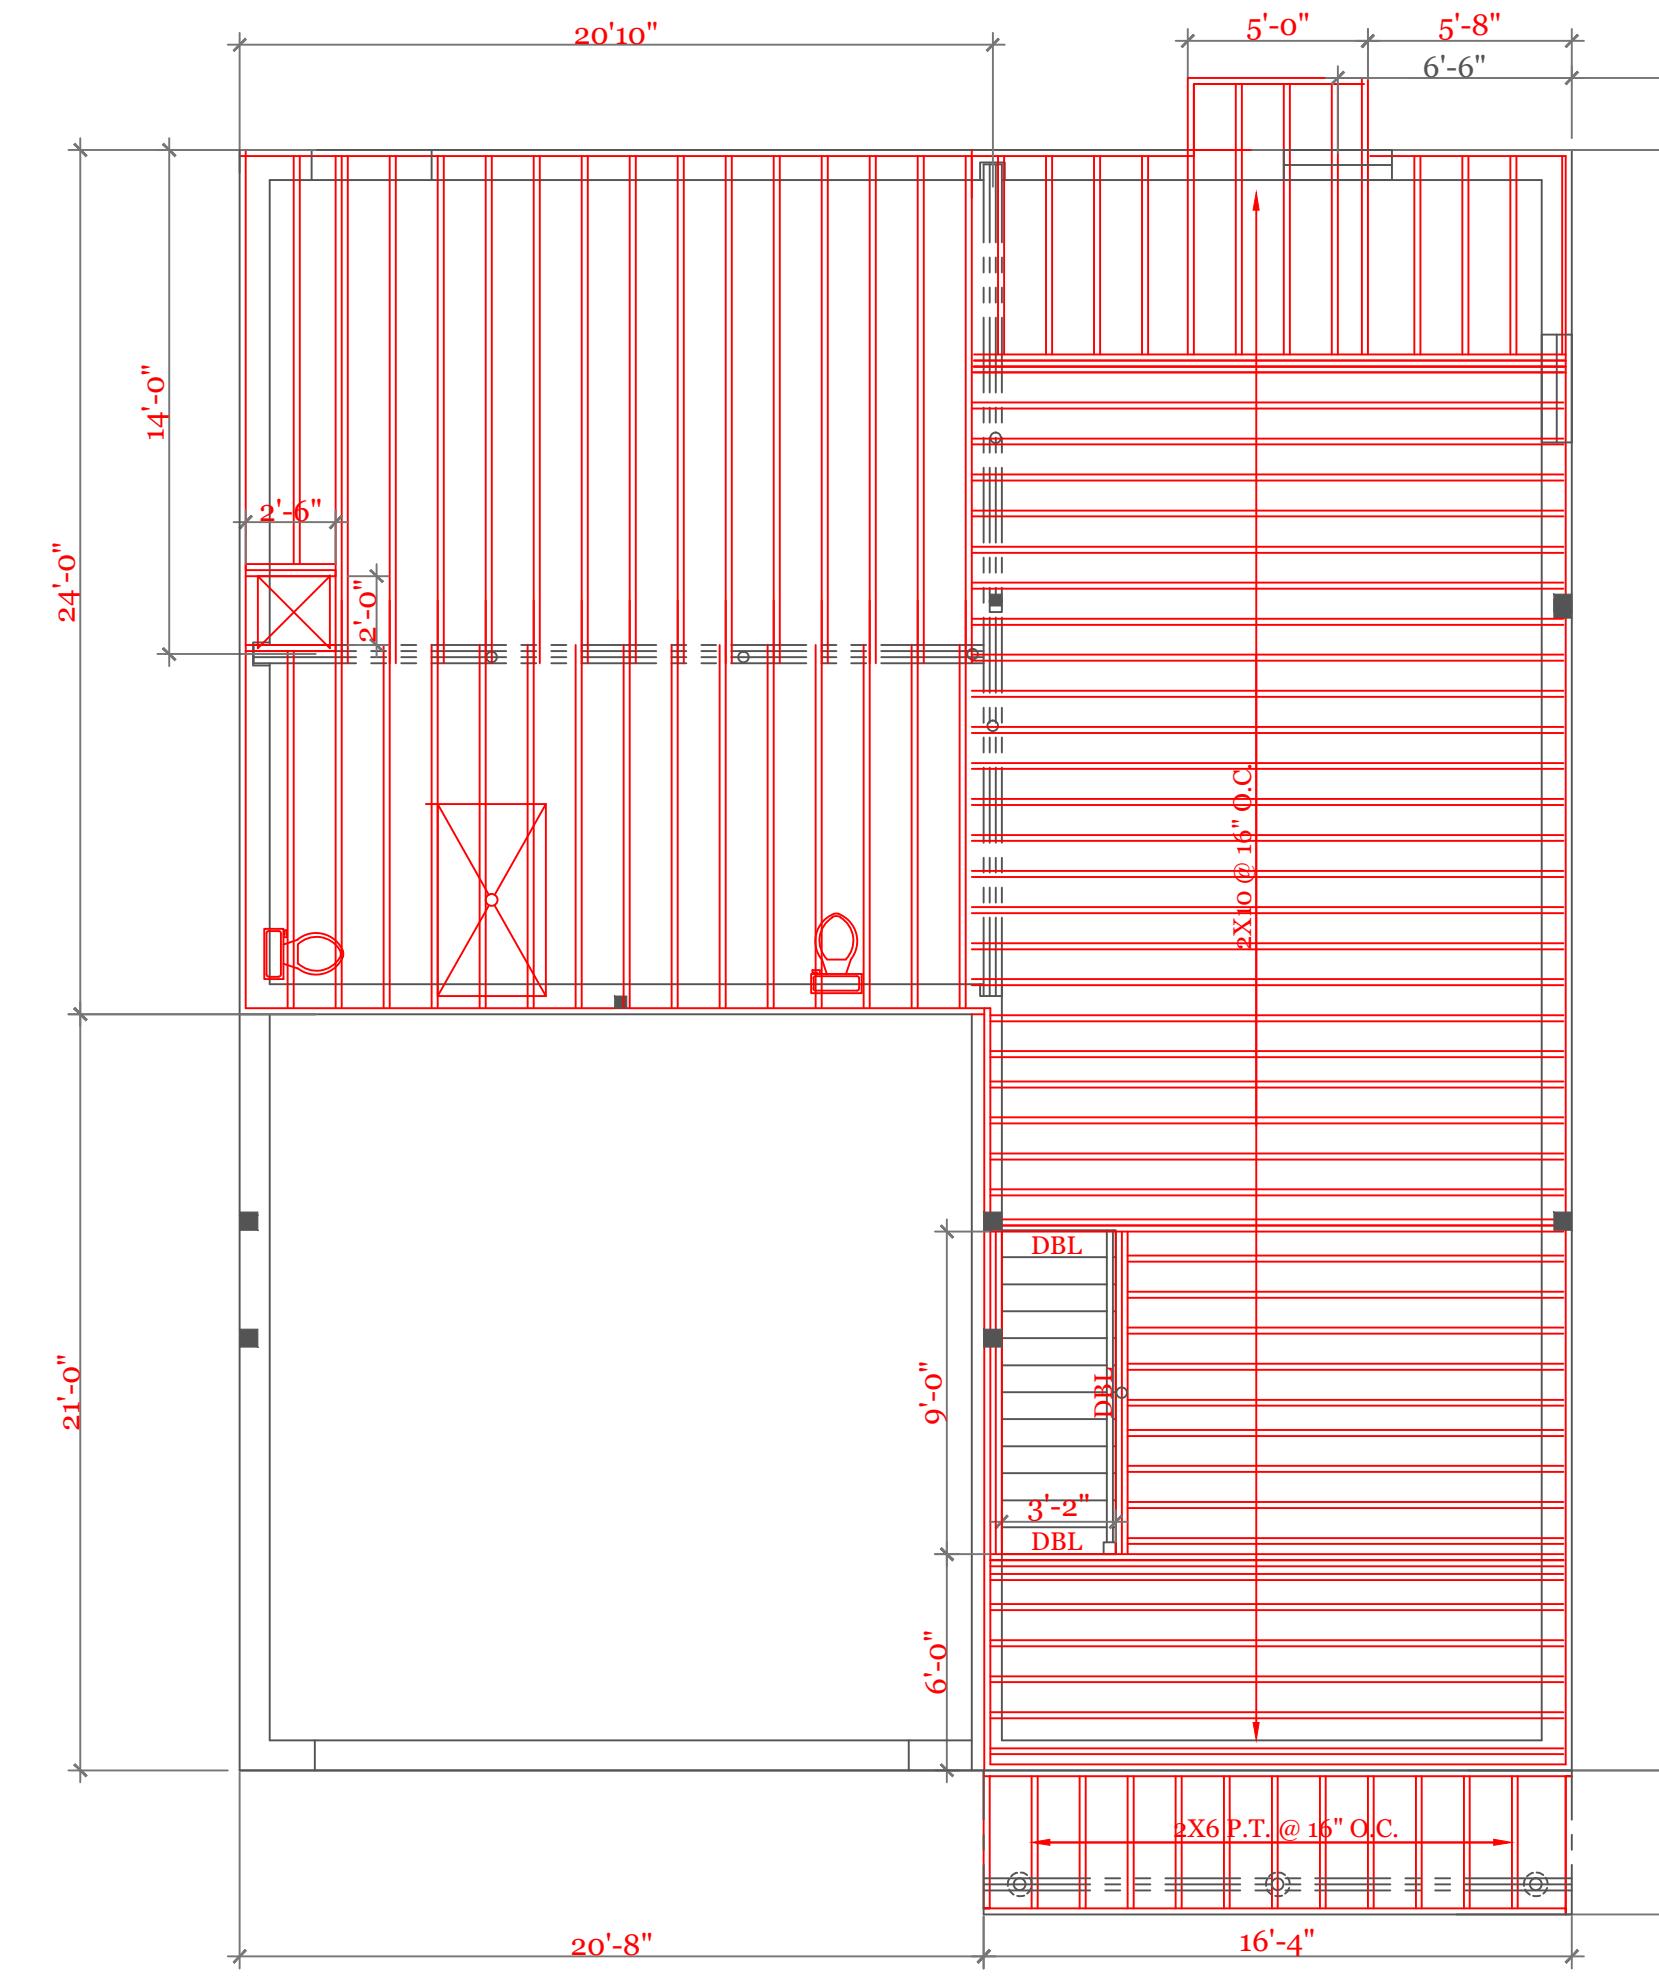FIRST FLOOR FRAMING (2"X10"@16"O.C. UNLESS NOTED)
OPTION 2X12 @ 16" O.C.

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(508)450-3461UNIT 'A'
HIGGINS FARM AT
SALISBURY HILLFRAMING PLANS
BEAM SCHEDULE

UNIT 'A' GL

DATE: 9/20/22 R-5/5/23

SCALE: 1/4" = 1'-0"

DRAWN BY: RCS


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Sheet 5 OF 5

5


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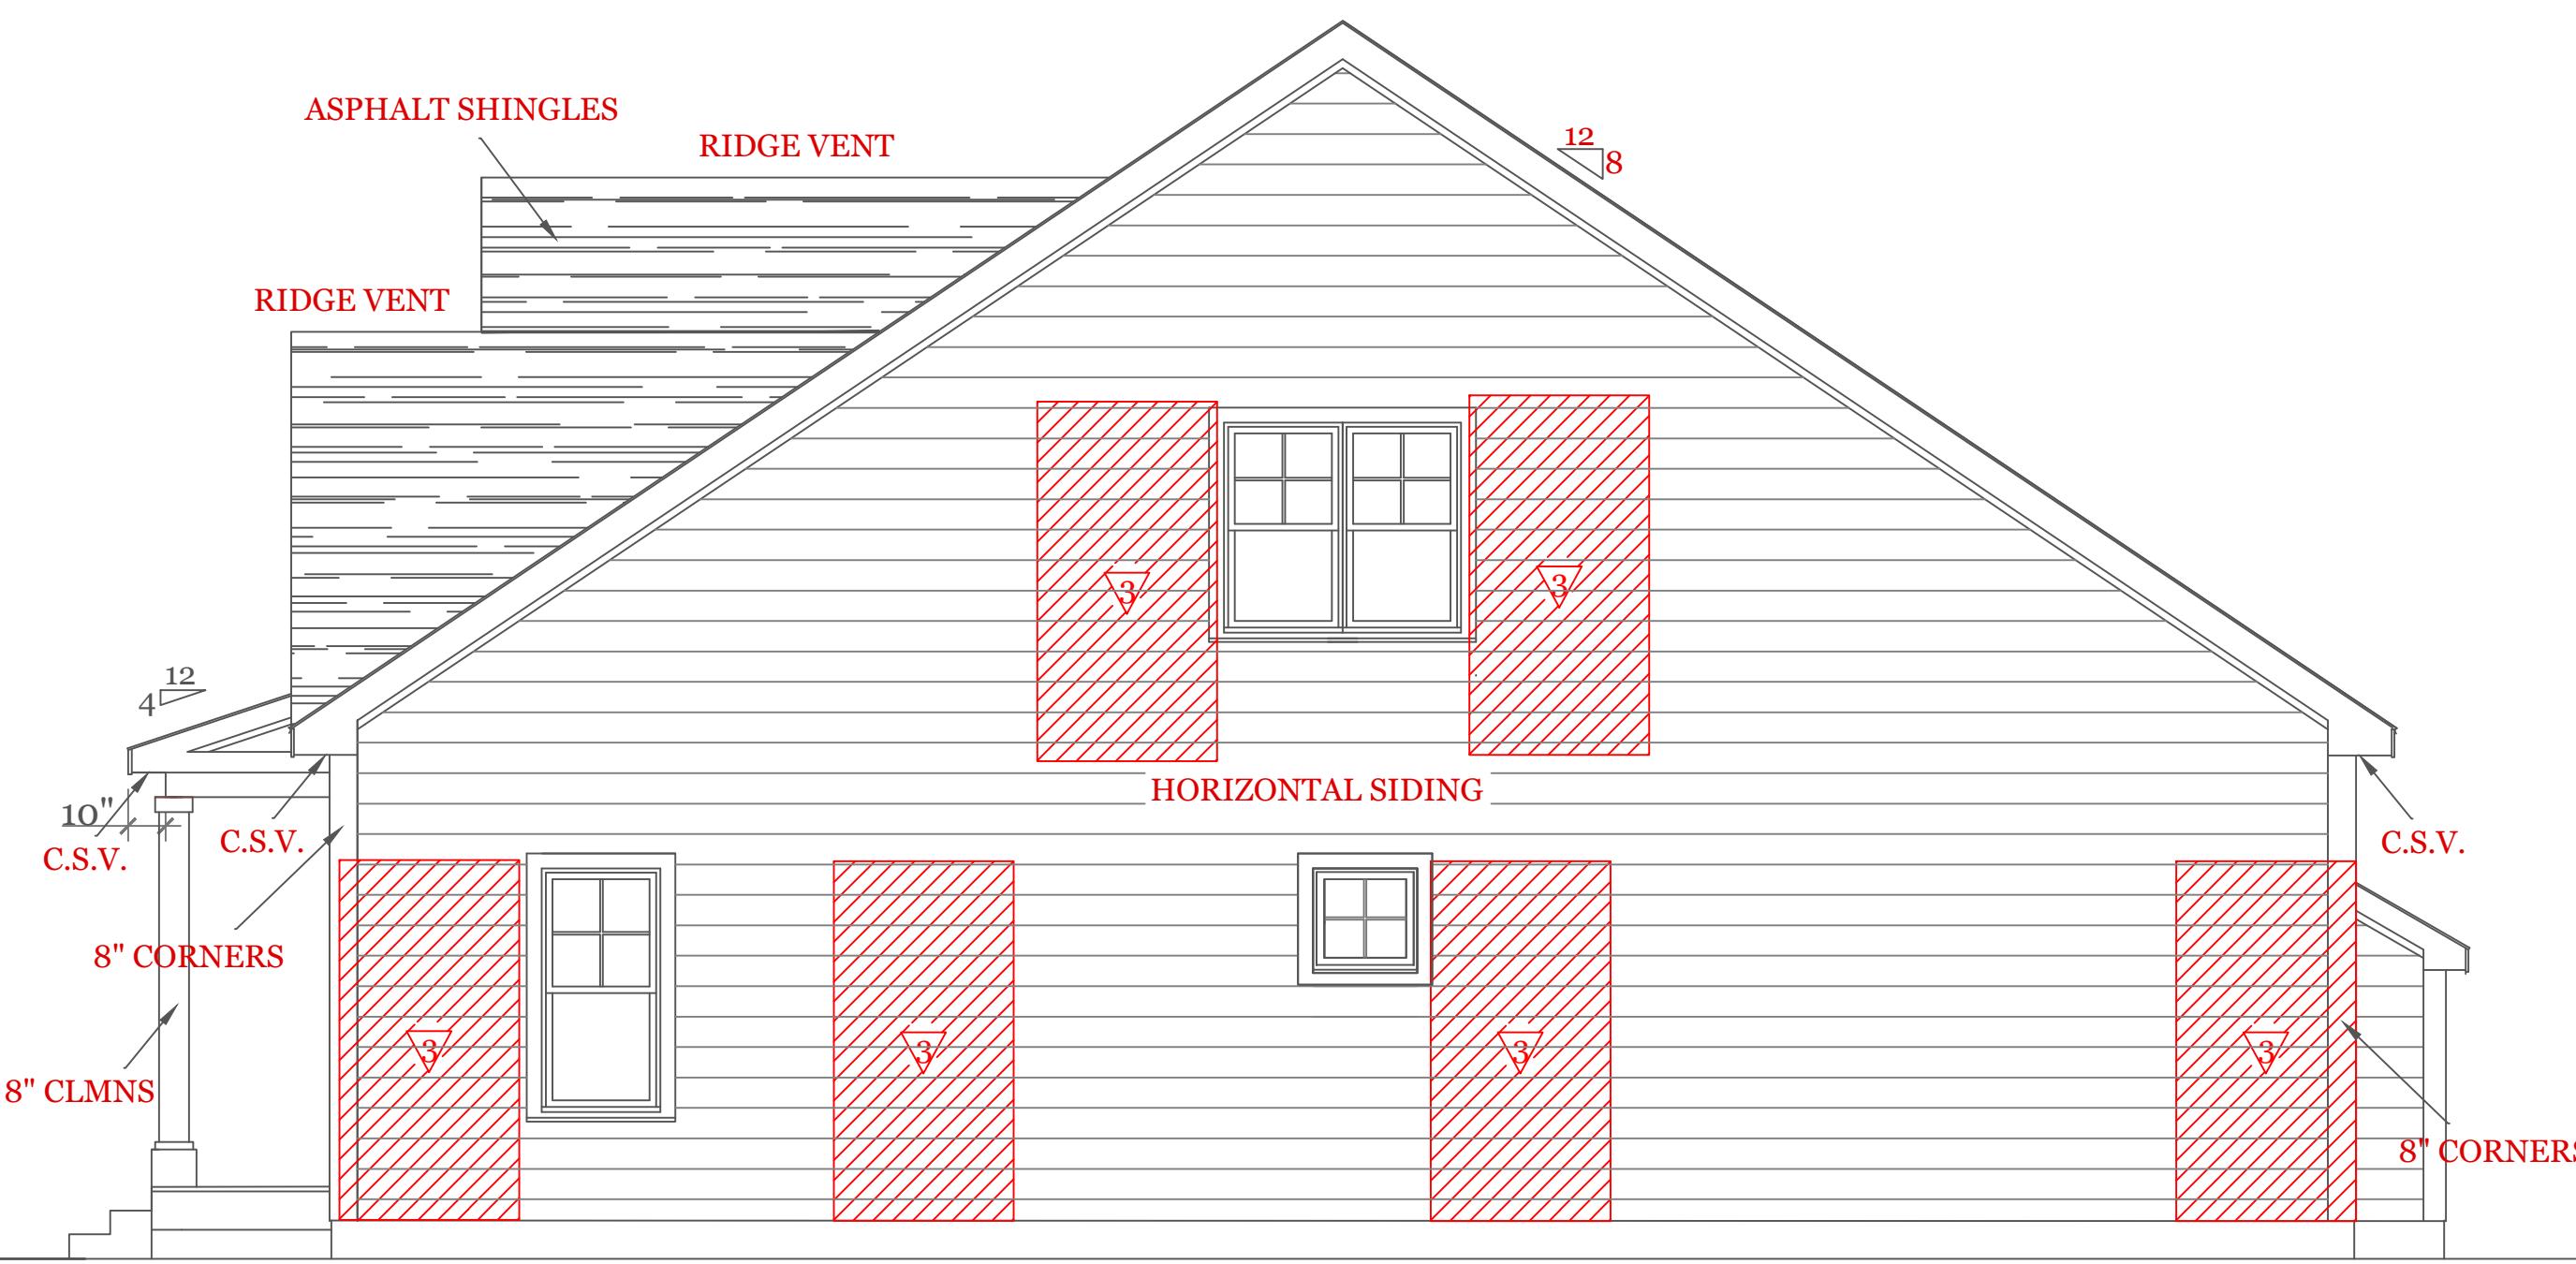


FRONT ELEVATION (1799 s.f.)


WOOD STRUCTURAL PANEL 15/32 CDX PLY WD. SHEATHING ON 16"
 STUD SPACING PANELS INSTALLED VERTICALLY
 W/ 6d COMMON NAIL 6" O.C. @ EDGES & 12" O.C. INTERMEDIATE
 SUPPORTS

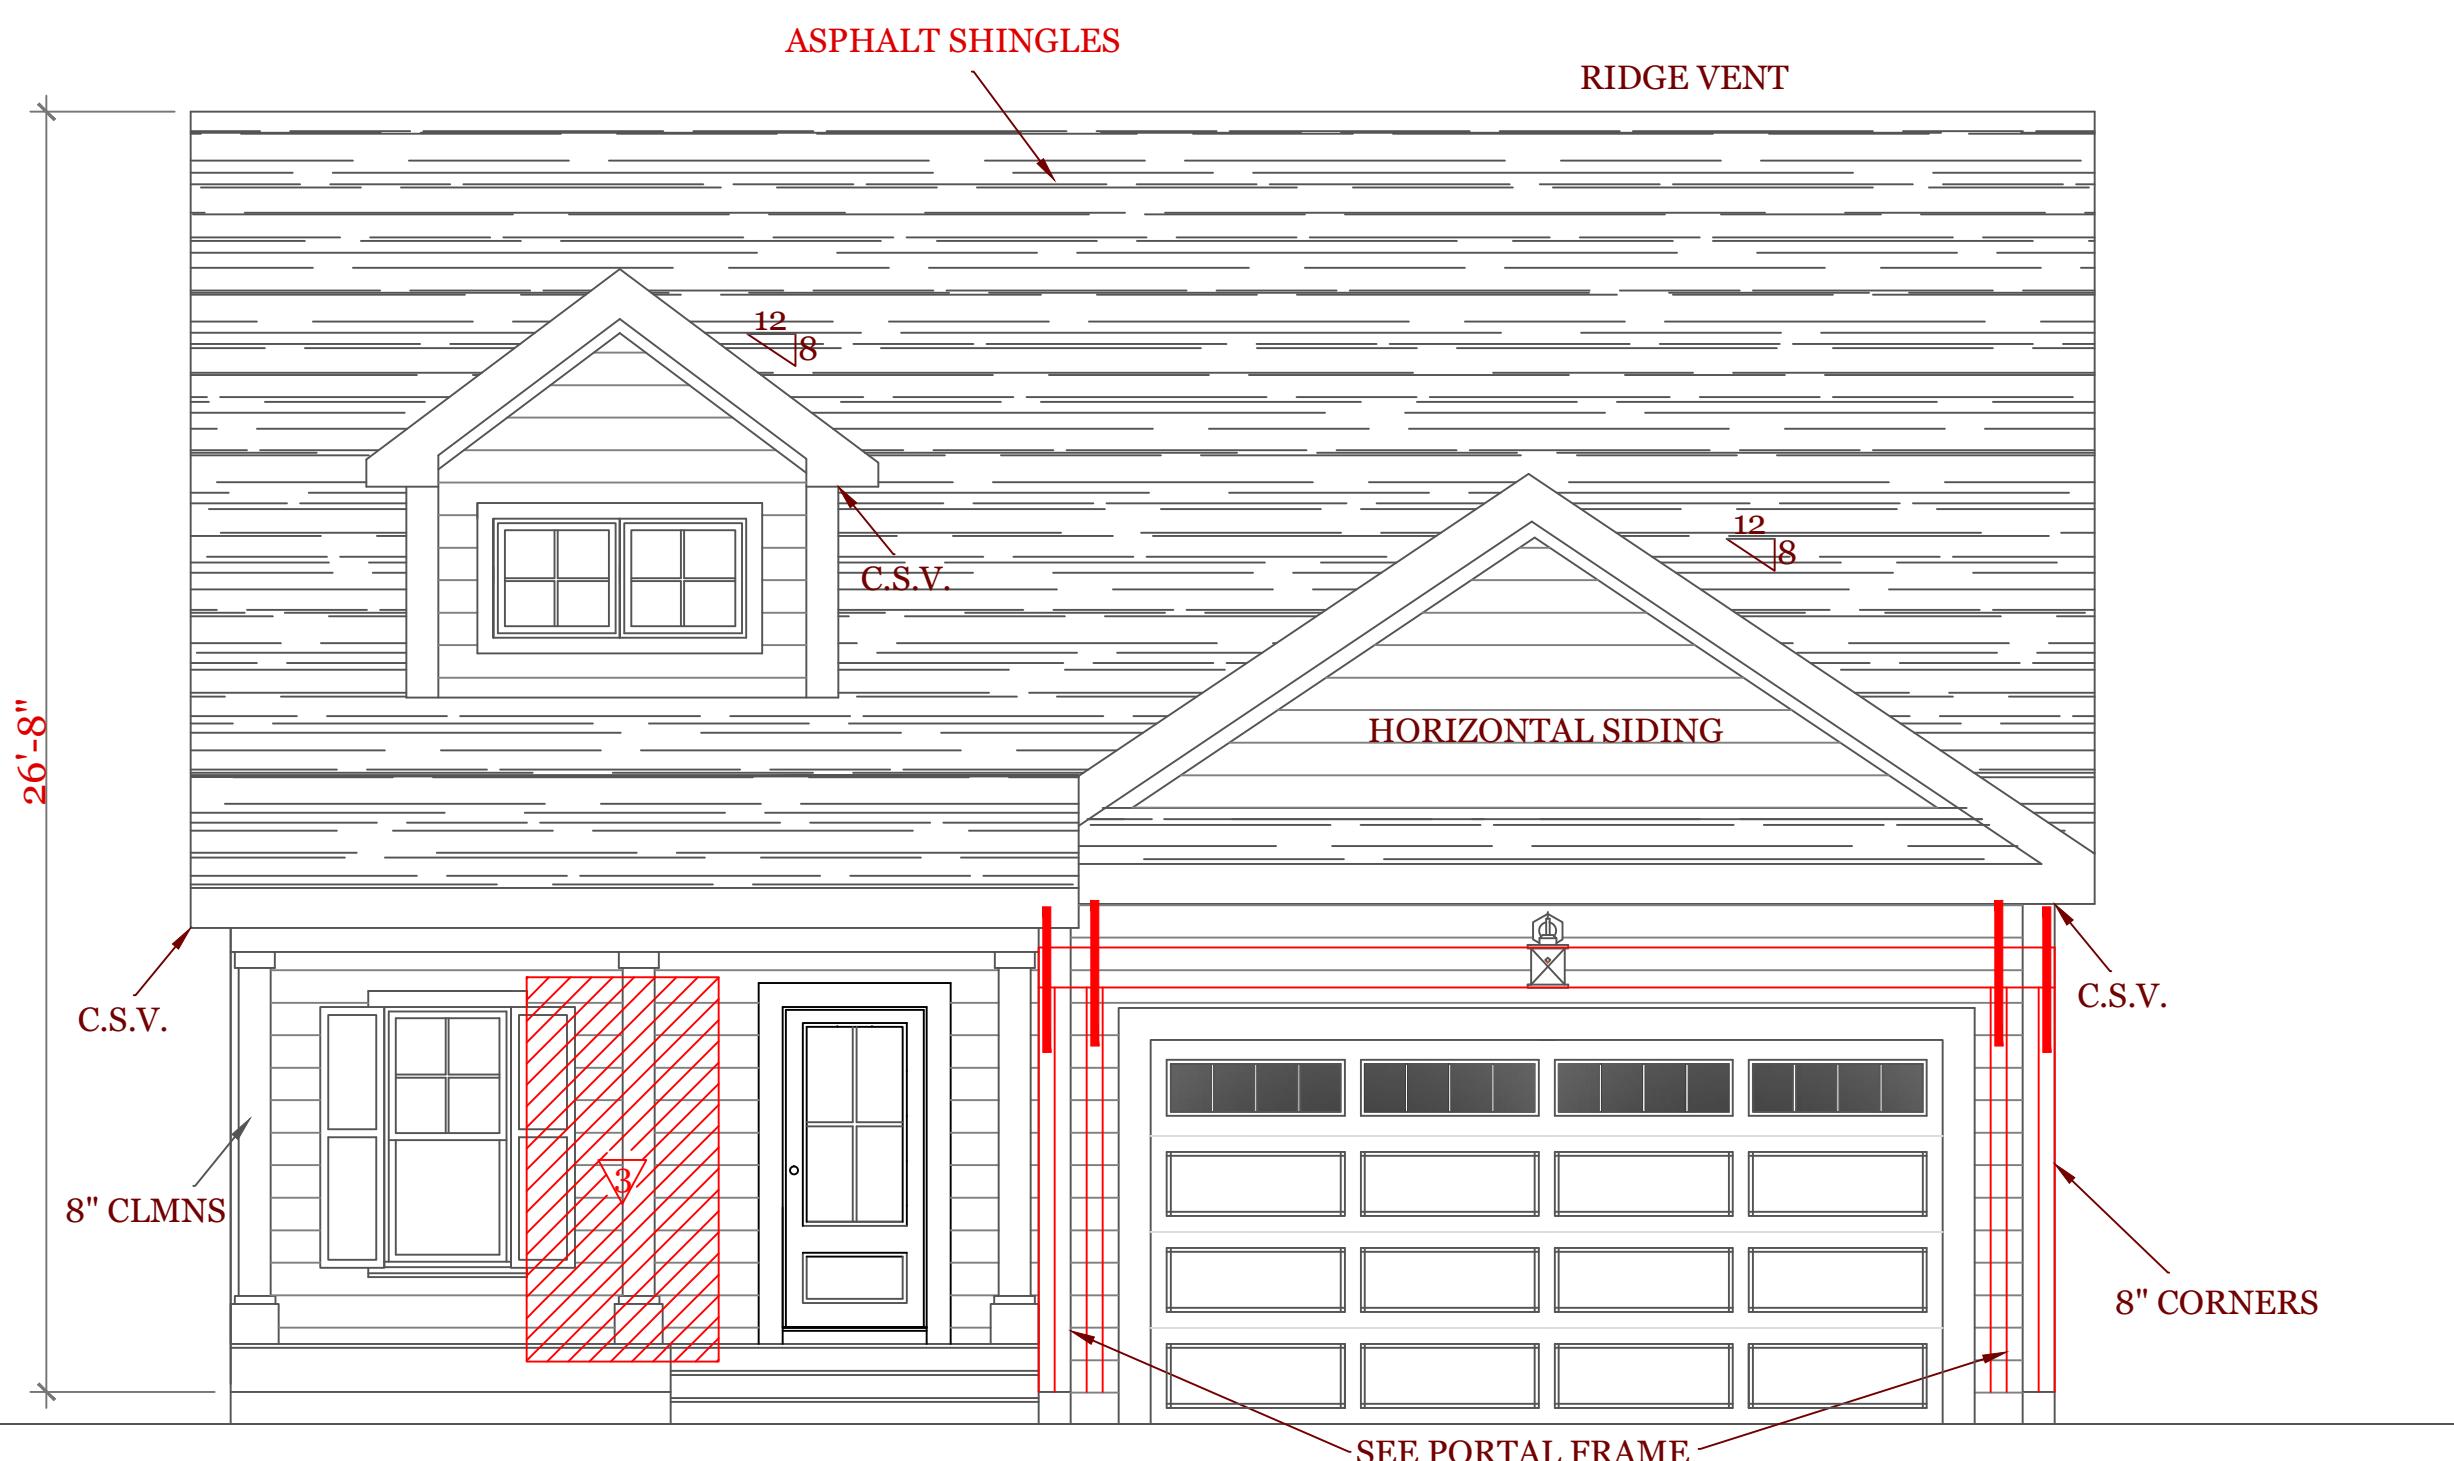

LEFT SIDE ELEVATION

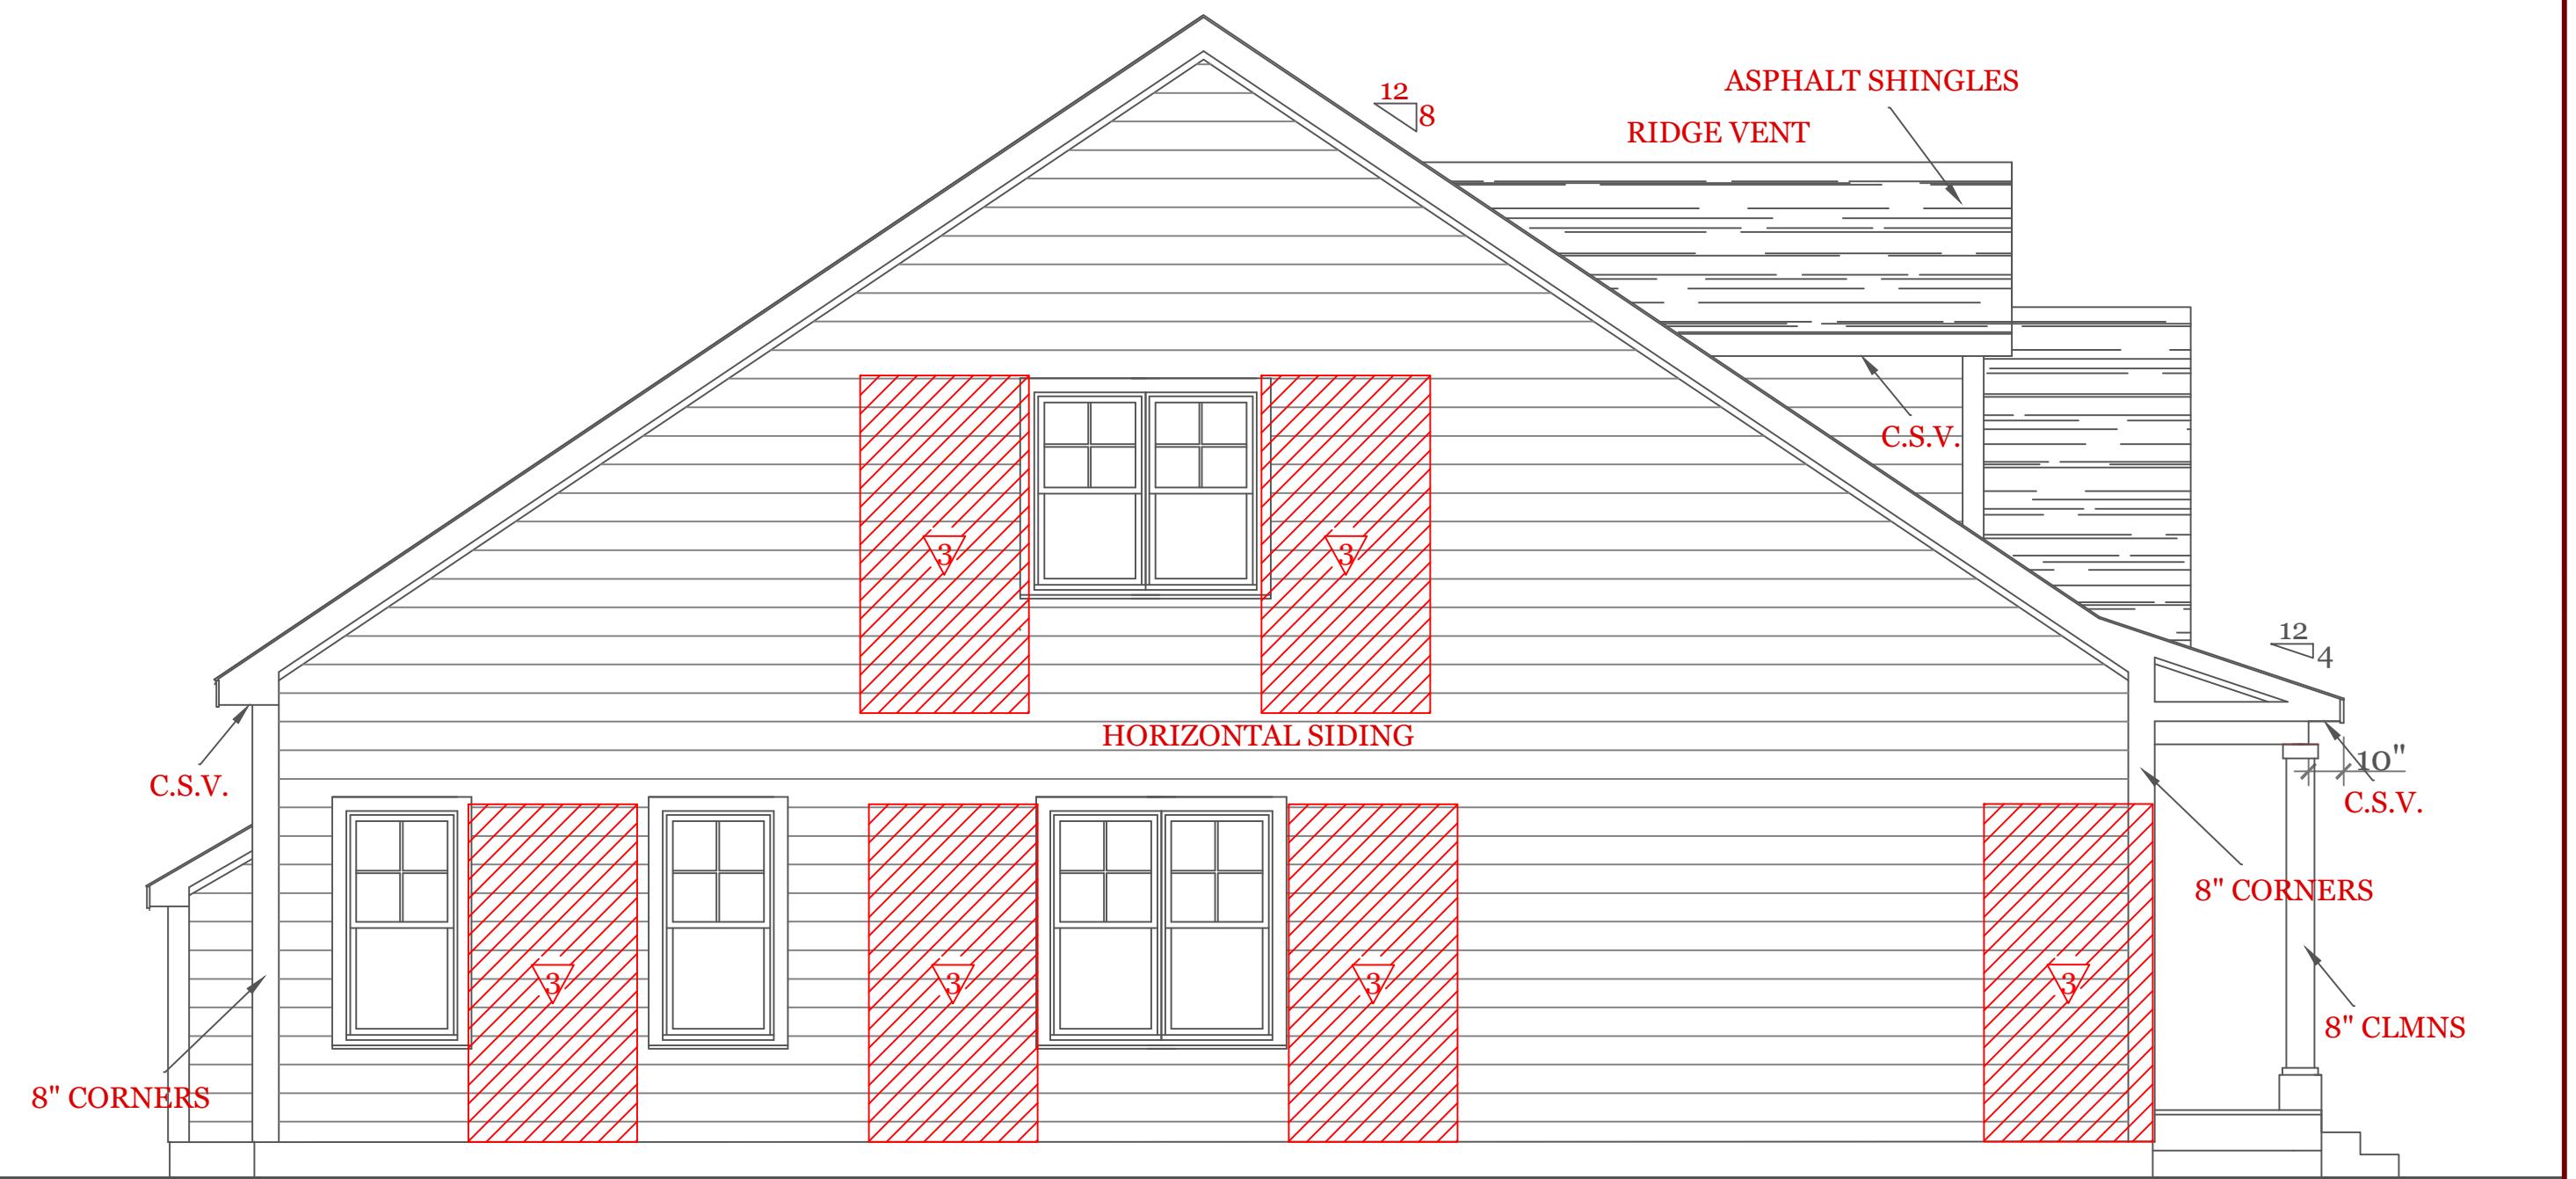

RIGHT SIDE ELEVATION

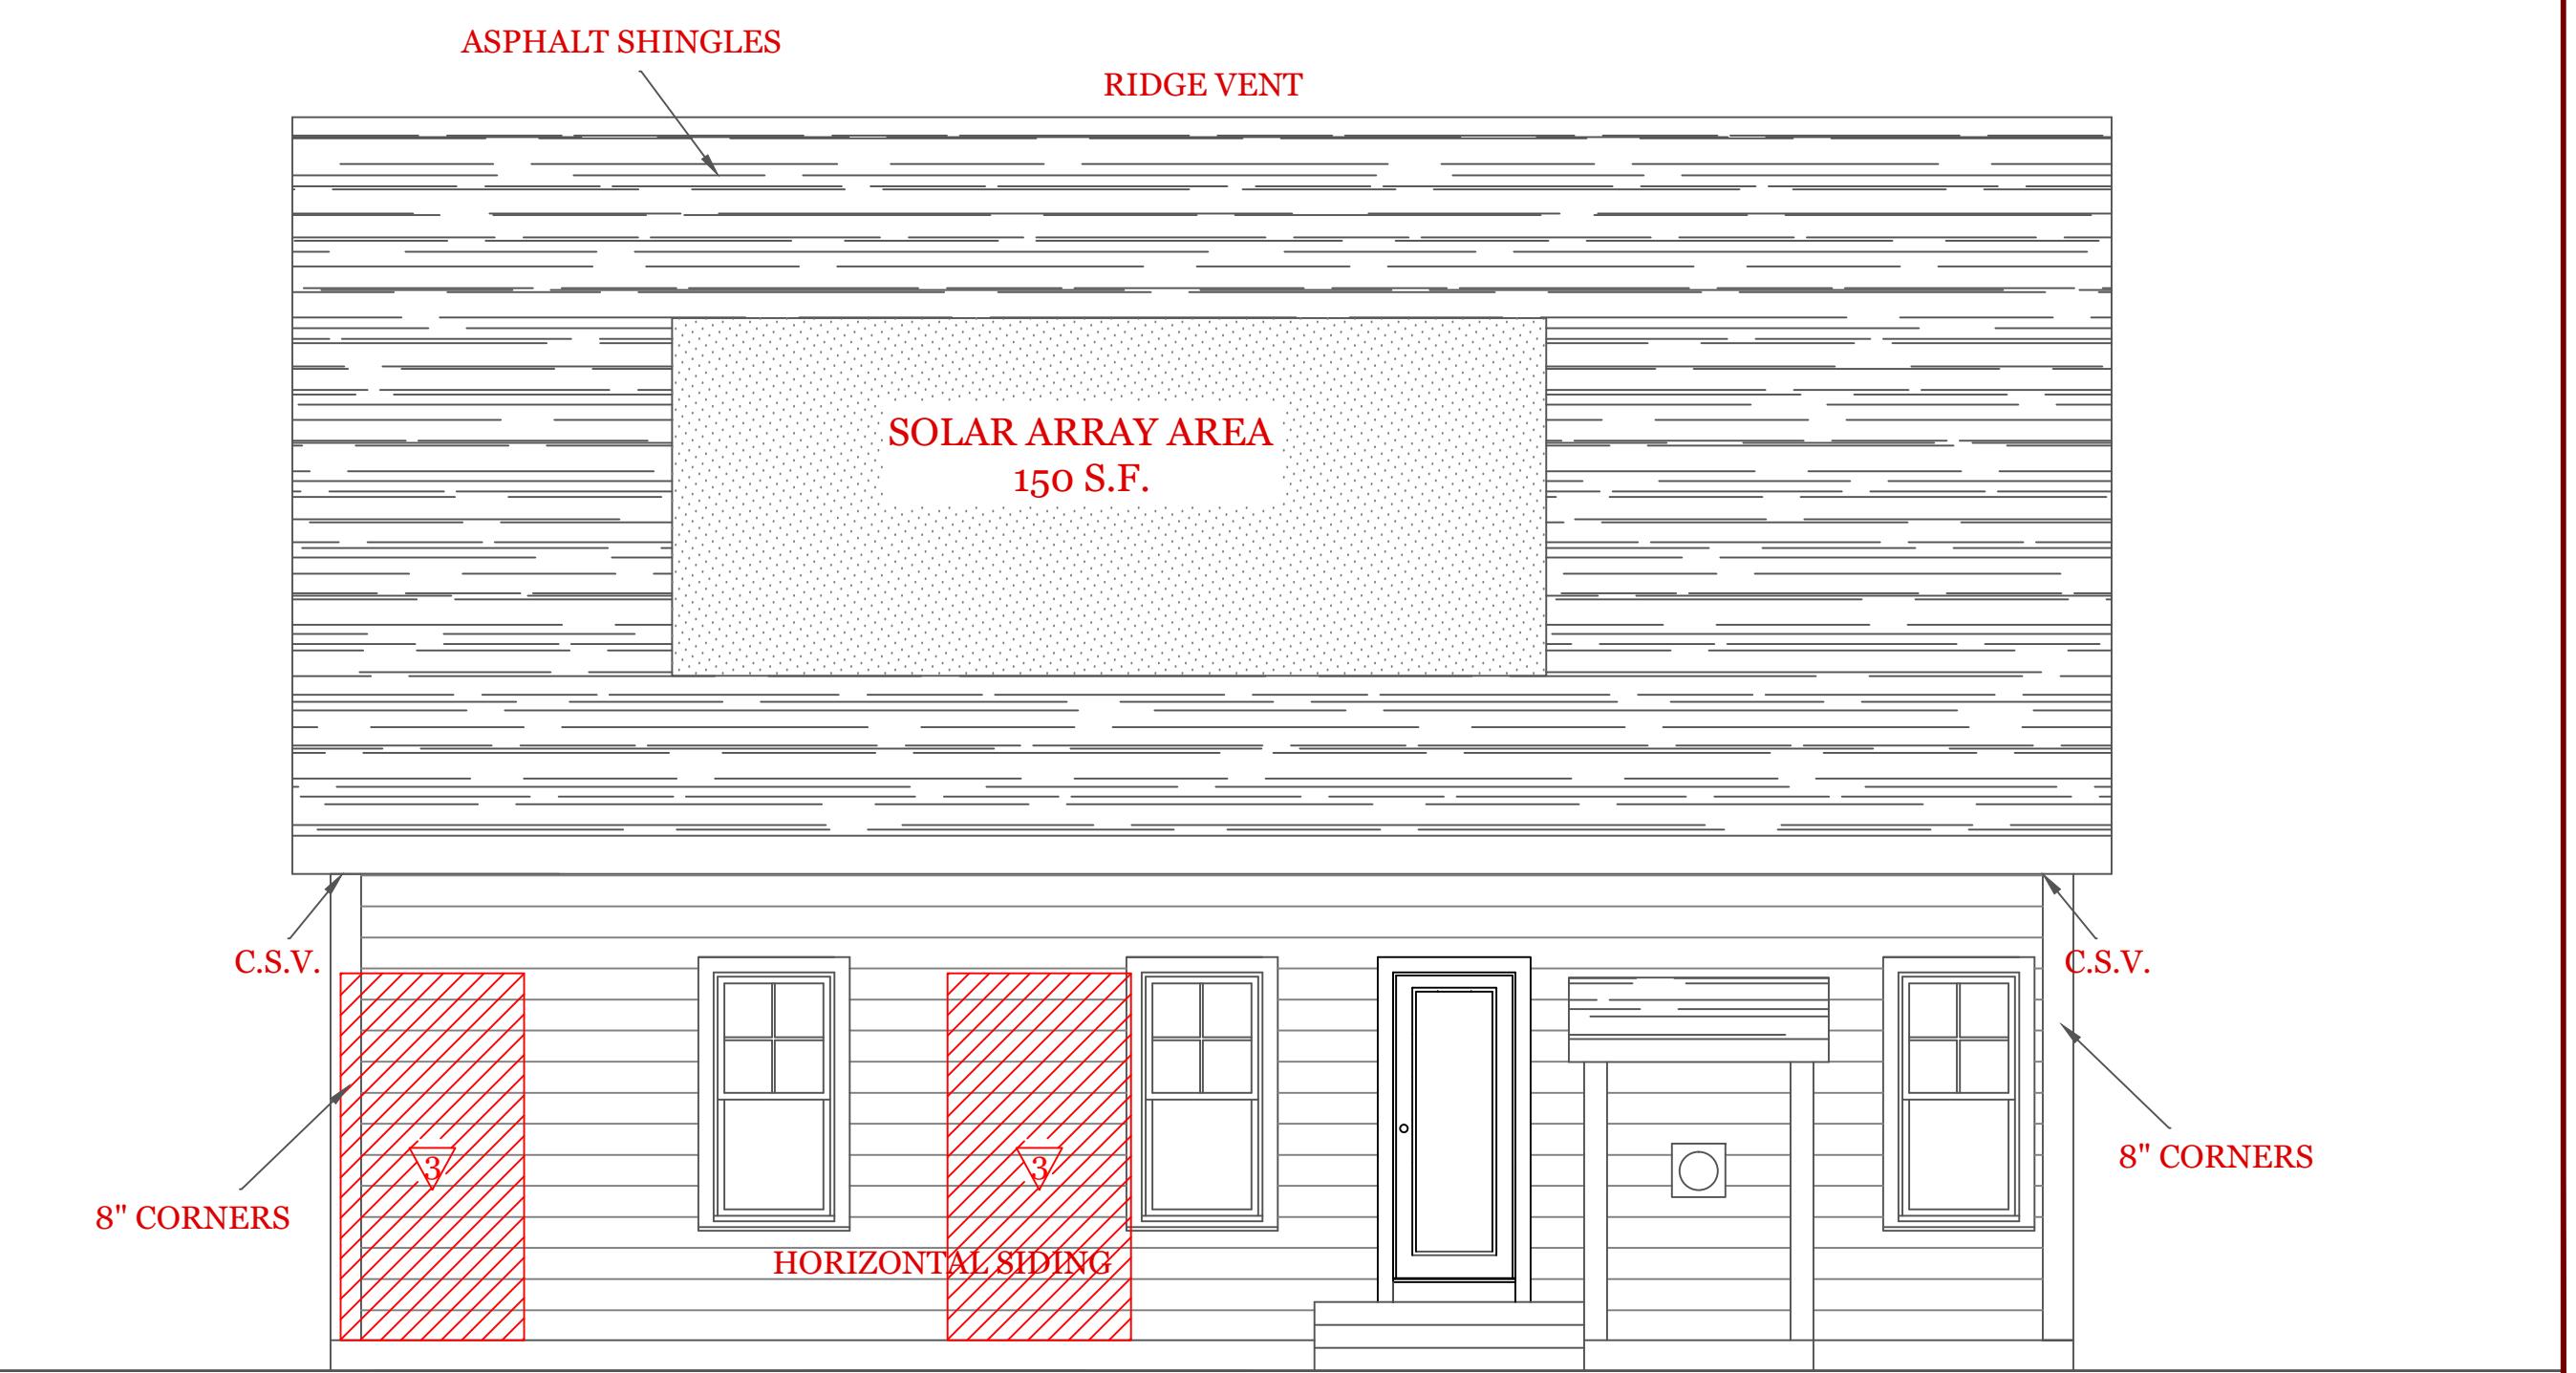

REAR ELEVATION

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**UNIT A - 1676 S.F.
HIGGINS FARM AT
SALISBURY HILL**

ELEVATIONS


UNIT 'A' GR

DATE:	9/20/22 R-5/5/23
SCALE:	1/4"=1'-0"
DRAWN BY:	RCS
CHECKED BY:	MJB


Sheet 1 OF 5

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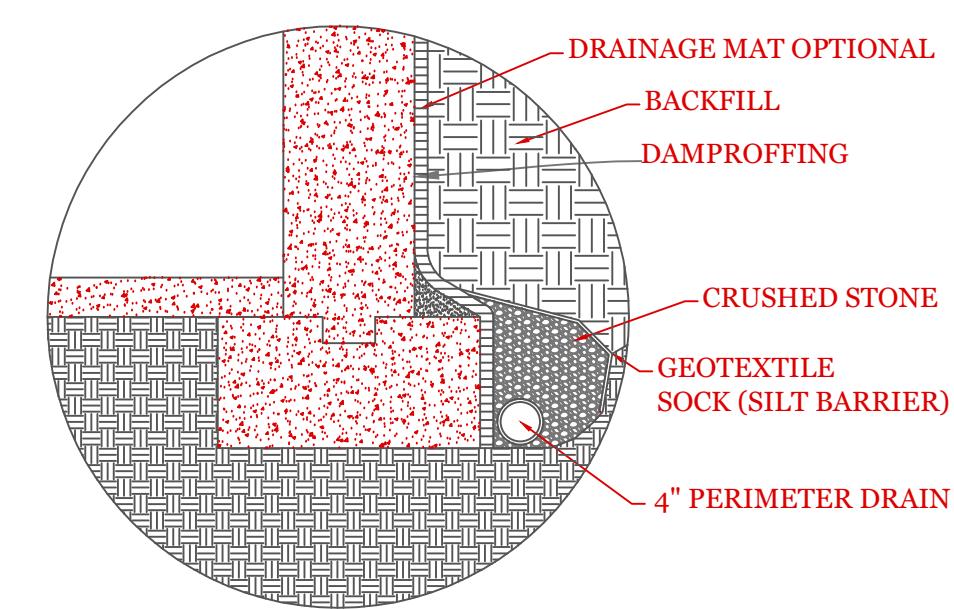
TYPICAL FOUNDATION DETAILS

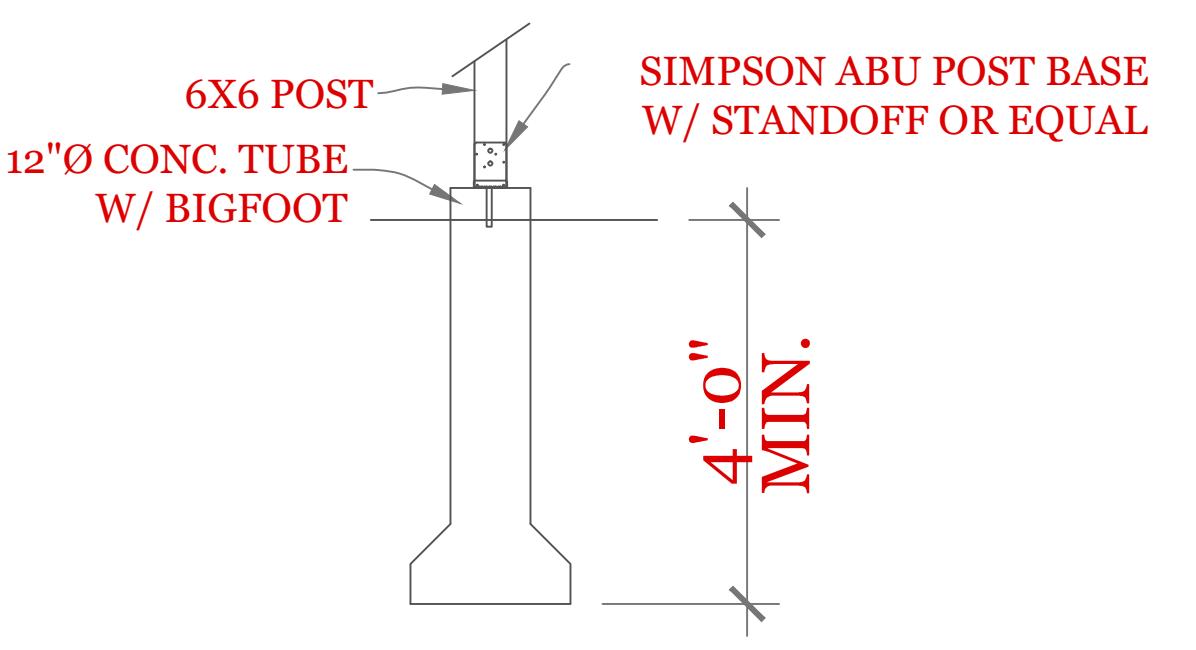

CONCRETE TUBE DETAIL

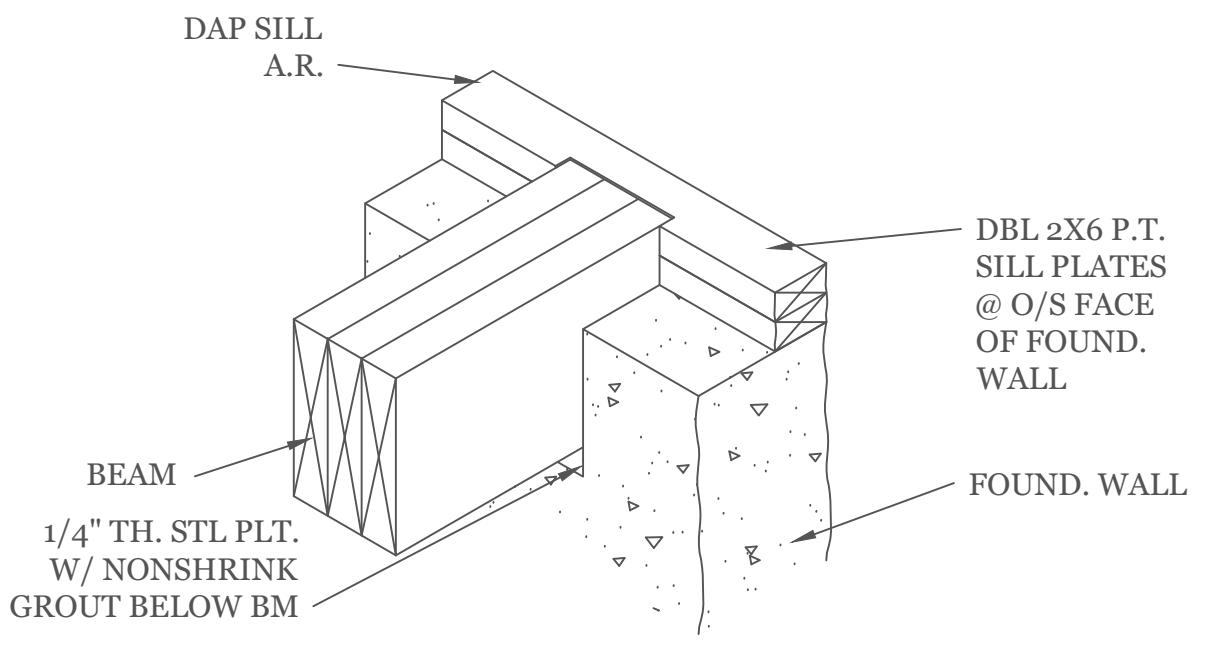


BEAM POCKET DETAIL



TYP. PERIMETER DRAIN DETAIL

NOTE: SLOPE DRAIN TO SUMP OR OUTfall

NTS

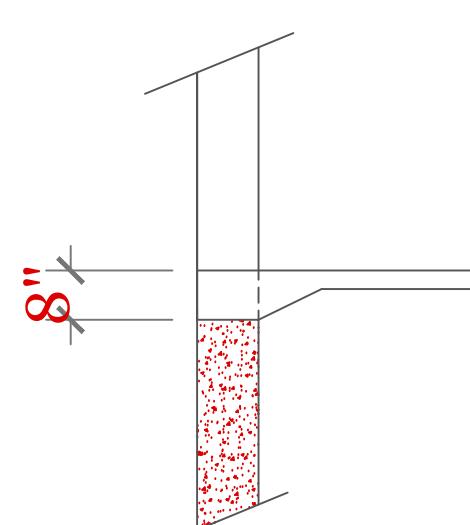




GARAGE FLOOR @ O.H.D.

3/8" = 1'-0"

SYMBOL SCHEDULE;

- [V] VENT
- [SC] SMOKE AND CARBON DETECTOR
- (S) SMOKE DETECTOR
- [H] HEAT DETECTOR
- [■] BEARING POINT W/ SQUASH BLOCK

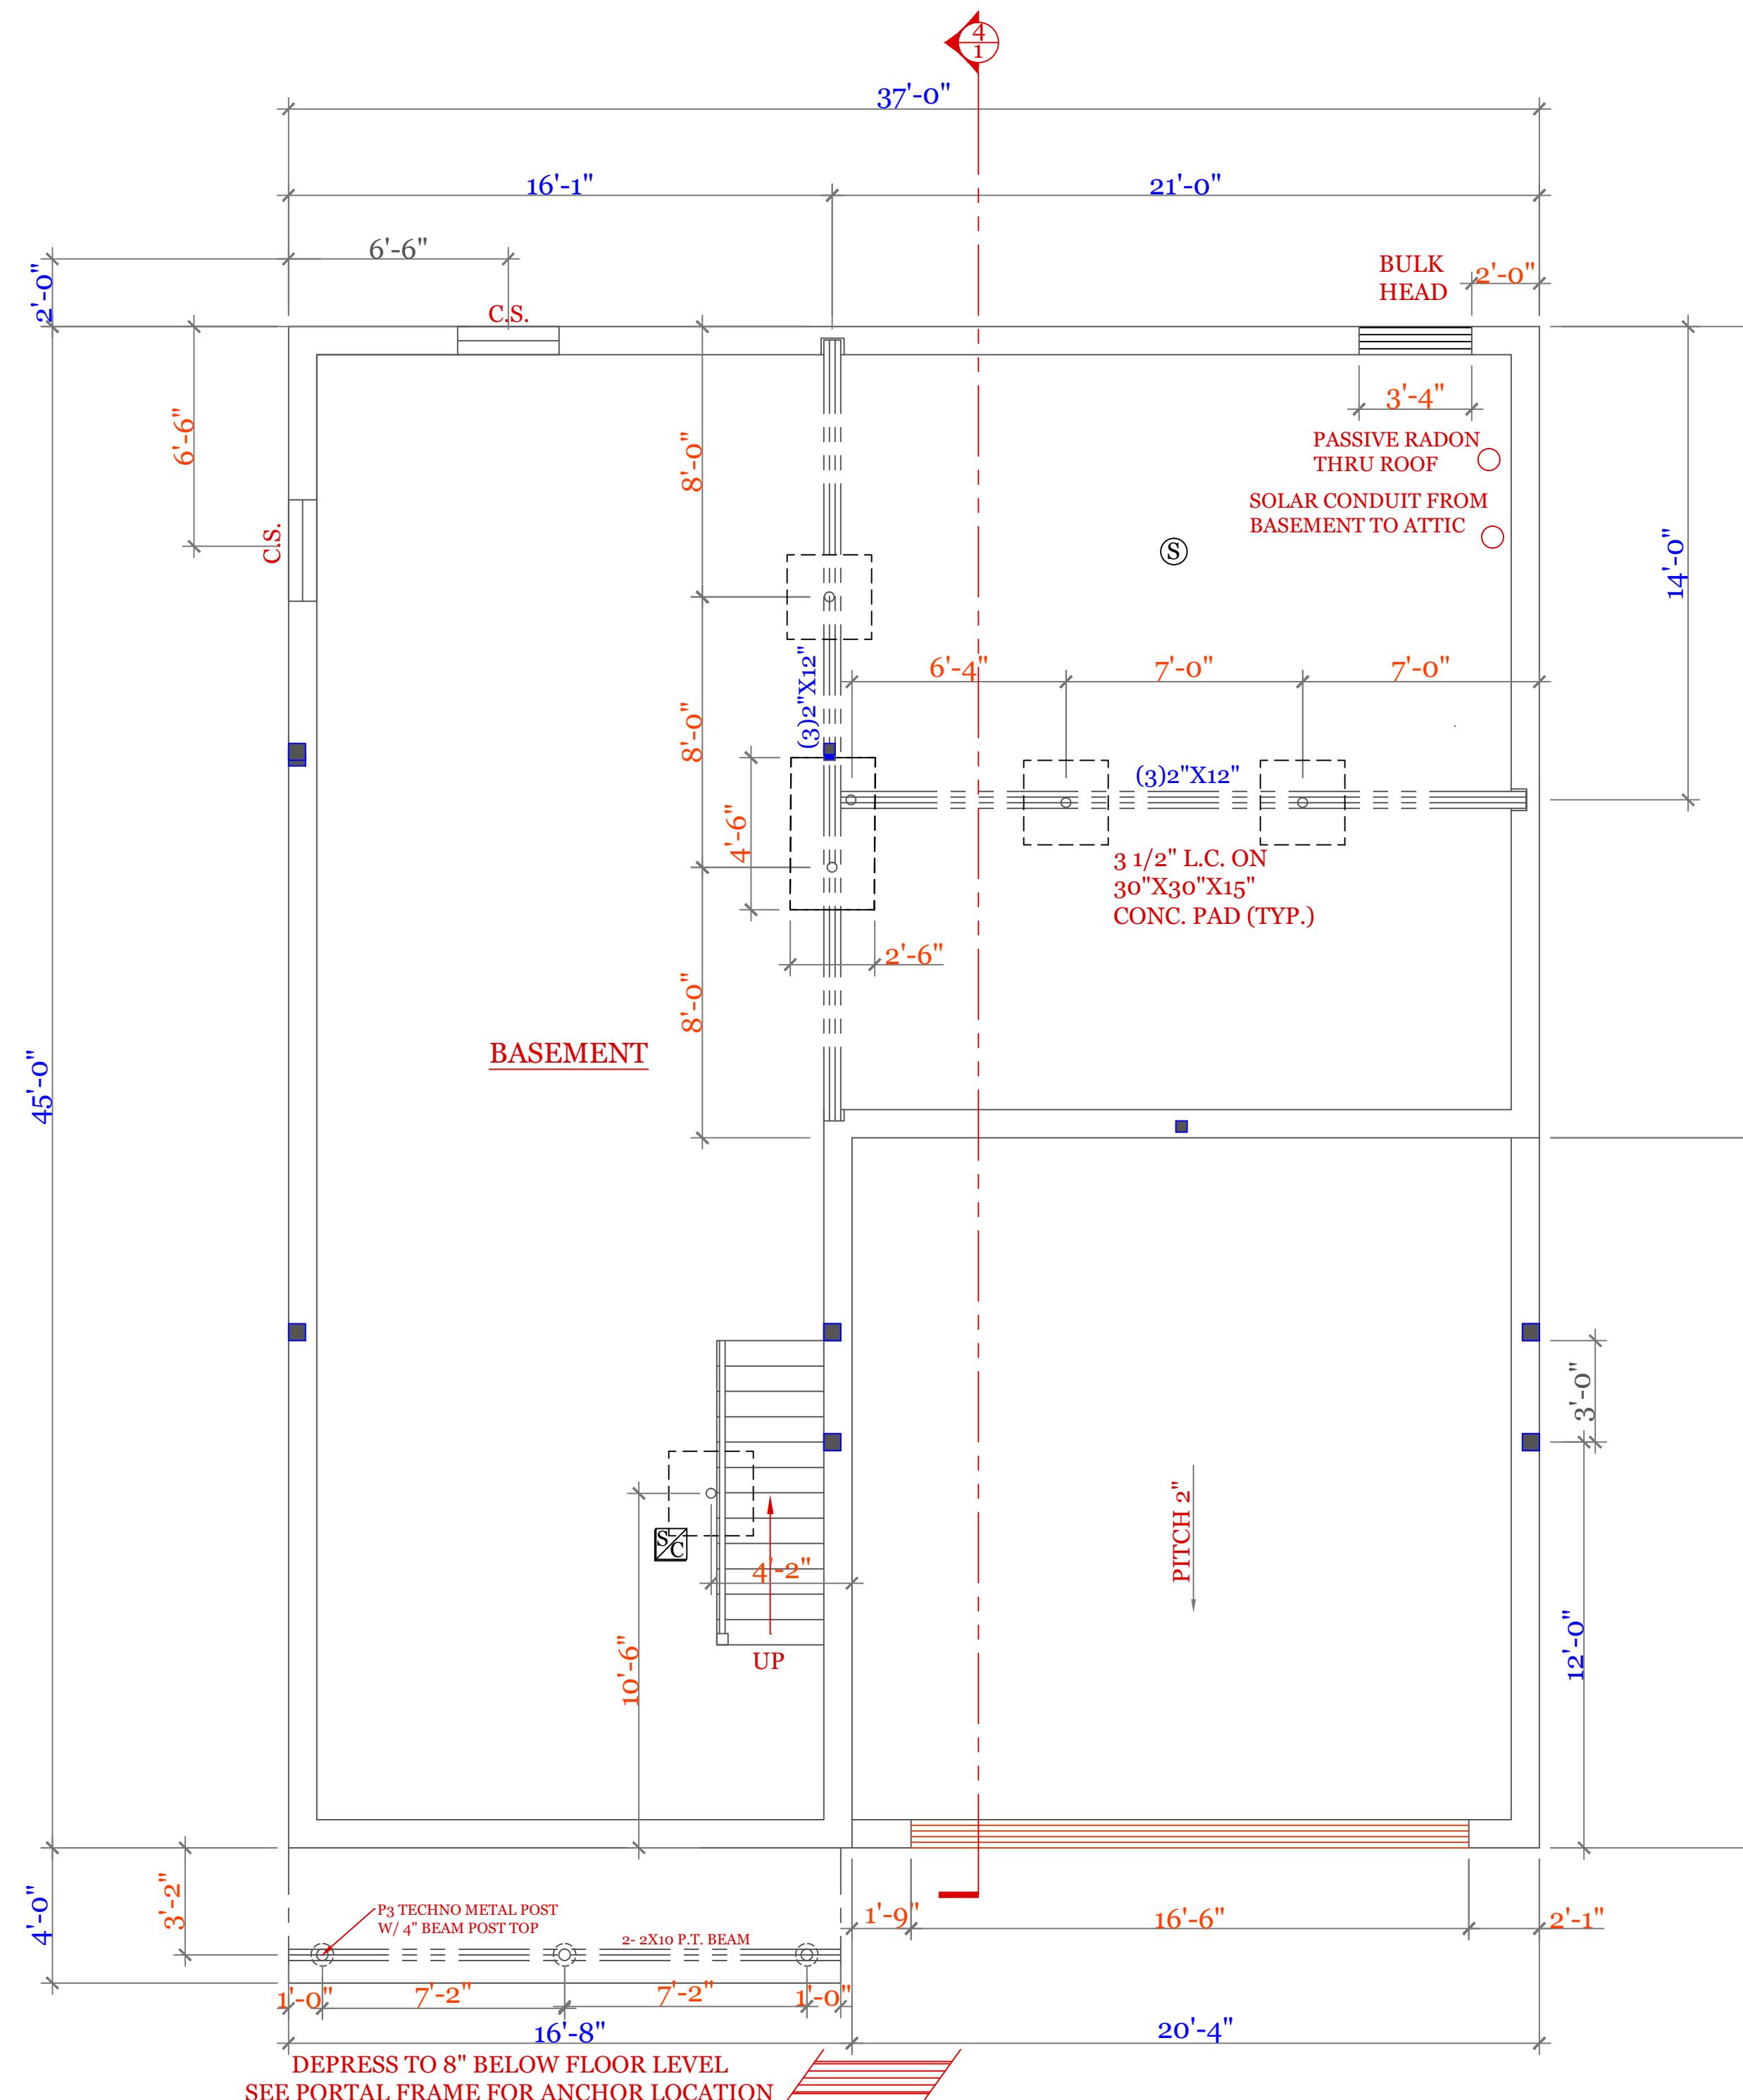

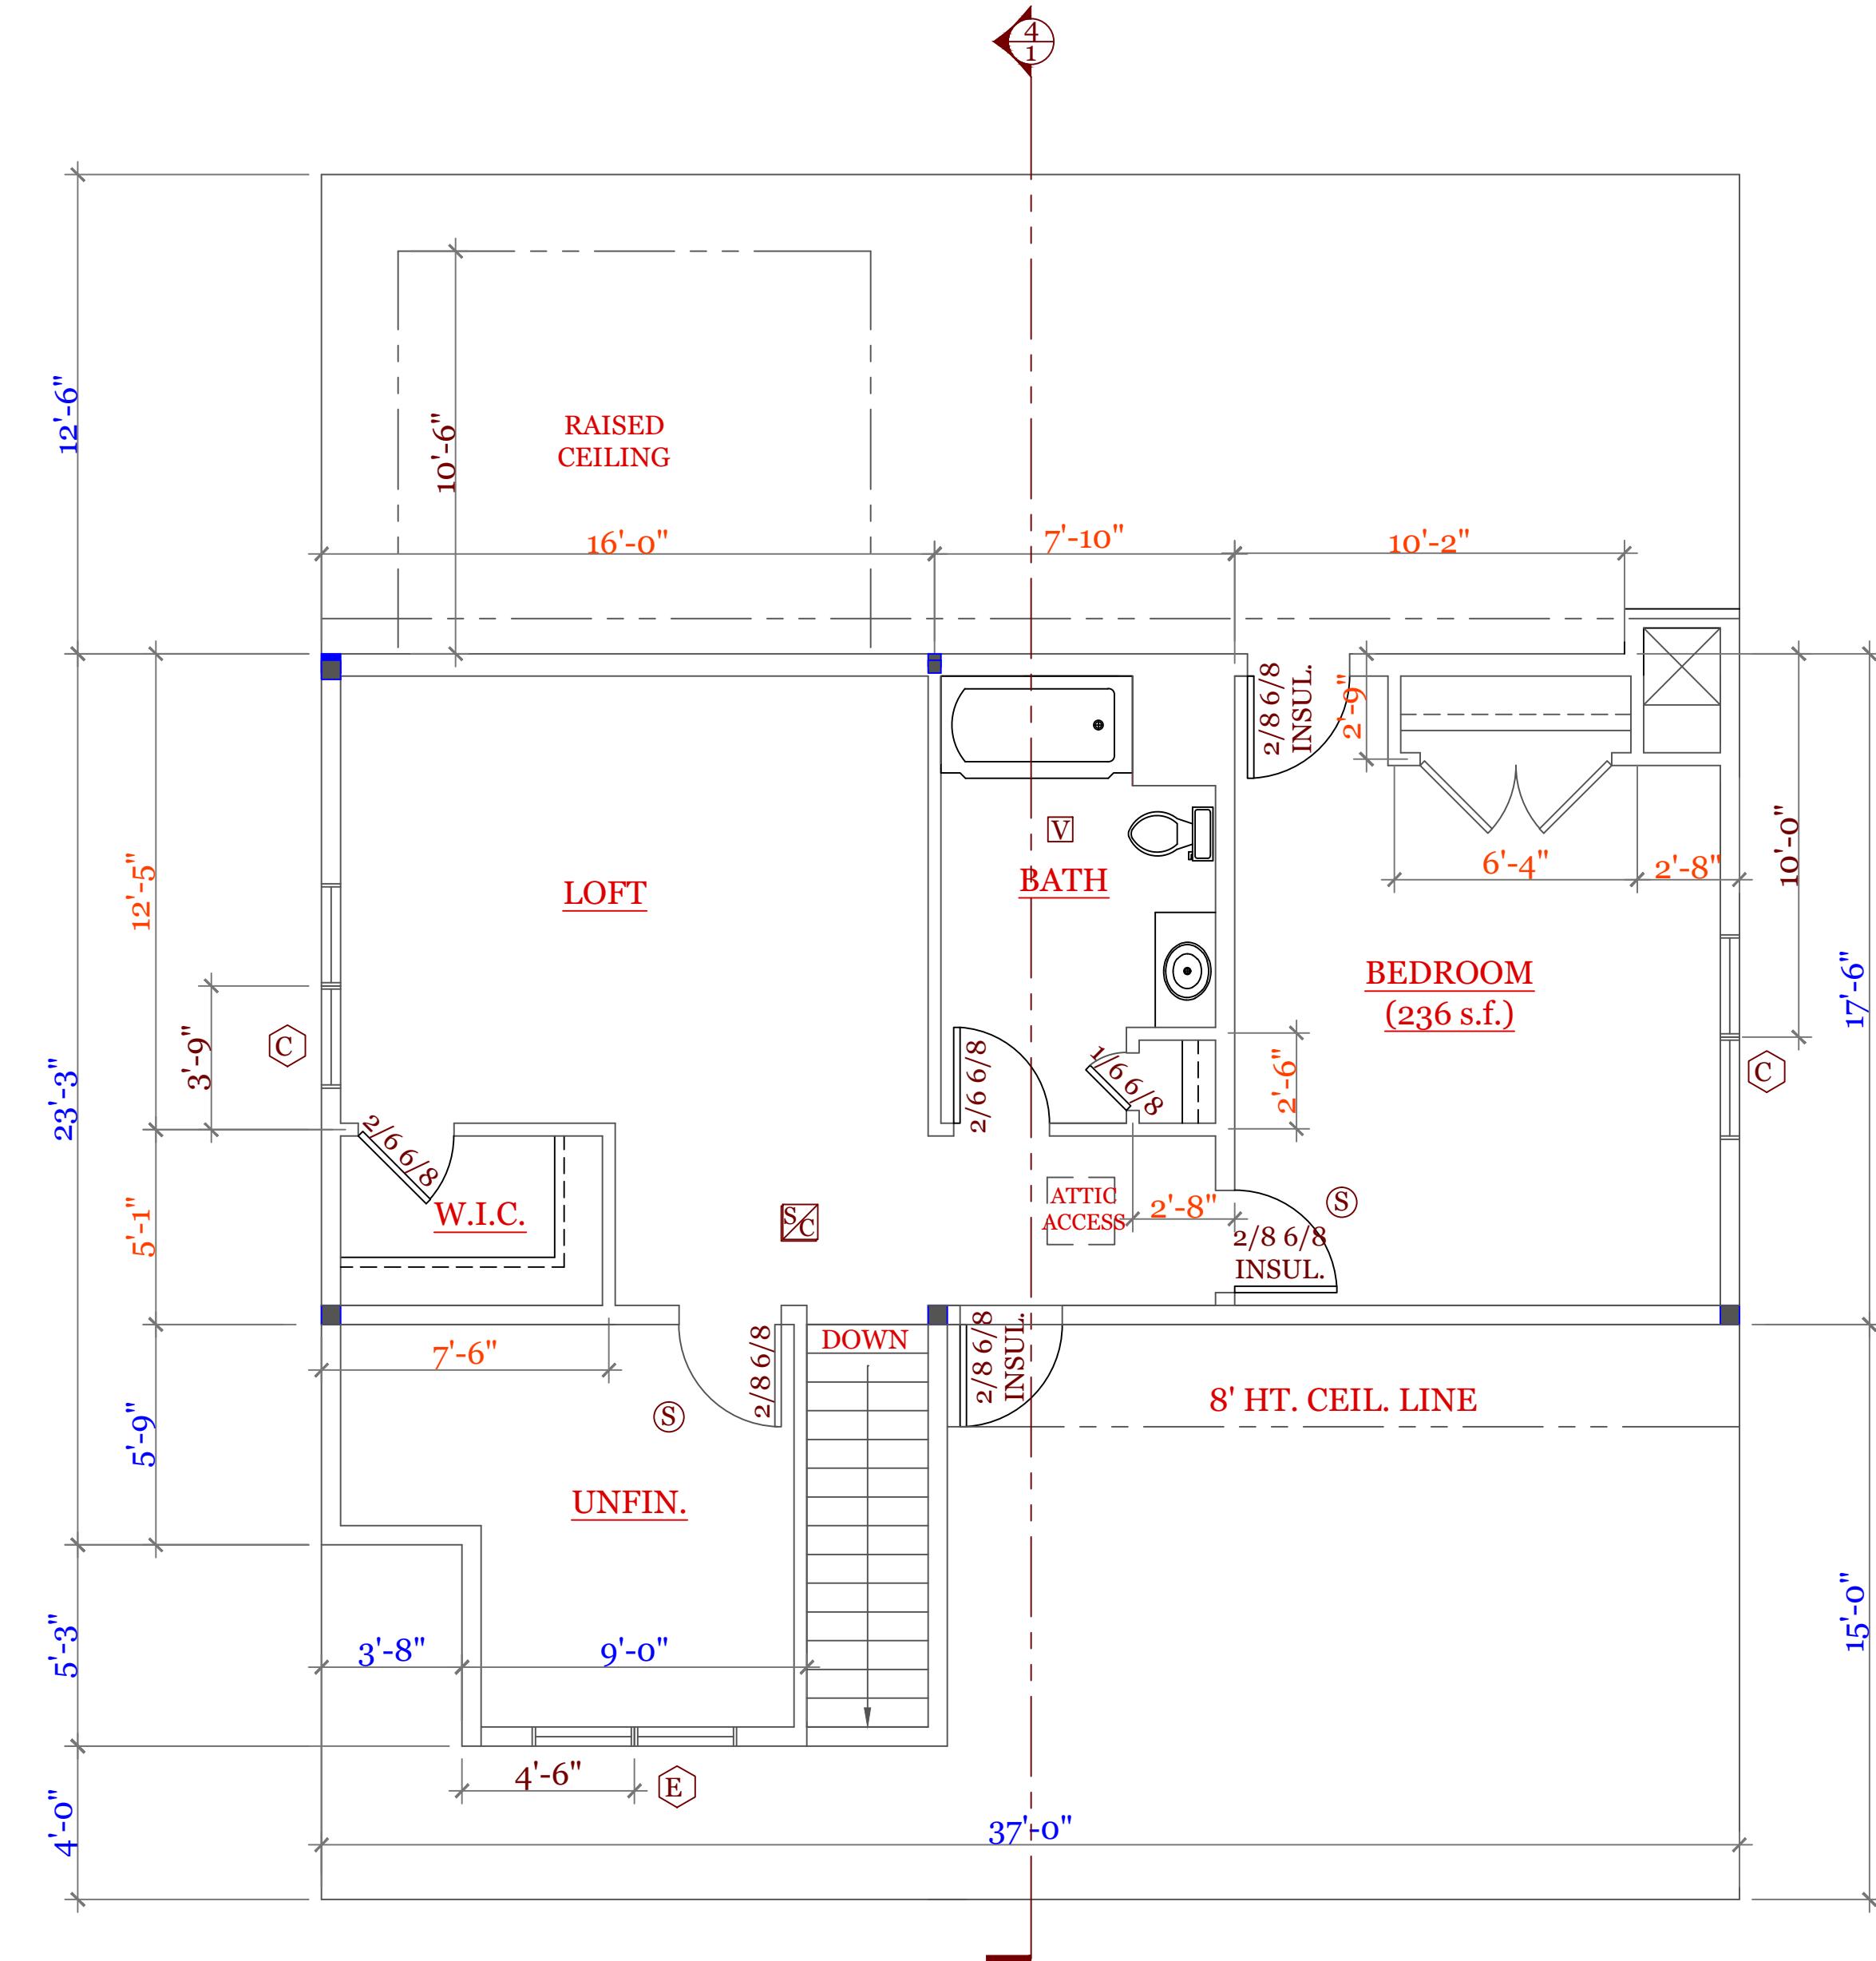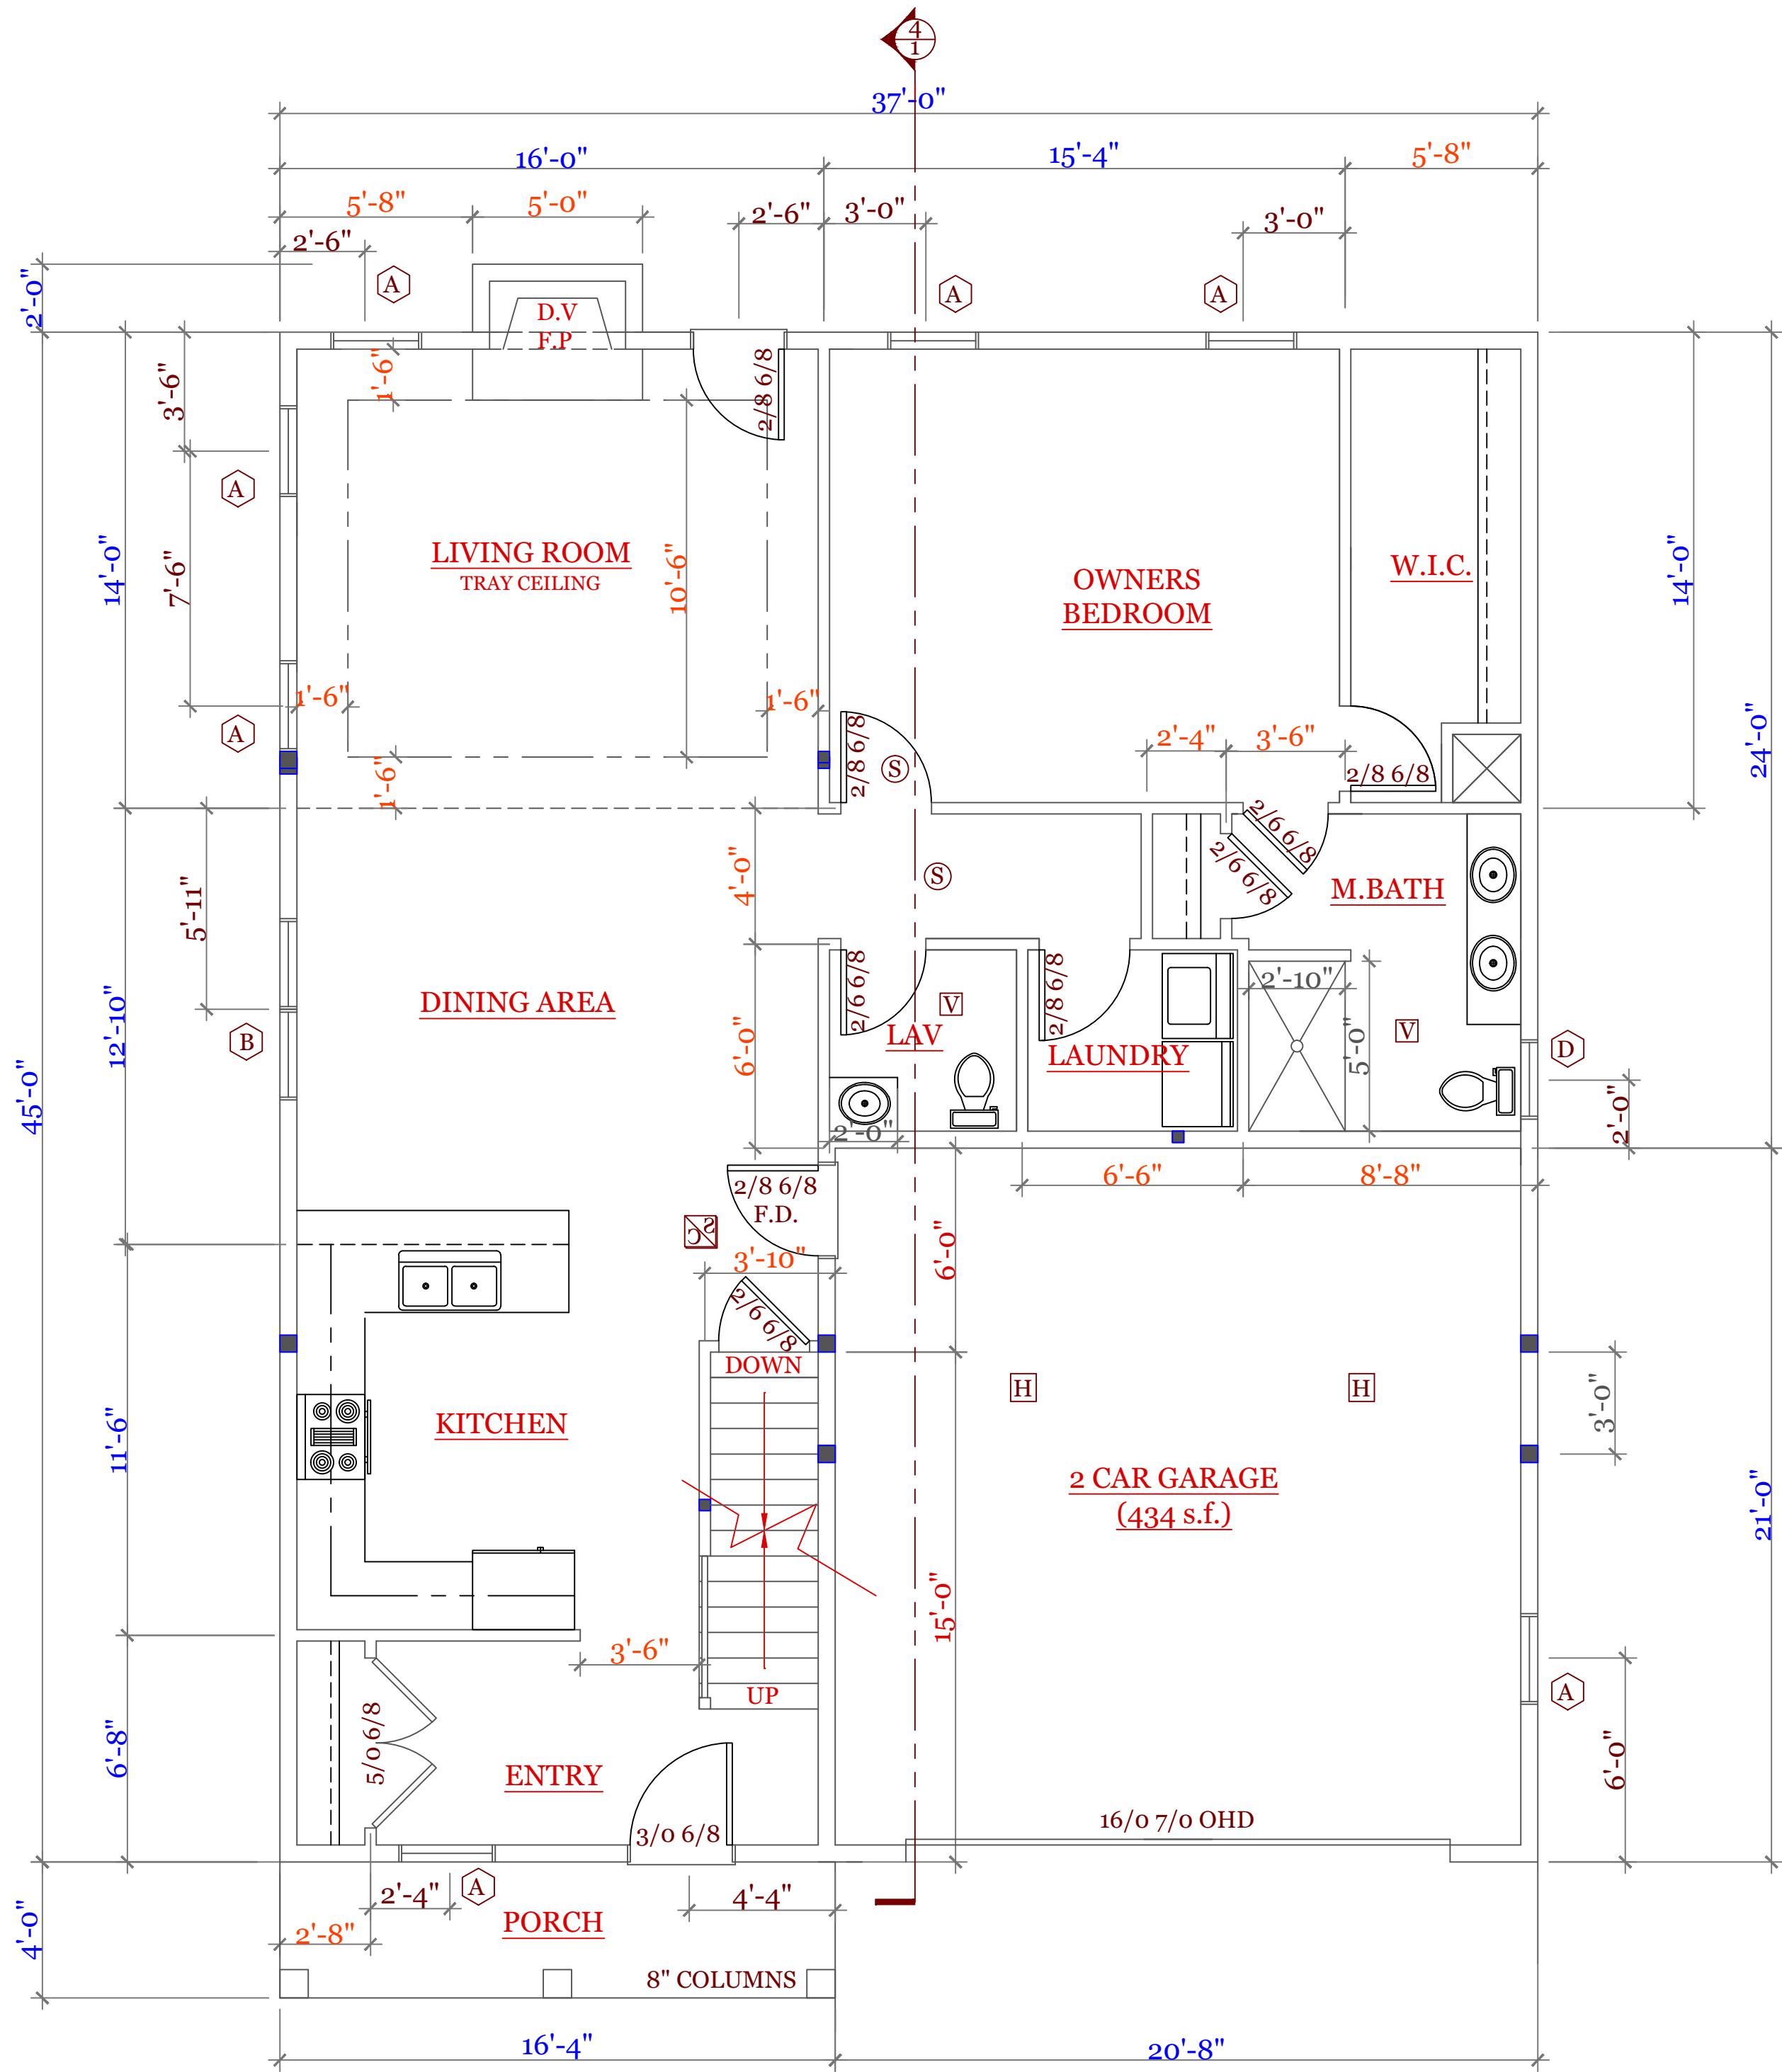

WINDOW & EXTERIOR DOOR SCHEDULE: HARVEY			
INDEX	QUA	CATALOG	ROUGH OPENING
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C	2	12000-1	5'-4 1/2" X 4'-9 1/4"
D*	1	13000-1 (T)	2'-8 1/8" X 2'-8 1/8"
E	1	A2281	5'-3 1/4" X 2'-0 5/8"
F	1	15000-1	5'-4 1/2" X 6'-10 1/2"
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NOTES: CONSULT TABLE 603.7(1) JACKS & HEADERS
*D WINDOW TEMPERED IN BATH

NOTES:

SYMBOL SCHEDULE:	
V	VENT
S	SMOKE AND CARBON DETECTOR
S	SMOKE DETECTOR
H	HEAT DETECTOR
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**UNIT 'A'
HIGGINS FARM AT
SALISBURY HILL**

**FIRST & SECOND
FLOOR PLAN
WINDOW SCHEDULE**




UNIT 'A' GR

DATE: 9/20/22 R-5/5/23
SCALE: 1/4"=1'-0"
DRAWN BY: RCS
CHECKED BY: MJB

Sheet
3 OF 5

3


TYPICAL BUILDING SECTION

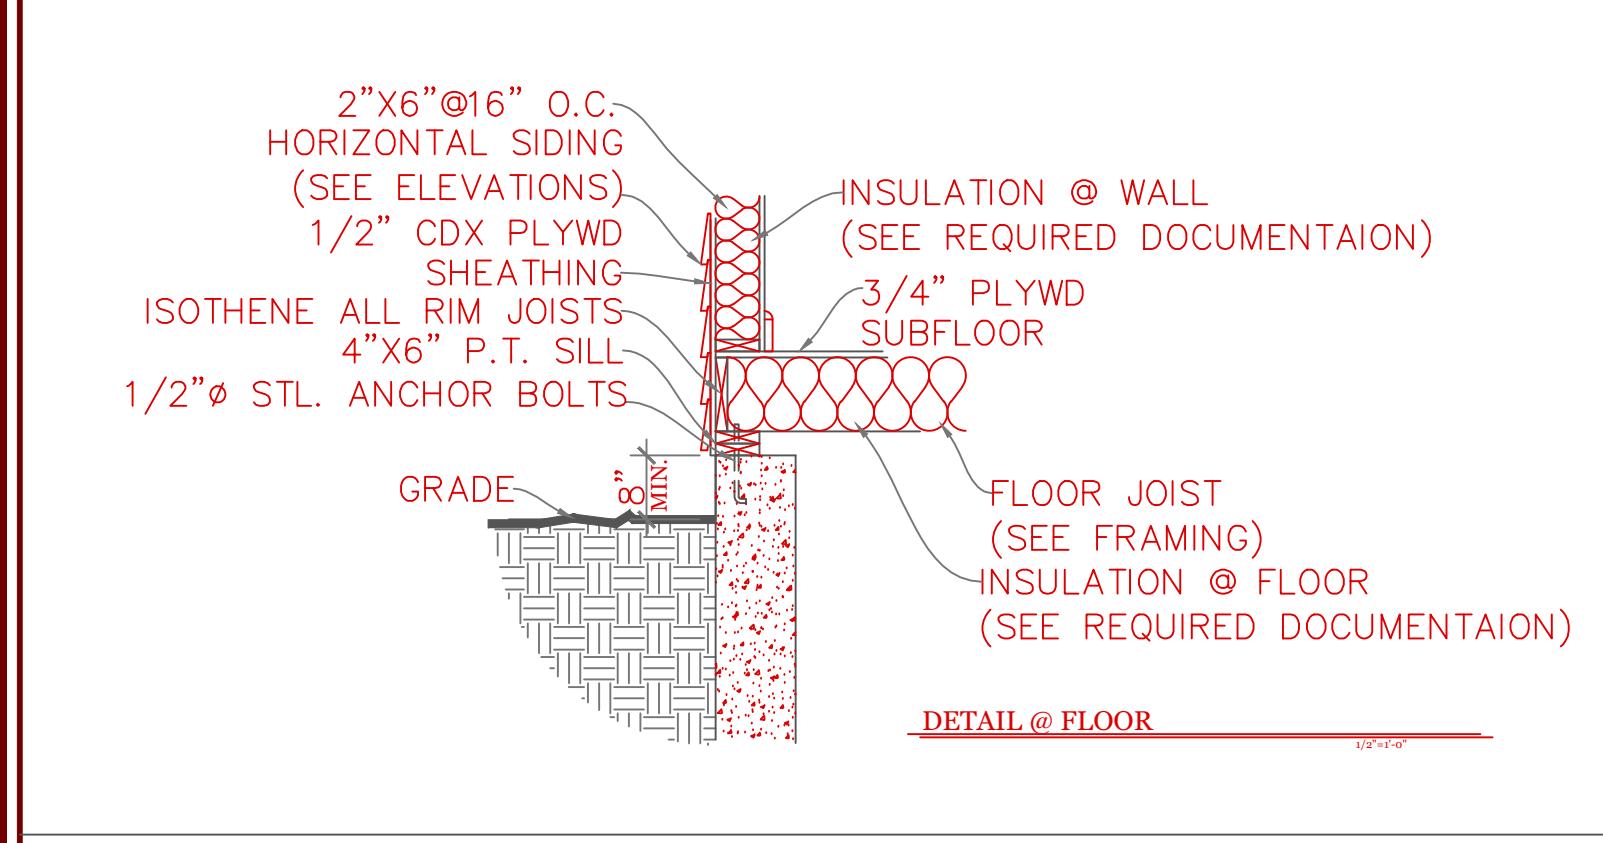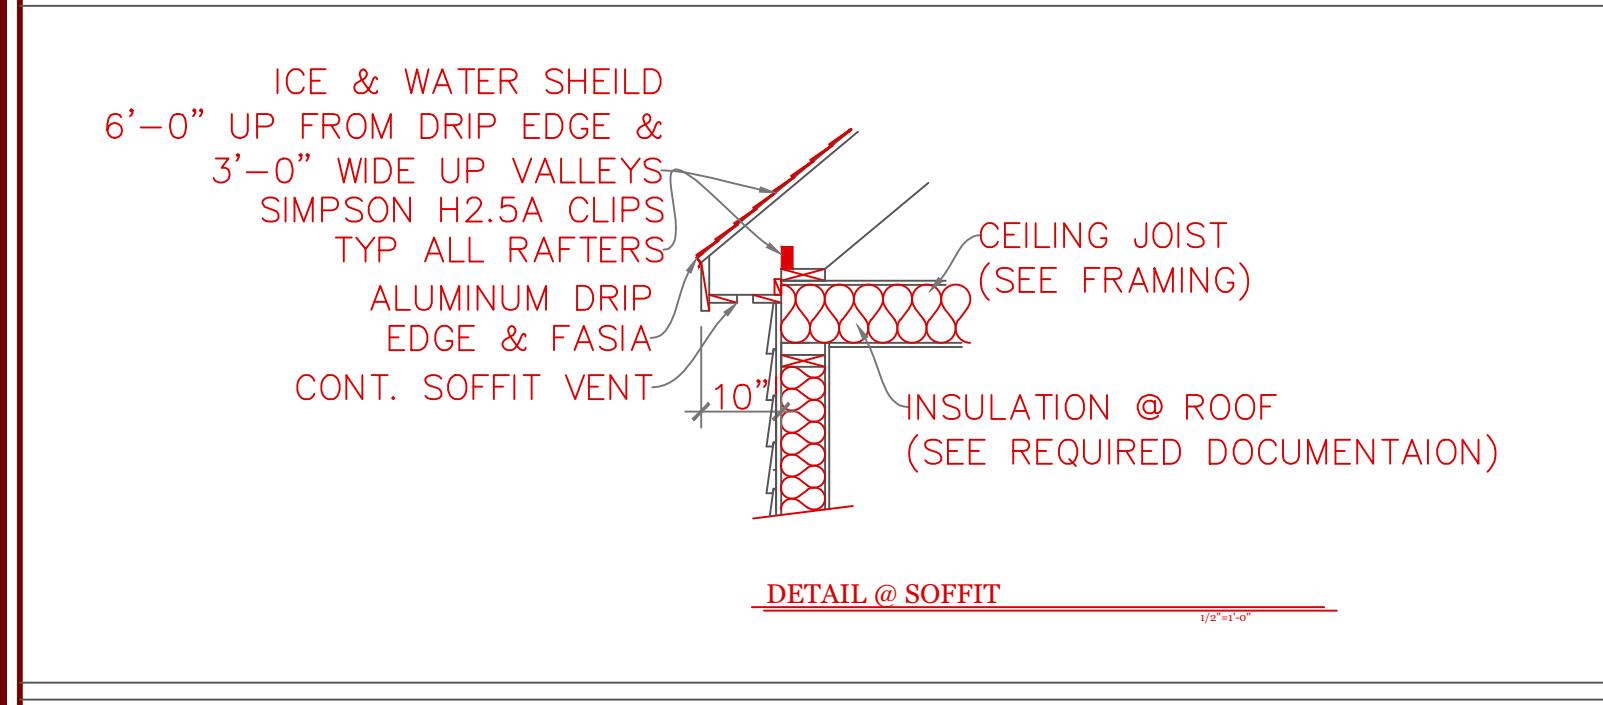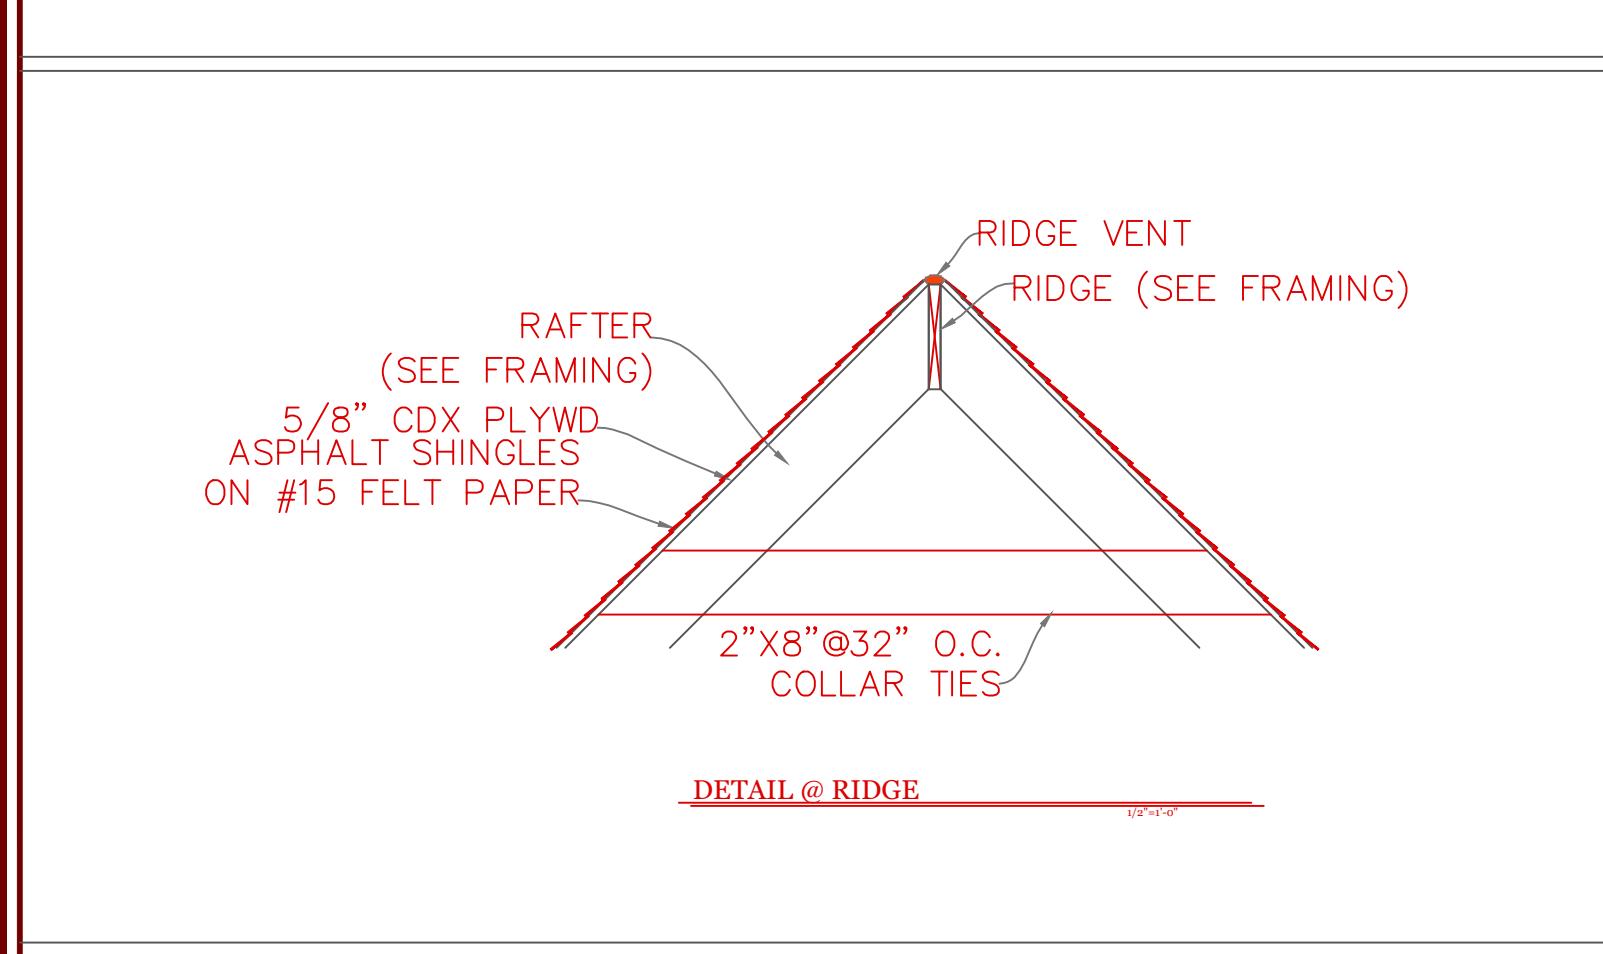

CONSTRUCTION SCHEDULE:		(UNLESS NOTED OTHERWISE ON PLAN)
1	RIDGE BOARD:	2X12
2	ROOF MATERIAL:	ASPHALT SHINGLES ON 15# ROOF FELT
3	ROOF SHEATHING	1/2" O.S.B. w/ 15# ROOF FELT
4	ROOF RAFTER:	SEE FRAMING
5	COLLAR TIES:	1X8 @ 32" O.C.
6	DRIP EDGE	ALUMINUM DRIP EDGE
7	SOFFIT:	CONT. SOFFIT VENT
8	CEILING JOIST	SEE FRAMING
9	ATTIC INSULATION	R-38
10	EXT WALL:	2"X6" @ 16" O.C.
11	EXT. SHEATHING	1/2" O.S.B. w/ HOUSE WRAP
12	EXT. FINISH	SEE ELEVATIONS
13	INSULATION@WALL	R-21
14	INTERIOR WALL	2"X4"@16"O.C.
15	SUB FLOOR:	3/4" ADVANTEK GLUED & NAILED
16	JOIST:	SEE FRAMING.
17	SILL:	2"X6" P.T. SILL W/ 2X6 KD TOP PLATE
18	INSULATION @ FLOOR	R-30
19	ANCHOR:	1/2"Ø STL ANCHOR BOLTS
20	BEAM:	SEE FRAMING PLAN
21	COLUMN:	3 1/2" L.C.
22	FND. WALL:	10"X7'-10" CONC. WALL
23	SLAB:	SEE FOUNDATION NOTES
24	FOOTING:	20"X10" CONT. KEYED FTNG
25	CONC. PAD:	30"X30"X15" CONC. PAD

NOTES: -ISOTHEENE ALL RIM JOISTS (OPTIONAL)
-ICE & WATER SHEILD 6'-0" UP FROM DRIP EDGE
& 3'-0" WIDE UP VALLEYS
-SIMPSON H2.5A CLIPS TYP ALL RAFTERS

DUPLEX BUILDING ONLY

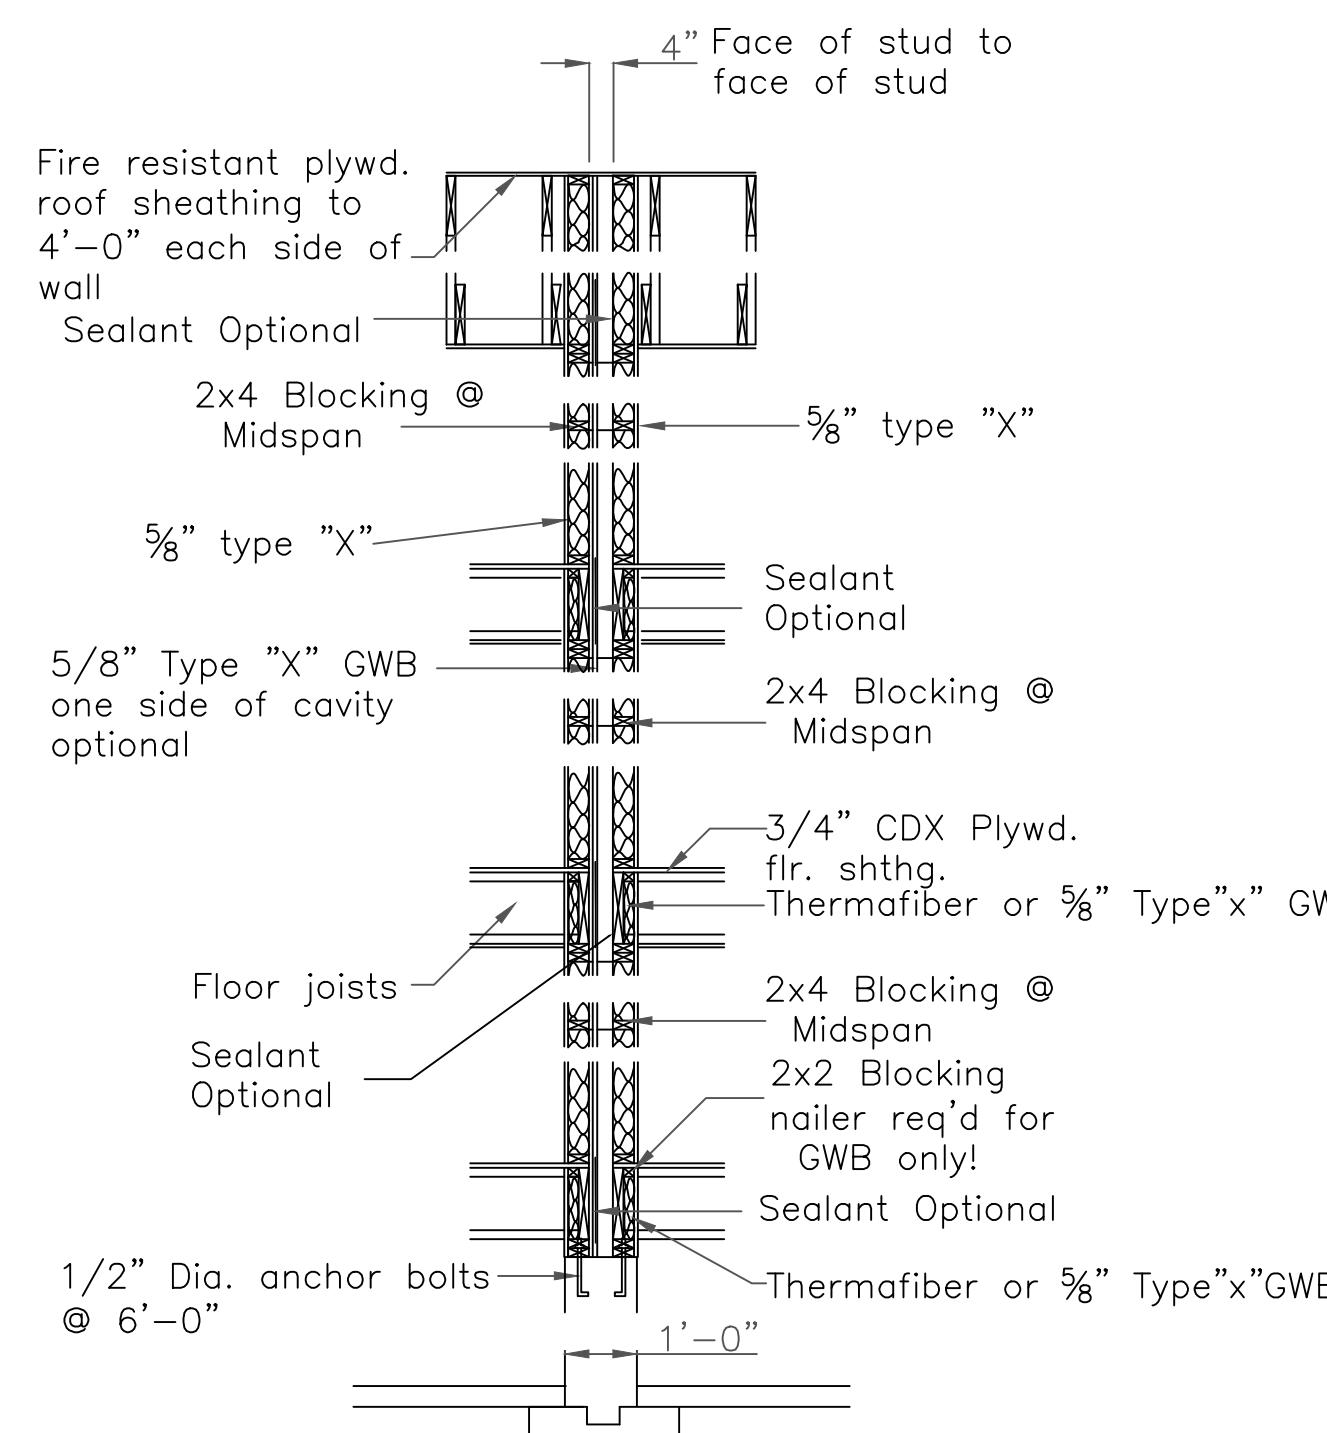

A Fire Resistance rated wall section

A For more information see
U.L. LISTING --- U-30
STC Rating = 56
Bearing wall Rating = 1 HR

TABLE 402.1.2
EXPOSURE AND FENESTRATION REQUIREMENTS BY COMPONENT

CLIMATE ZONE	FENESTRATION U-FACTOR ^b	SKYLIGHT ^b U-FACTOR	GLAZED FENESTRATION SHGC _{b,e}	CEILING R-VALUE	WOOD FRAME WALL R-VALUE	MASS WALL R-VALUE ⁱ	FLOOR R-VALUE	BASEMENT ^c WALL R-VALUE	SLAB ^d R-VALUE & DEPTH	CRAW SPAC WALL R-VALU
5 and Marine 4	0.30	0.55	NR	49	20 or 13+5 ^h	13/17	30g	15/19	10, 2 ft	15/19


2018 INTERNATIONAL ENERGY CONSERVATION CODE® AND MASSACHUSETTES 780 CMR 9TH EDITION

For SI: 1 foot = 304.8 m

- a. R-values are minimums. U-factors and SHGC are maximums. R-19 batts compressed into a nominal 2 x 6 framing cavity such that the R-value is reduced by R-1 or more shall be marked with the compressed batt R-value in addition to the full thickness R-value.
 - b. The fenestration U-factor column excludes skylights. The SHGC column applies to all glazed fenestration.
 - c. "15/19" means R-15 continuous insulated sheathing on the interior or exterior of the home or R-19 cavity insulation at the interior of the basement wall. "15/19" shall be permitted to be met with R-13 cavity insulation on the interior of the basement wall plus R-5 continuous insulated sheathing on the interior or exterior of the home. "10/13" means R-10 continuous insulated sheathing on the interior or exterior of the home or R-13 cavity insulation at the interior of the basement wall.
 - d. R-5 shall be added to the required slab edge R-values for heated slabs. Insulation depth shall be the depth of the footing or 2 feet, whichever is less in Zones 1 through 3 for heated slabs .
 - e. There are no SHGC requirements in the Marine Zone.
 - f. Basement wall insulation is not required in warm-humid locations as defined by Figure 301.1 and Table 301.1.
 - g. Or insulation sufficient to fill the framing cavity, R-19 minimum.
 - h. "13+5" means R-13 cavity insulation plus R-5 insulated sheathing. If structural sheathing covers 25 percent or less of the exterior, insulating sheathing is not required where structural sheathing is used. If structural sheathing covers more than 25 percent of exterior, structural sheathing shall be supplemented with insulated sheathing of at least R-2.
 - i. The second R-value applies when more than half the insulation is on the interior of the mass wall.
 - j. For impact rated fenestration complying with Section R301.21.2 of the *International Residential Code* or Section 1608.1.2 of the *International Building Code*, the maximum U-factor shall be 0.75 in Zone 2 and 0.65 in Zone 3.

DESIGN CRITERIA

DESIGN CRITERIA											
GROUND SNOW LOAD	WIND SPEED (MPH)	SEISMIC DESIGN	WEATHERING	FROST LINE DEPTH	TERMITE	DECAY	WINTER DESIGN TEMP	ICE SHIELD UNDERLAYMENT REQUIRED	FLOOD HAZARD	AIR FREEZING INDEX	MEAN ANNUAL TEMP
TABLE 5301.2(5)	TABLE 5301.2.(4)	N/A	FIGURE 5301.2(3)	4 ft. minimum unless engineered data shows otherwise	FIGURE 5301.2(6)	FIGURE 5301.2(7)	APPENDIX 780 CMR 120.J TABLE 120.J.3.2.1	As required by the exterior roof covering manufacturer; roof pitch and local climate must also be considered	Refer to applicable Flood Insurance Rate Map (FIRM)	Only utilized in the design and construction of frost protected shallow foundations	Only utilized in the design and construction of frost protected shallow foundation
50 psf	124 mph	N/A	SEVERE	§5403.1.4	MODERATE TO HEAVY	SLIGHT TO MODERATE	N/A	§5905.0	FIRM MAPS	SEE NOTE J TABLE 5301.2(1)	SEE NOTE TABLE 5301.2(1)

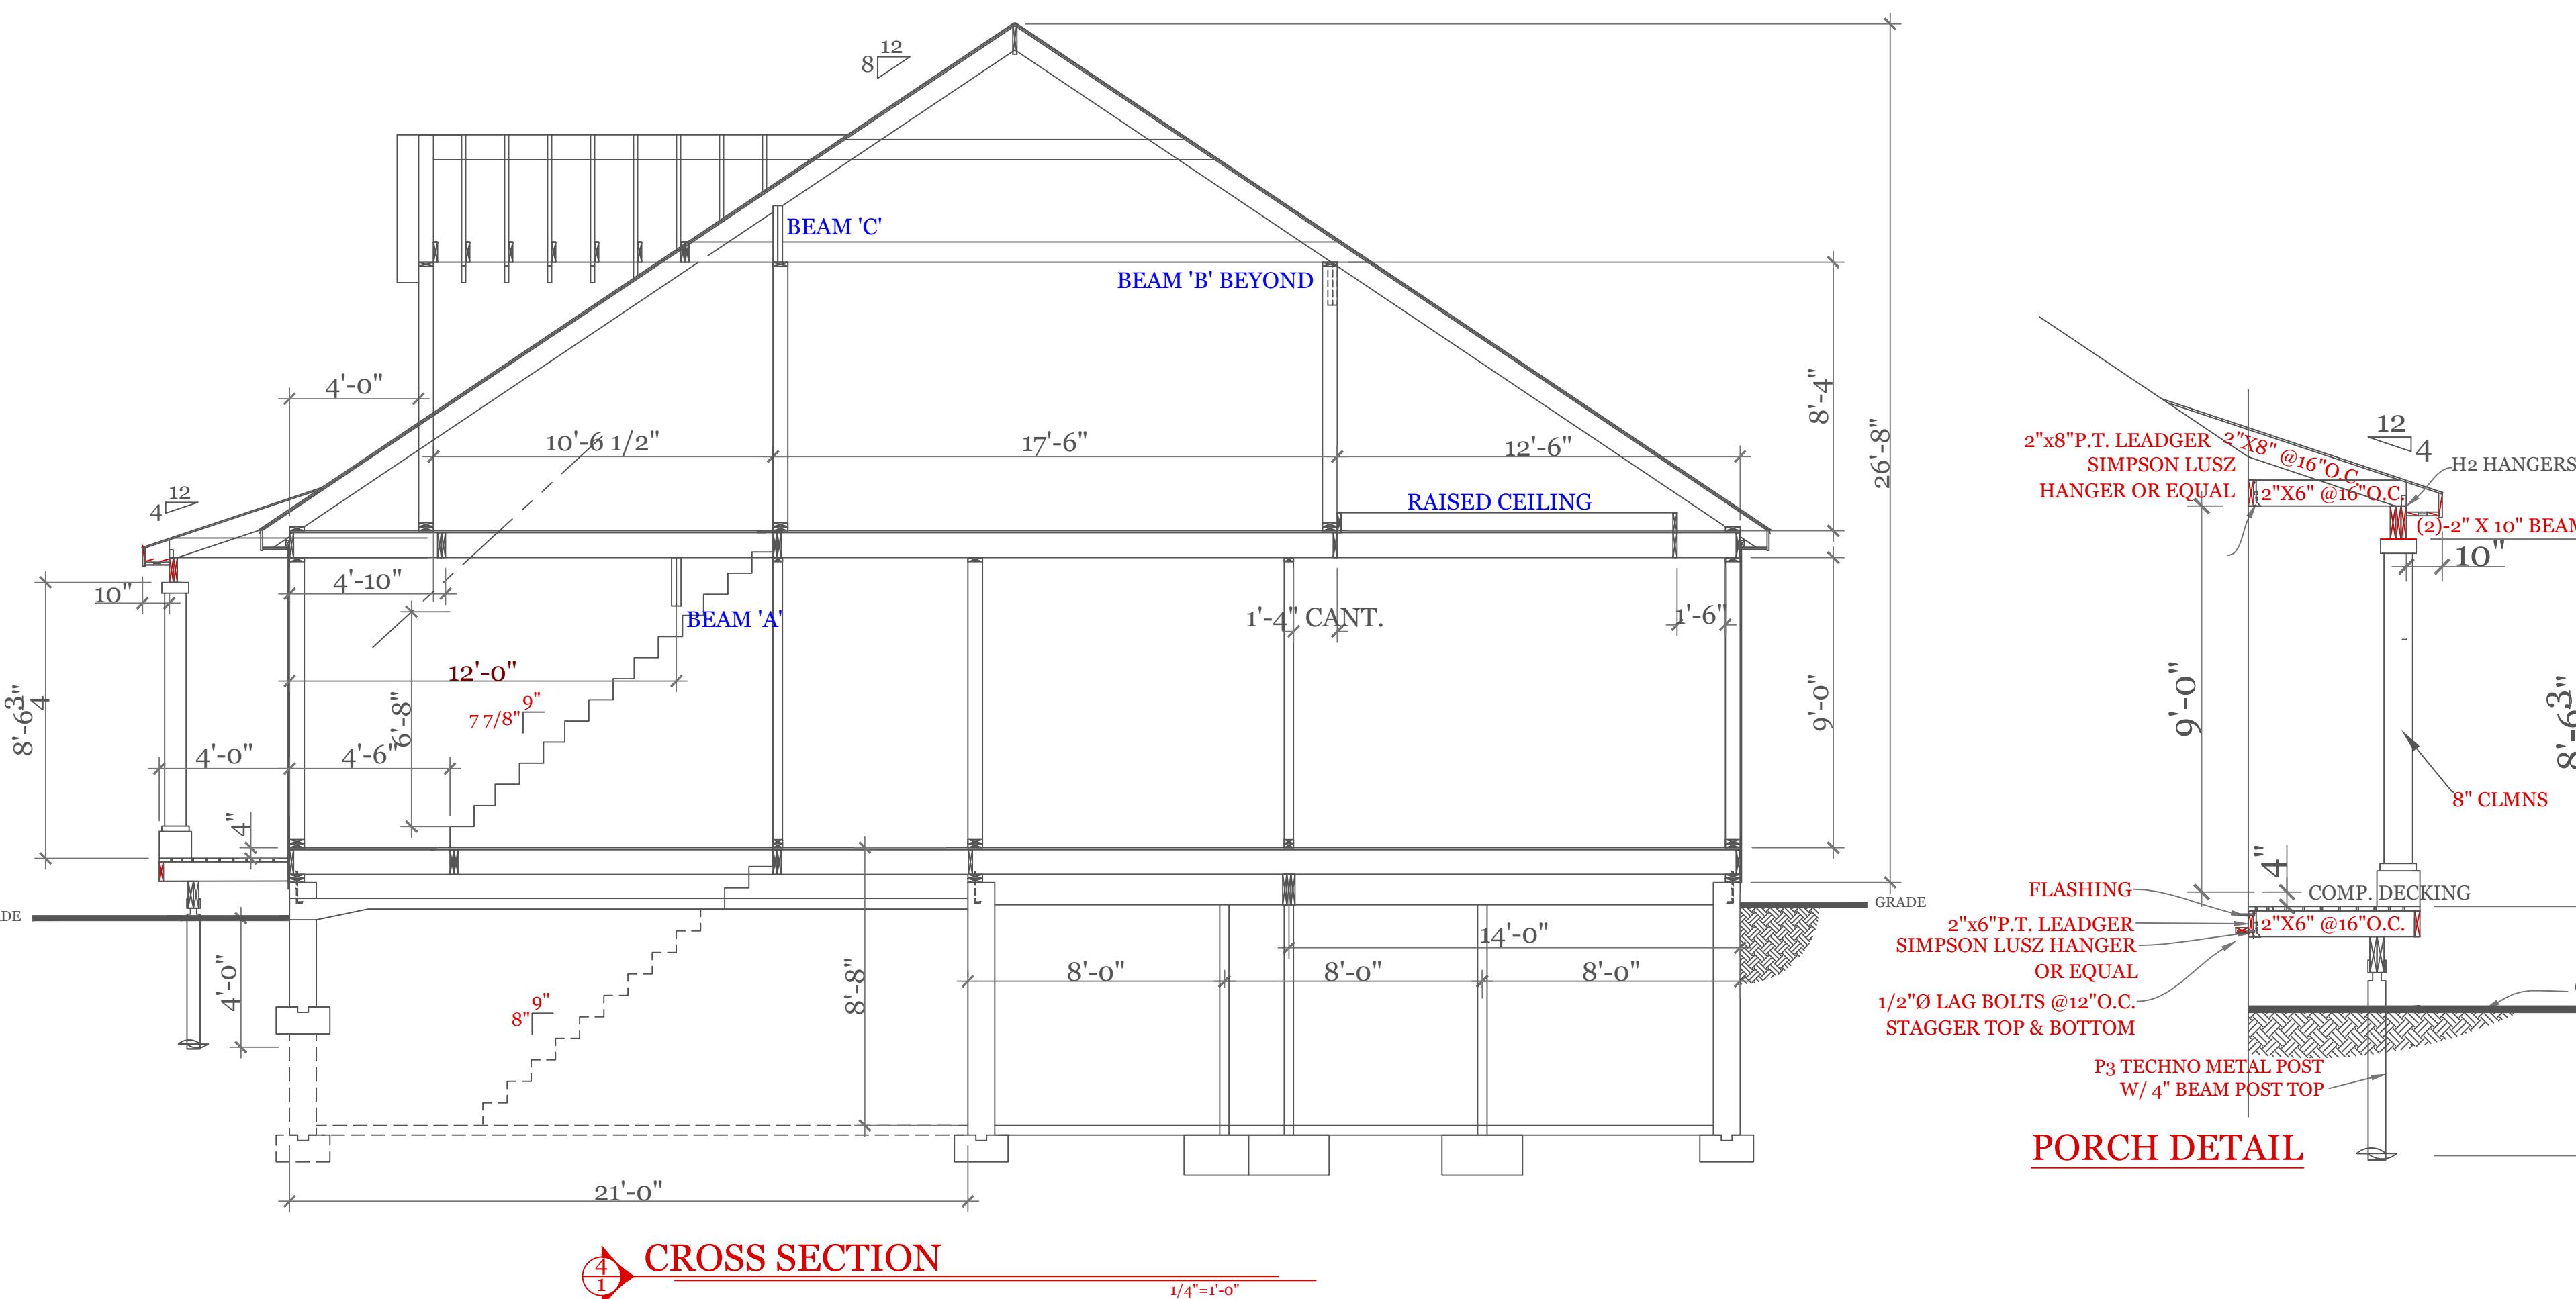

NOTES:

BR C Searles Associates

R.C. BURRIS ASSOCIATES

Exclusive Home Designers
Design / Build

Phone No. 17 Glenwood
(508) 466-3202

Holden Ma

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299 SALISBURY STR.
WORCESTER, MA
(508)450-3461

BUILDING SECTIONS & DETAILS

NIT 'A' GR

DATE: 9/20/22 R-5/5/23

SCALE: AS NOTED

DRAWN BY: RCS

CHECKED BY: MJB

Sheet


4 OF 5

Journal of Health Politics, Policy and Law, Vol. 33, No. 4, December 2008
DOI 10.1215/03616878-33-4 © 2008 by The University of Chicago

4

4


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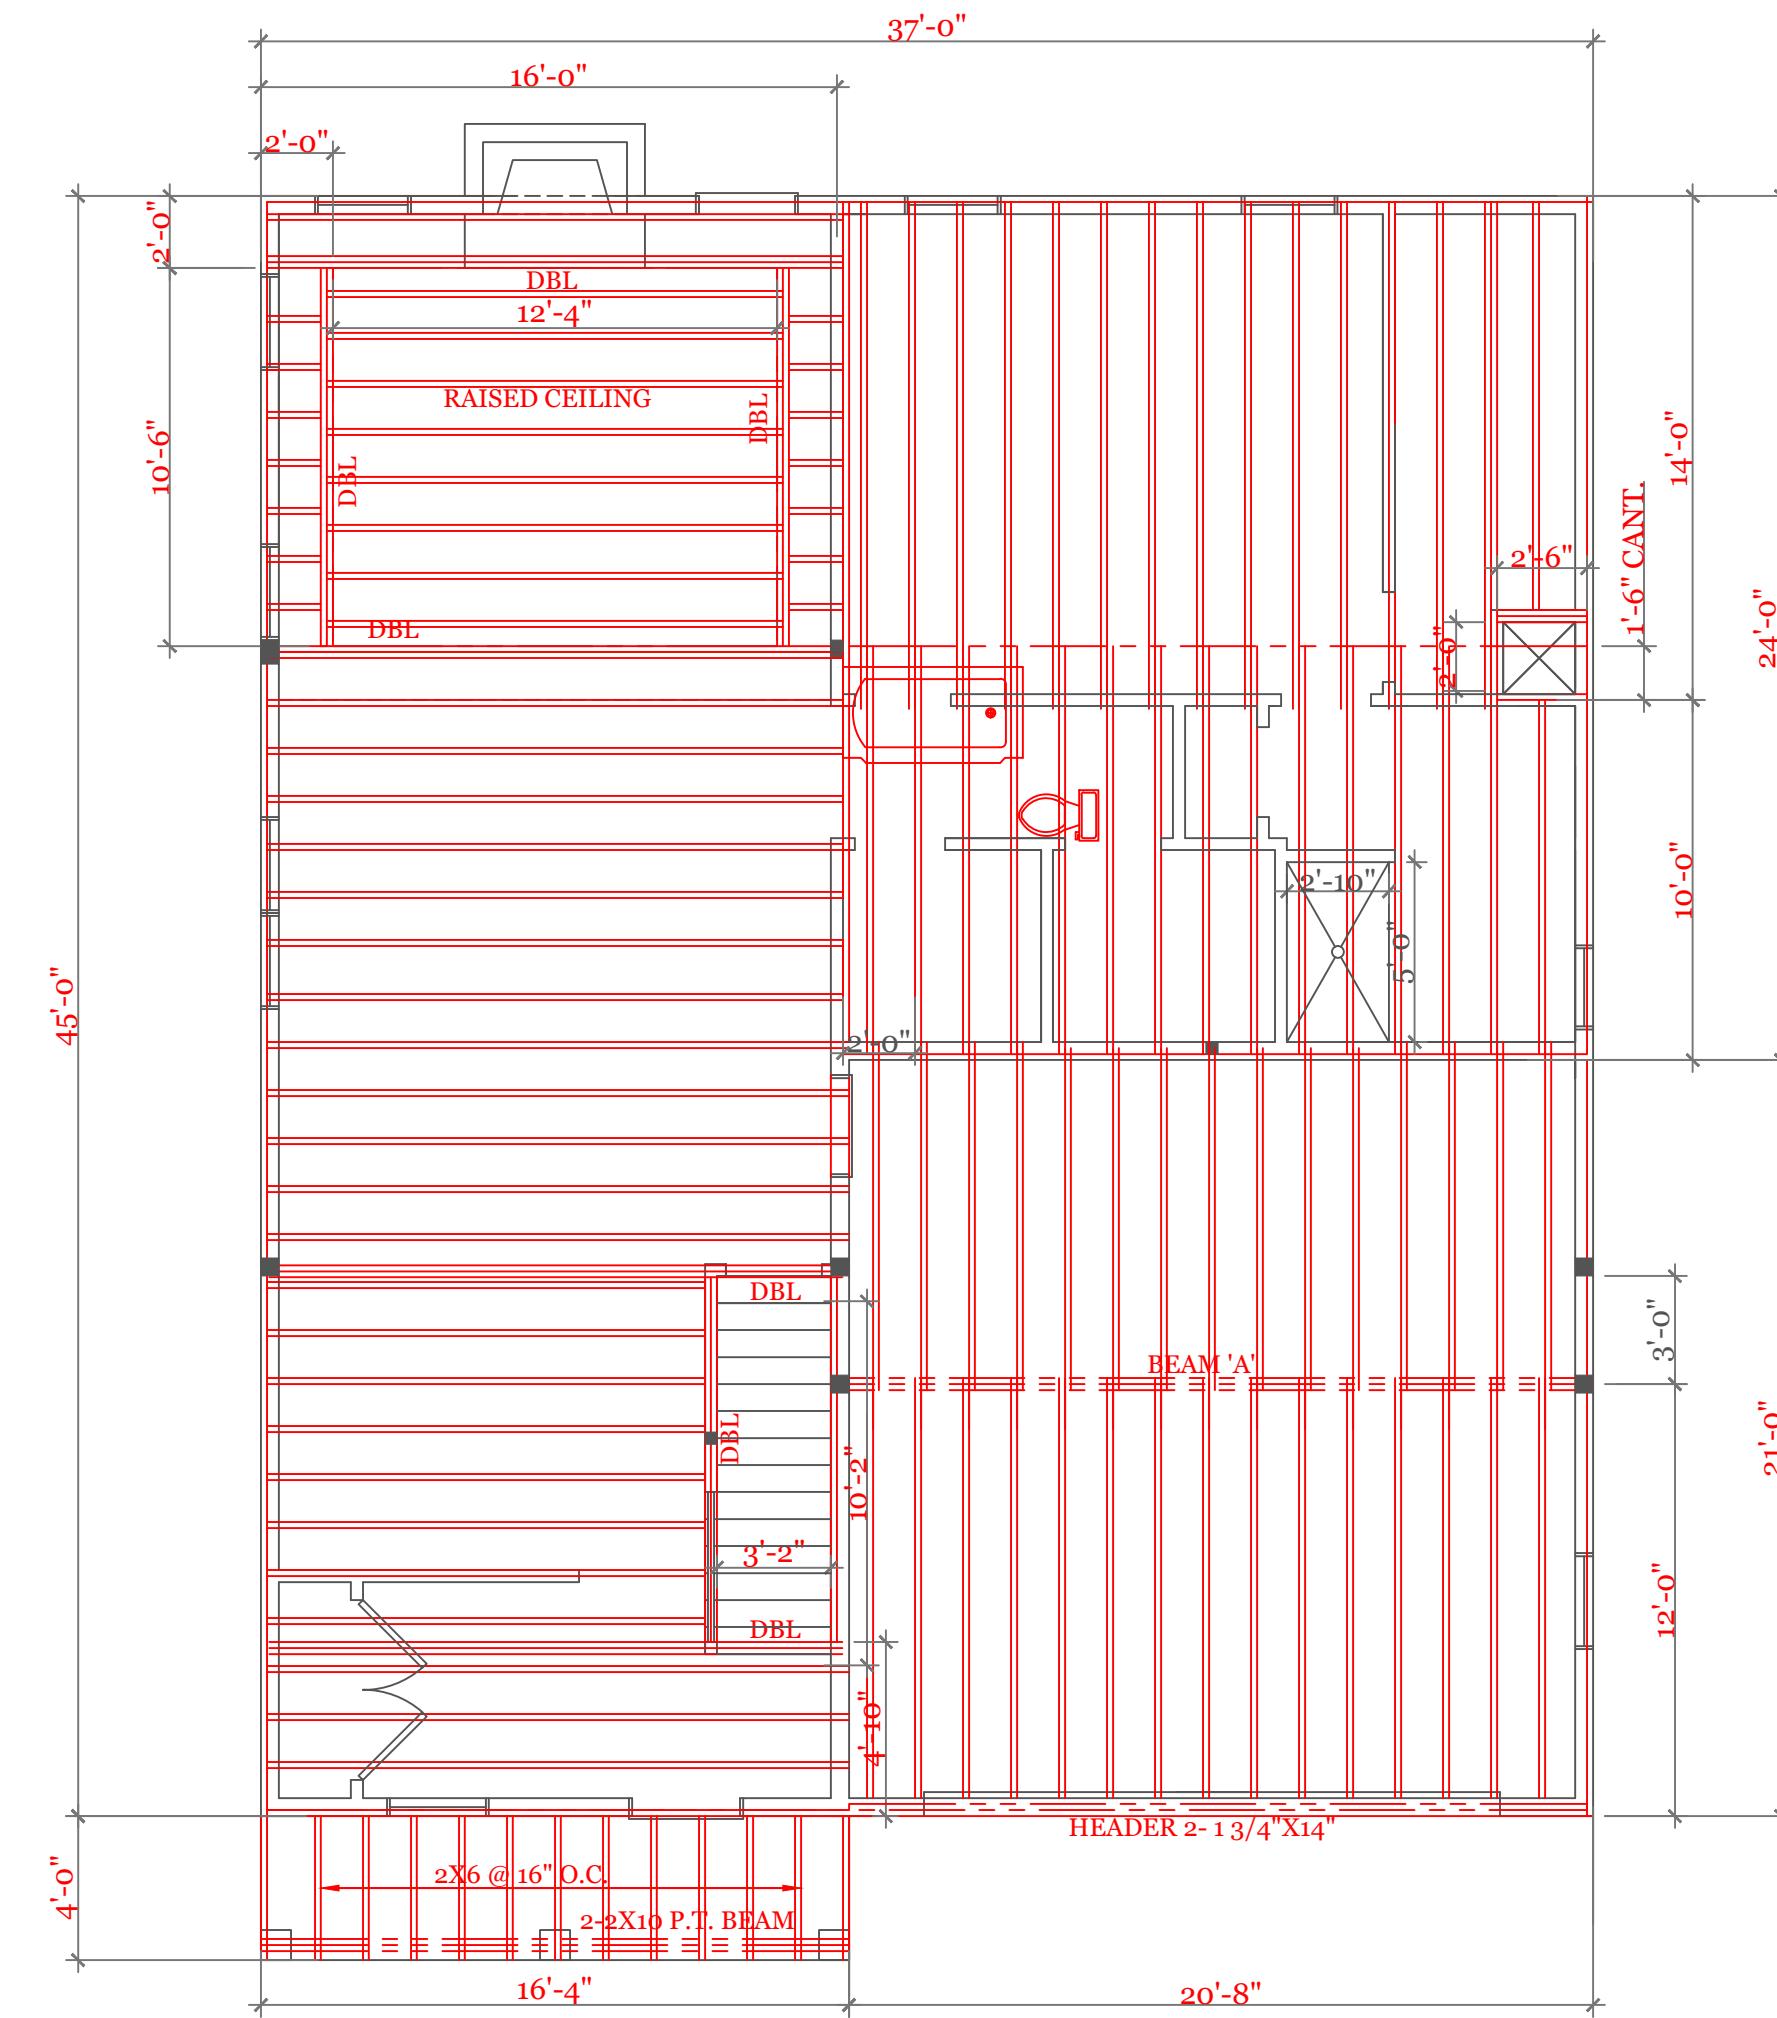
ROOF FRAMING (2"X8" @ 16" O.C. UNLESS NOTED)

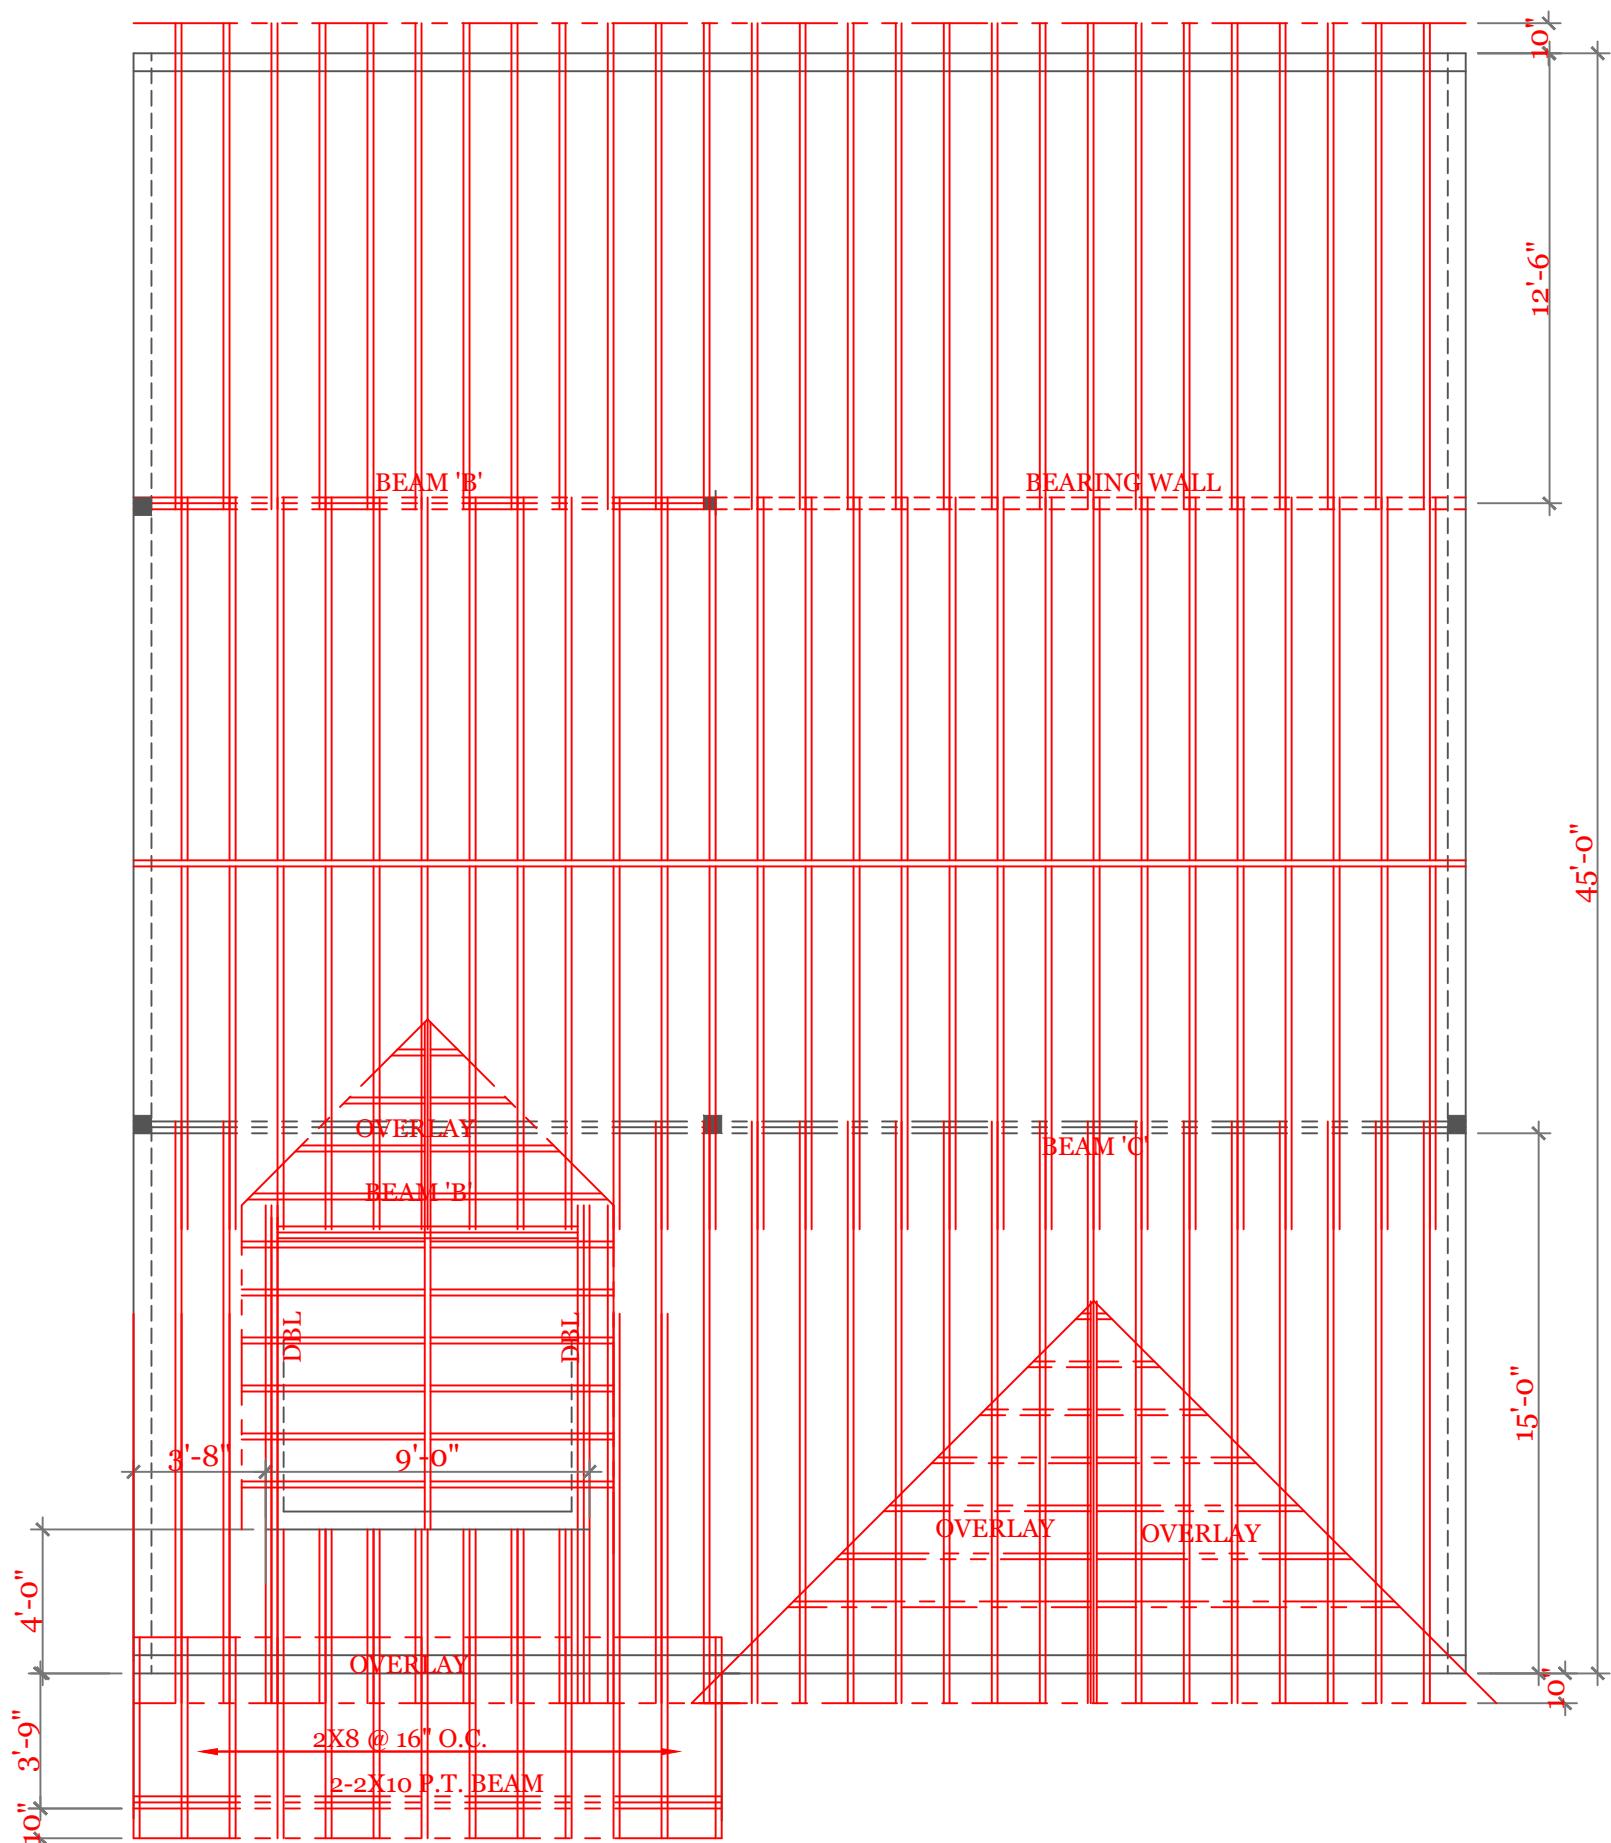BEAM CALCULATIONS


BEAM	SIZE	SPAN	LIVE LOAD	TOTAL LOAD	MAX LIVE (PLF)	MAX TOTAL (PLF)
A	3 1/2" X 18" LVL	22'-0"	315	420	473	681
B	3 1/2" X 16" LVL	16'-0"	550	660	1296	1320
C	5 1/4" X 18" LVL	21'-0"	800	960	1065	1298



CEILING FRAMING (2"X8" @ 16" O.C. UNLESS NOTED)

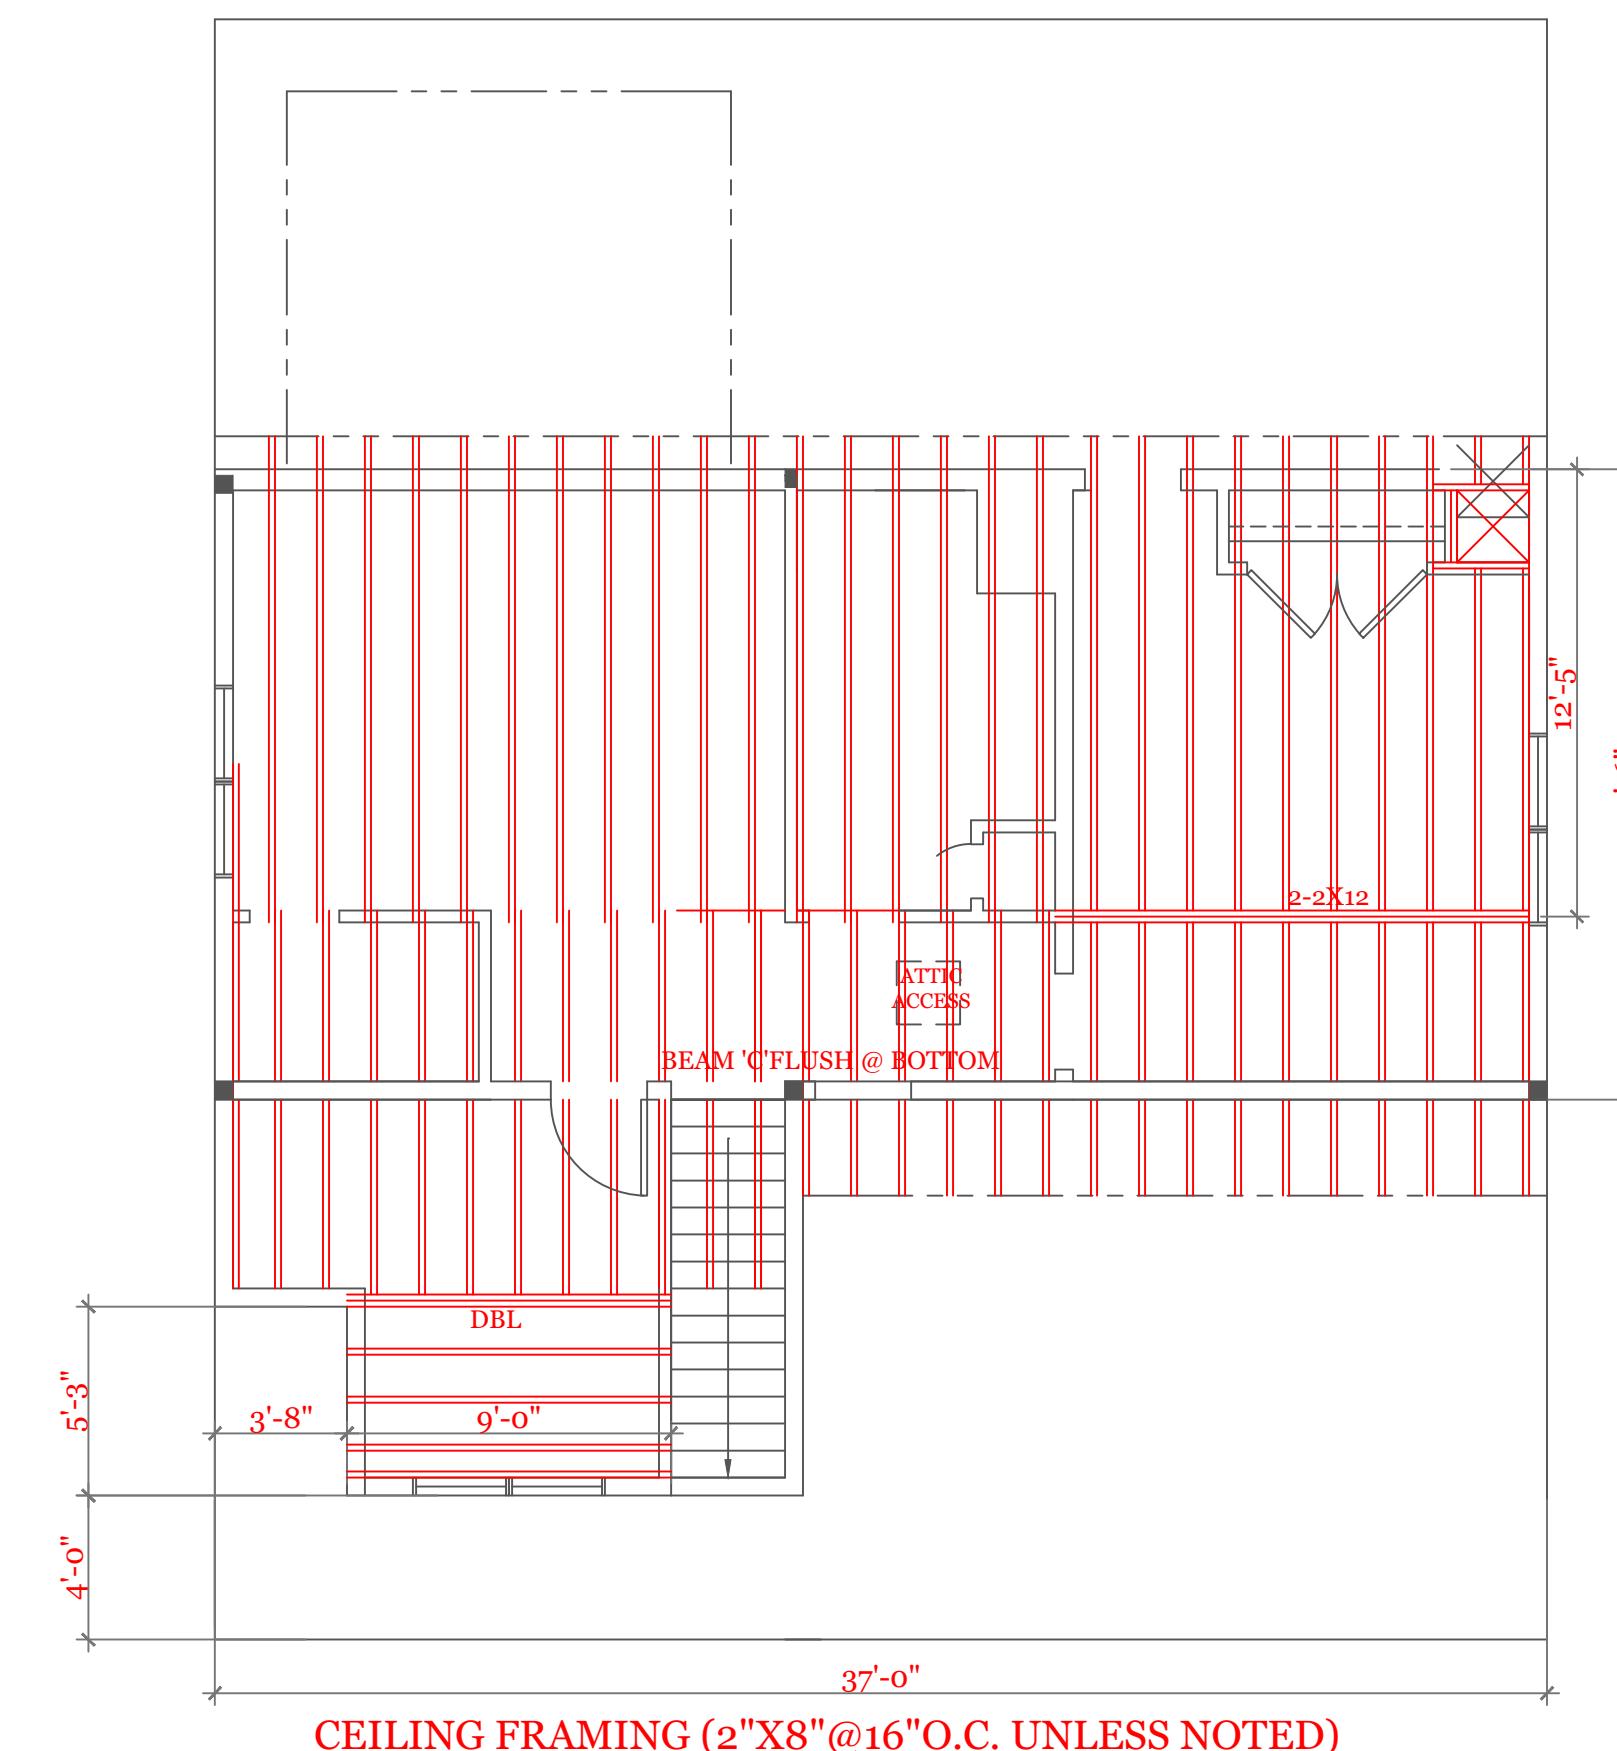

SECOND FLOOR FRAMING (2"X10" @ 16" O.C. UNLESS NOTED)

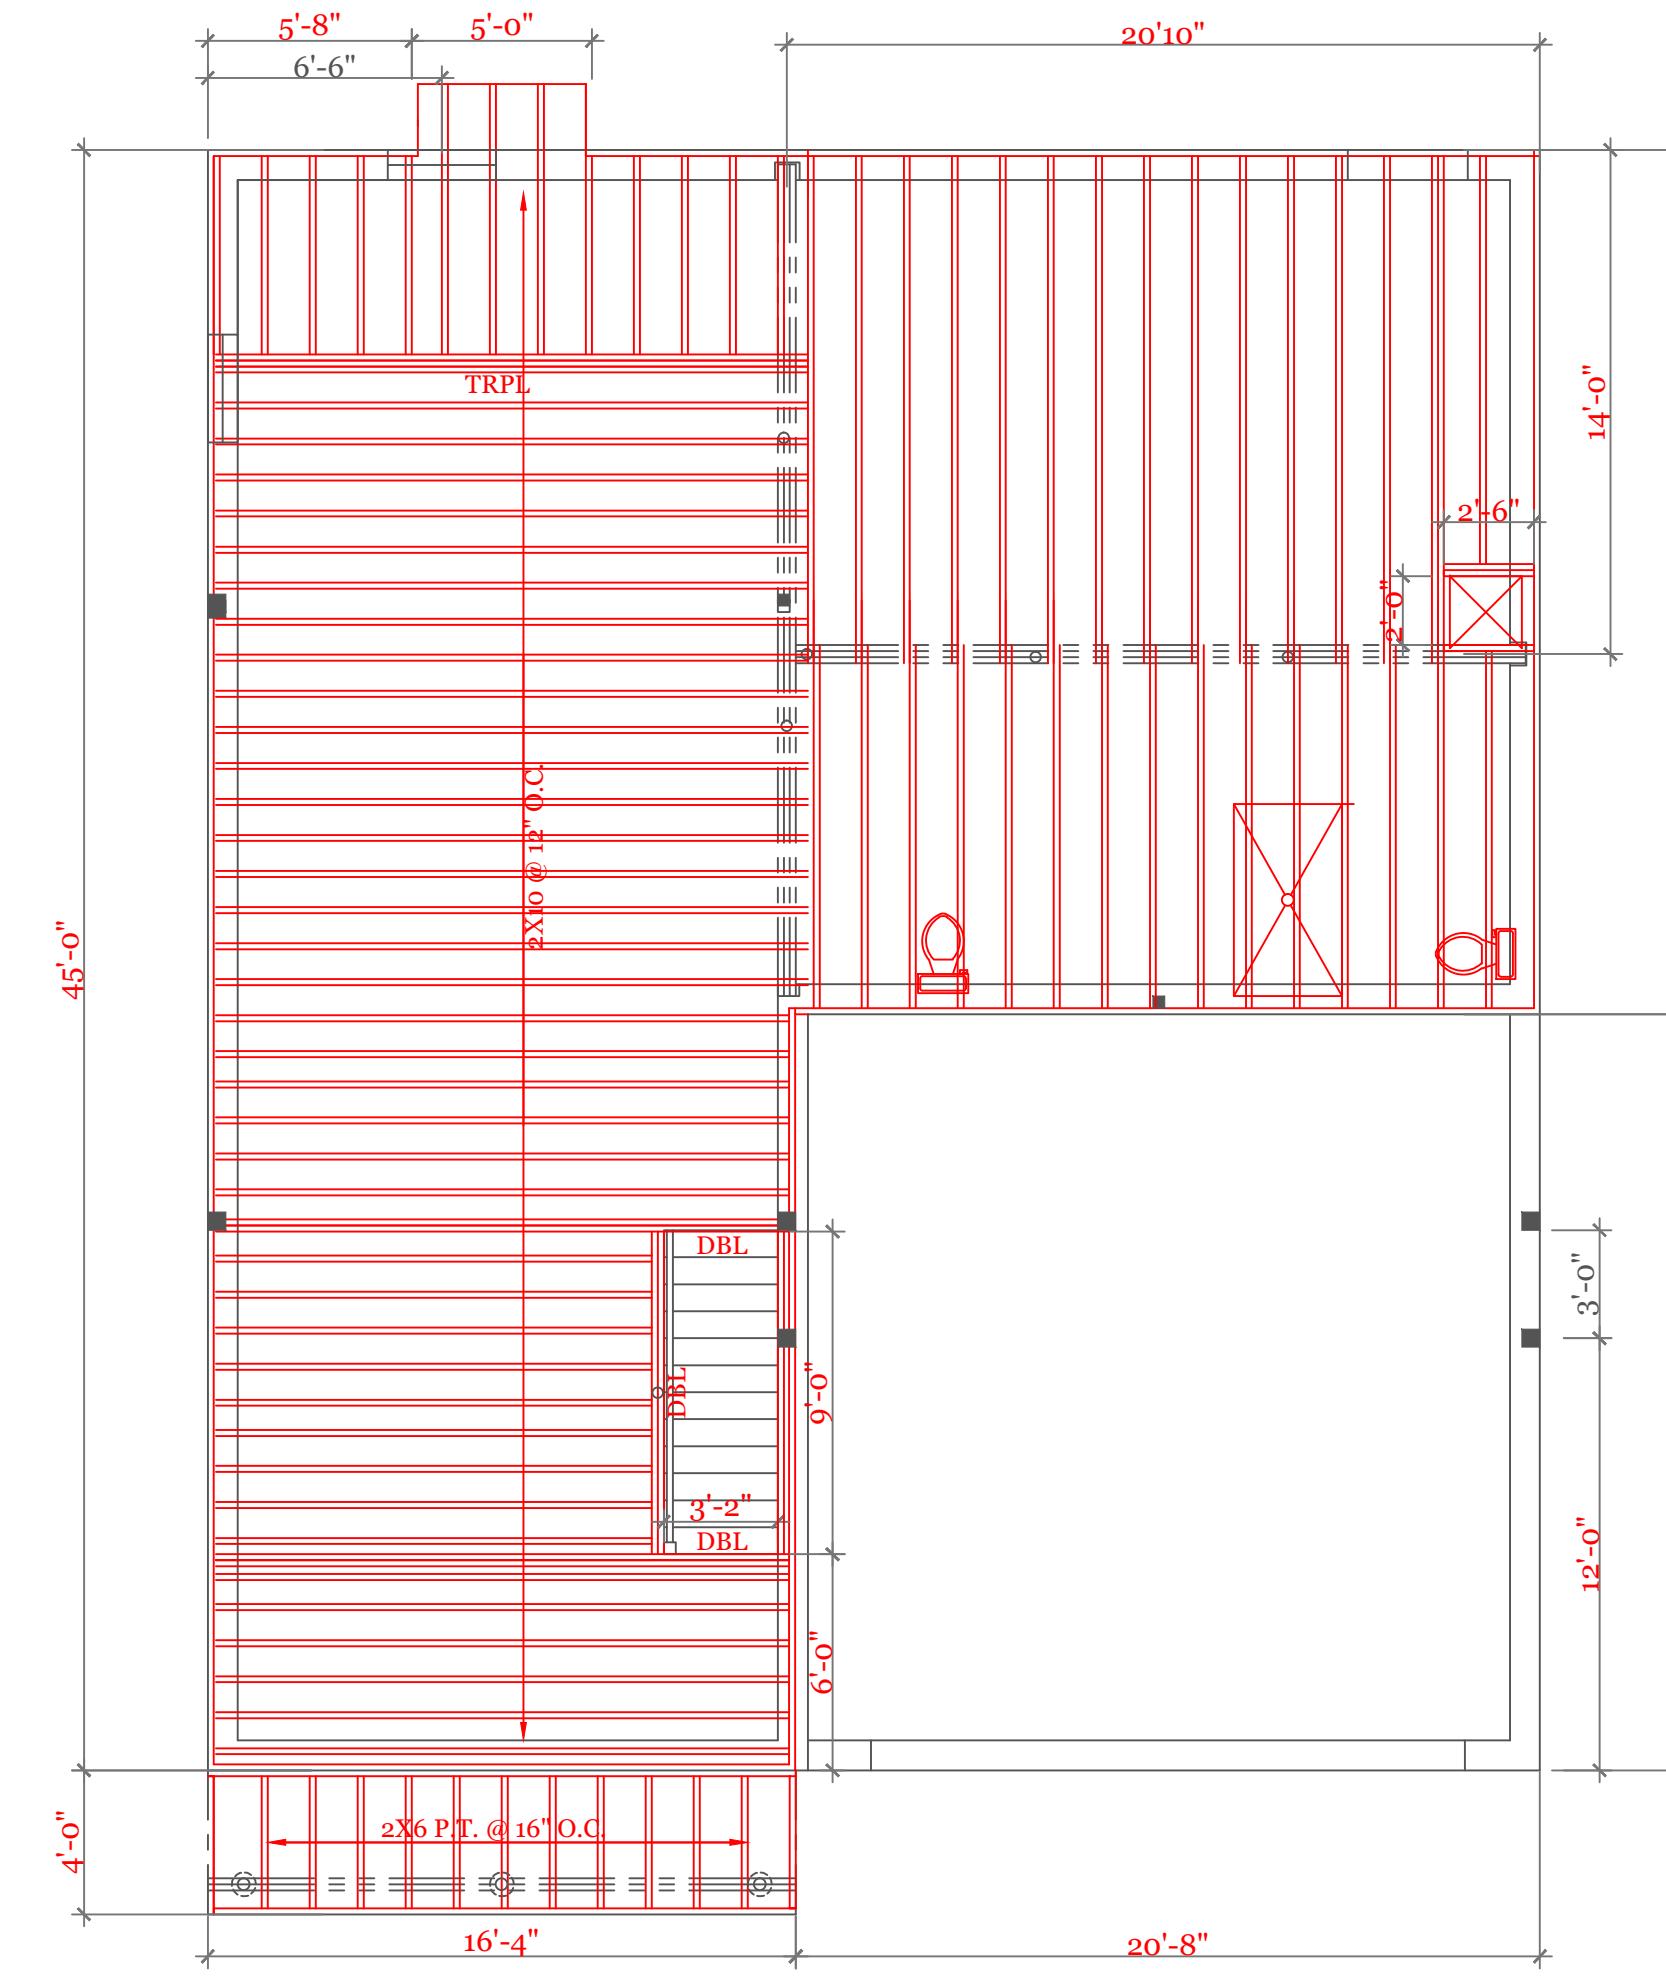FIRST FLOOR FRAMING (2"X10" @ 16" O.C. UNLESS NOTED)
OPTION 2X12 @ 16" O.C.**R.C. Searles Associates**

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WORCESTER, MA
(508)450-3461

UNIT 'A'
HIGGINS FARM AT
SALISBURY HILL

FRAMING PLANS
BEAM SCHEDULE

UNIT 'A' GR

DATE: 9/20/22 R-5/5/23
SCALE: 1/4" = 1'-0"
DRAWN BY: RCS
CHECKED BY: MJB

Sheet 5 OF 5

5

NOTES:

GENERAL NOTES:
 1. These plans are drawn as required for construction by an experienced licensed general contractor.
 2. The General contractor shall fully comply with the 9TH Edition of the Massachusetts State Building Code, IRC2015 and all additional local requirements.
 3. Written dimensions shall have precedence over scaled dimensions. The general contractor shall verify and is responsible for all dimensions (including rough openings) and conditions on the job and must notify this office of any variations from these drawings. Any defects in the construction documents shall be brought to the attention of this office before proceeding with work. Reasonable time not allowed this office to correct defects shall place the burden of cost and liability from such defects upon the contractor.

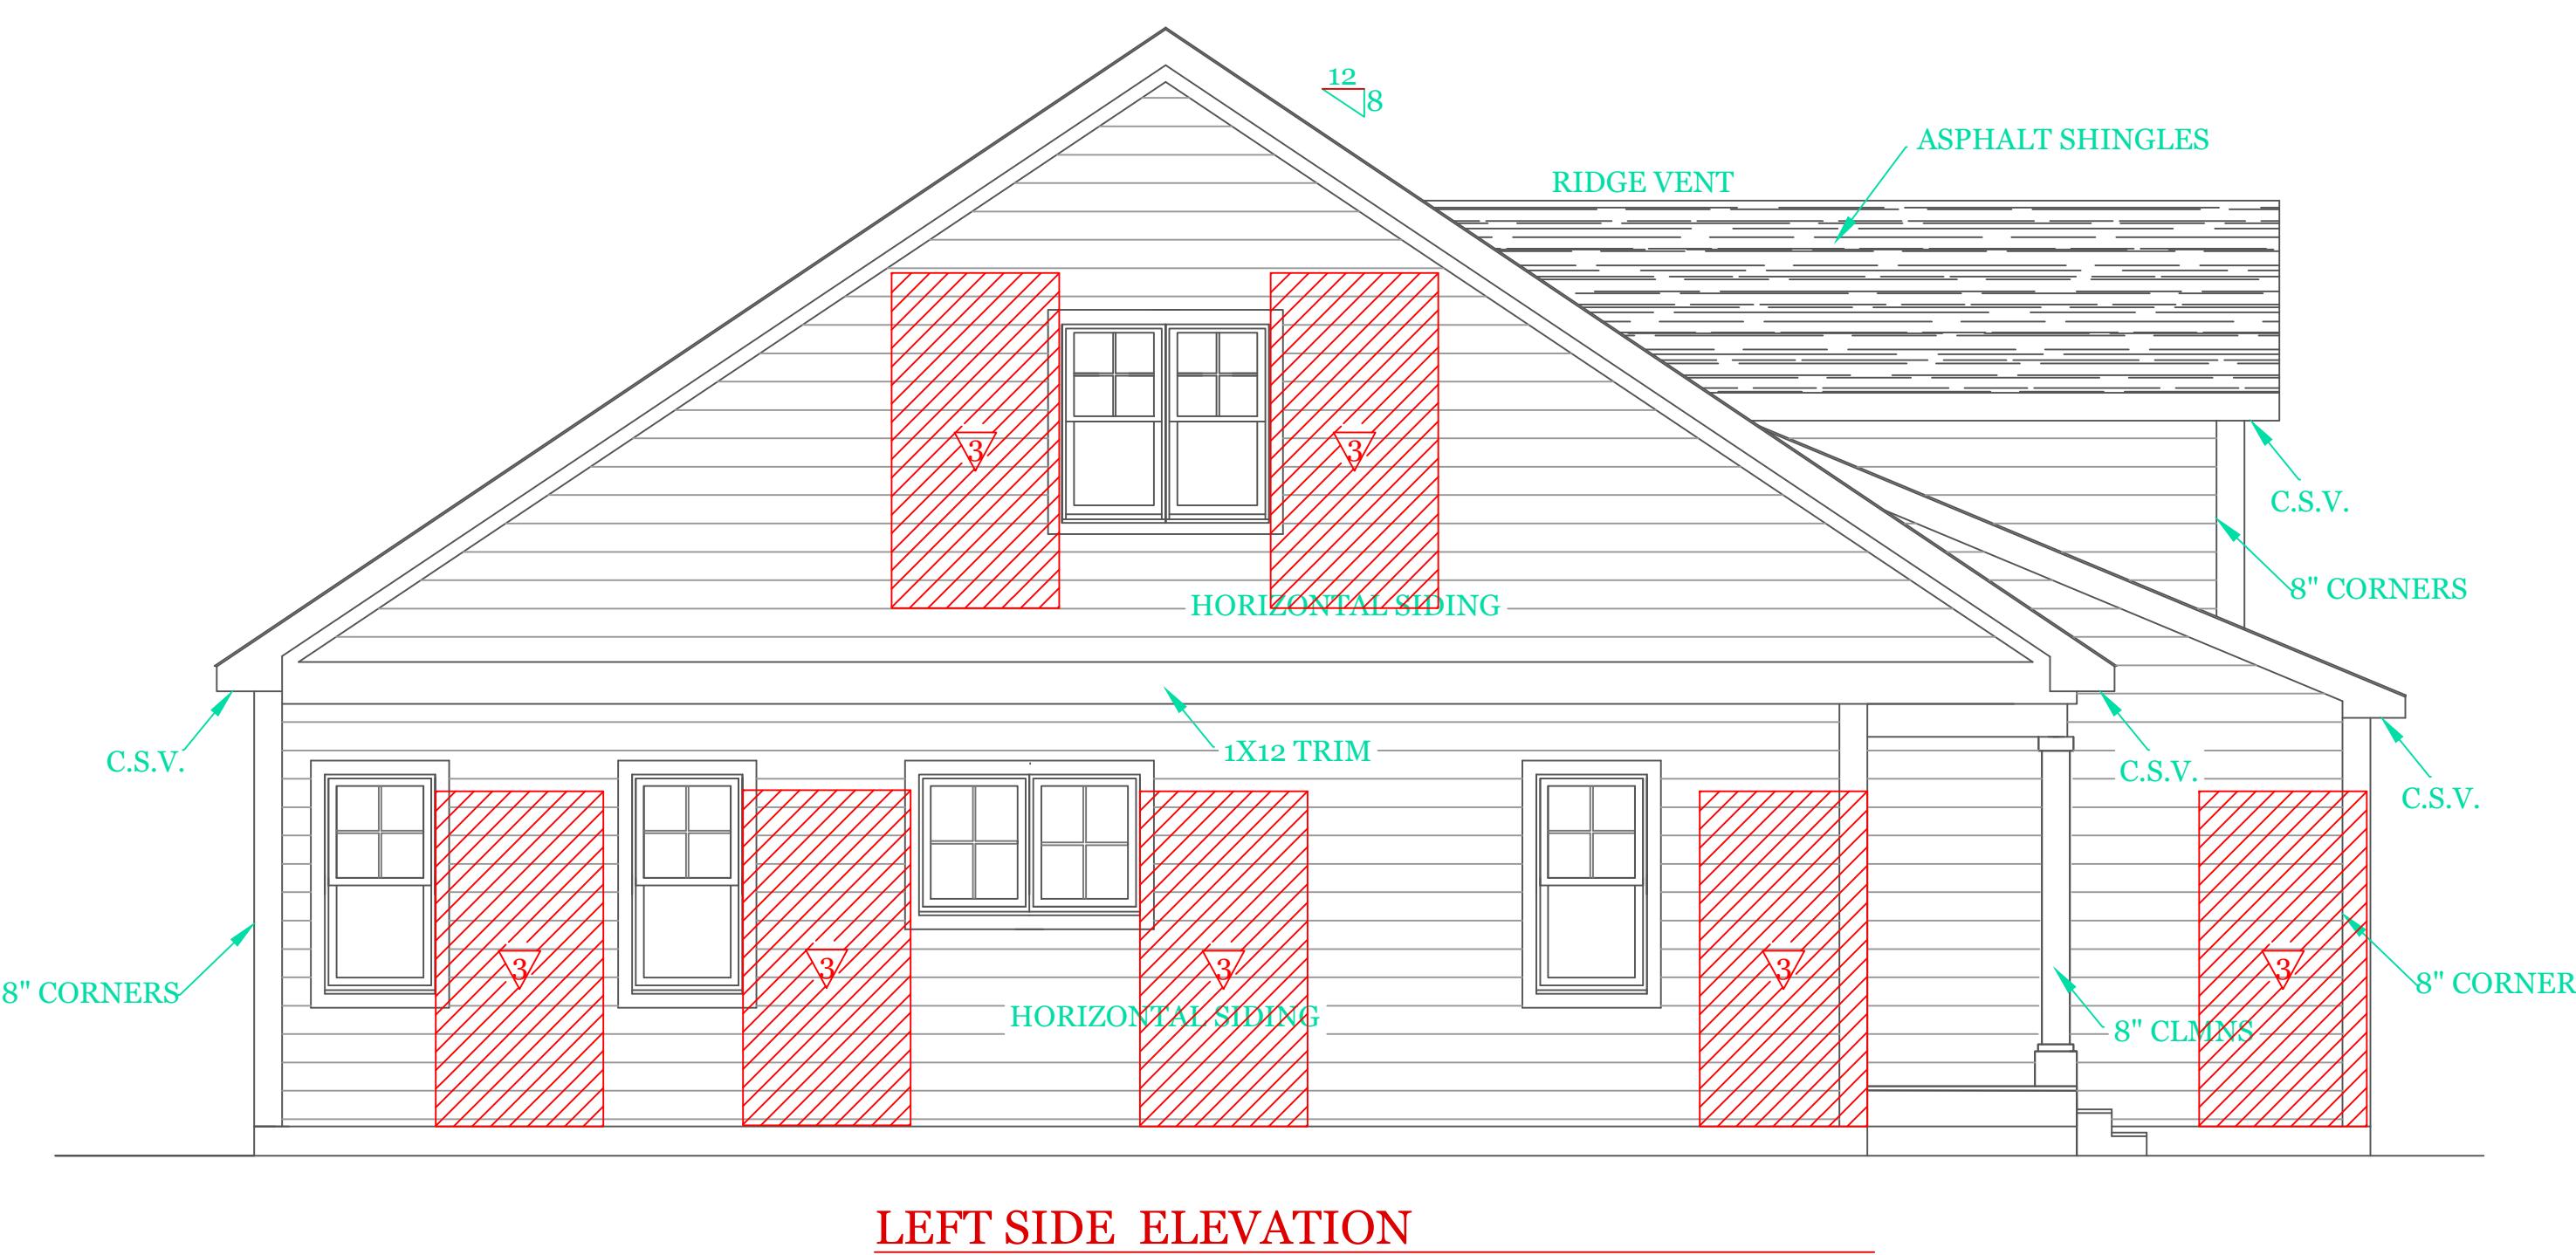
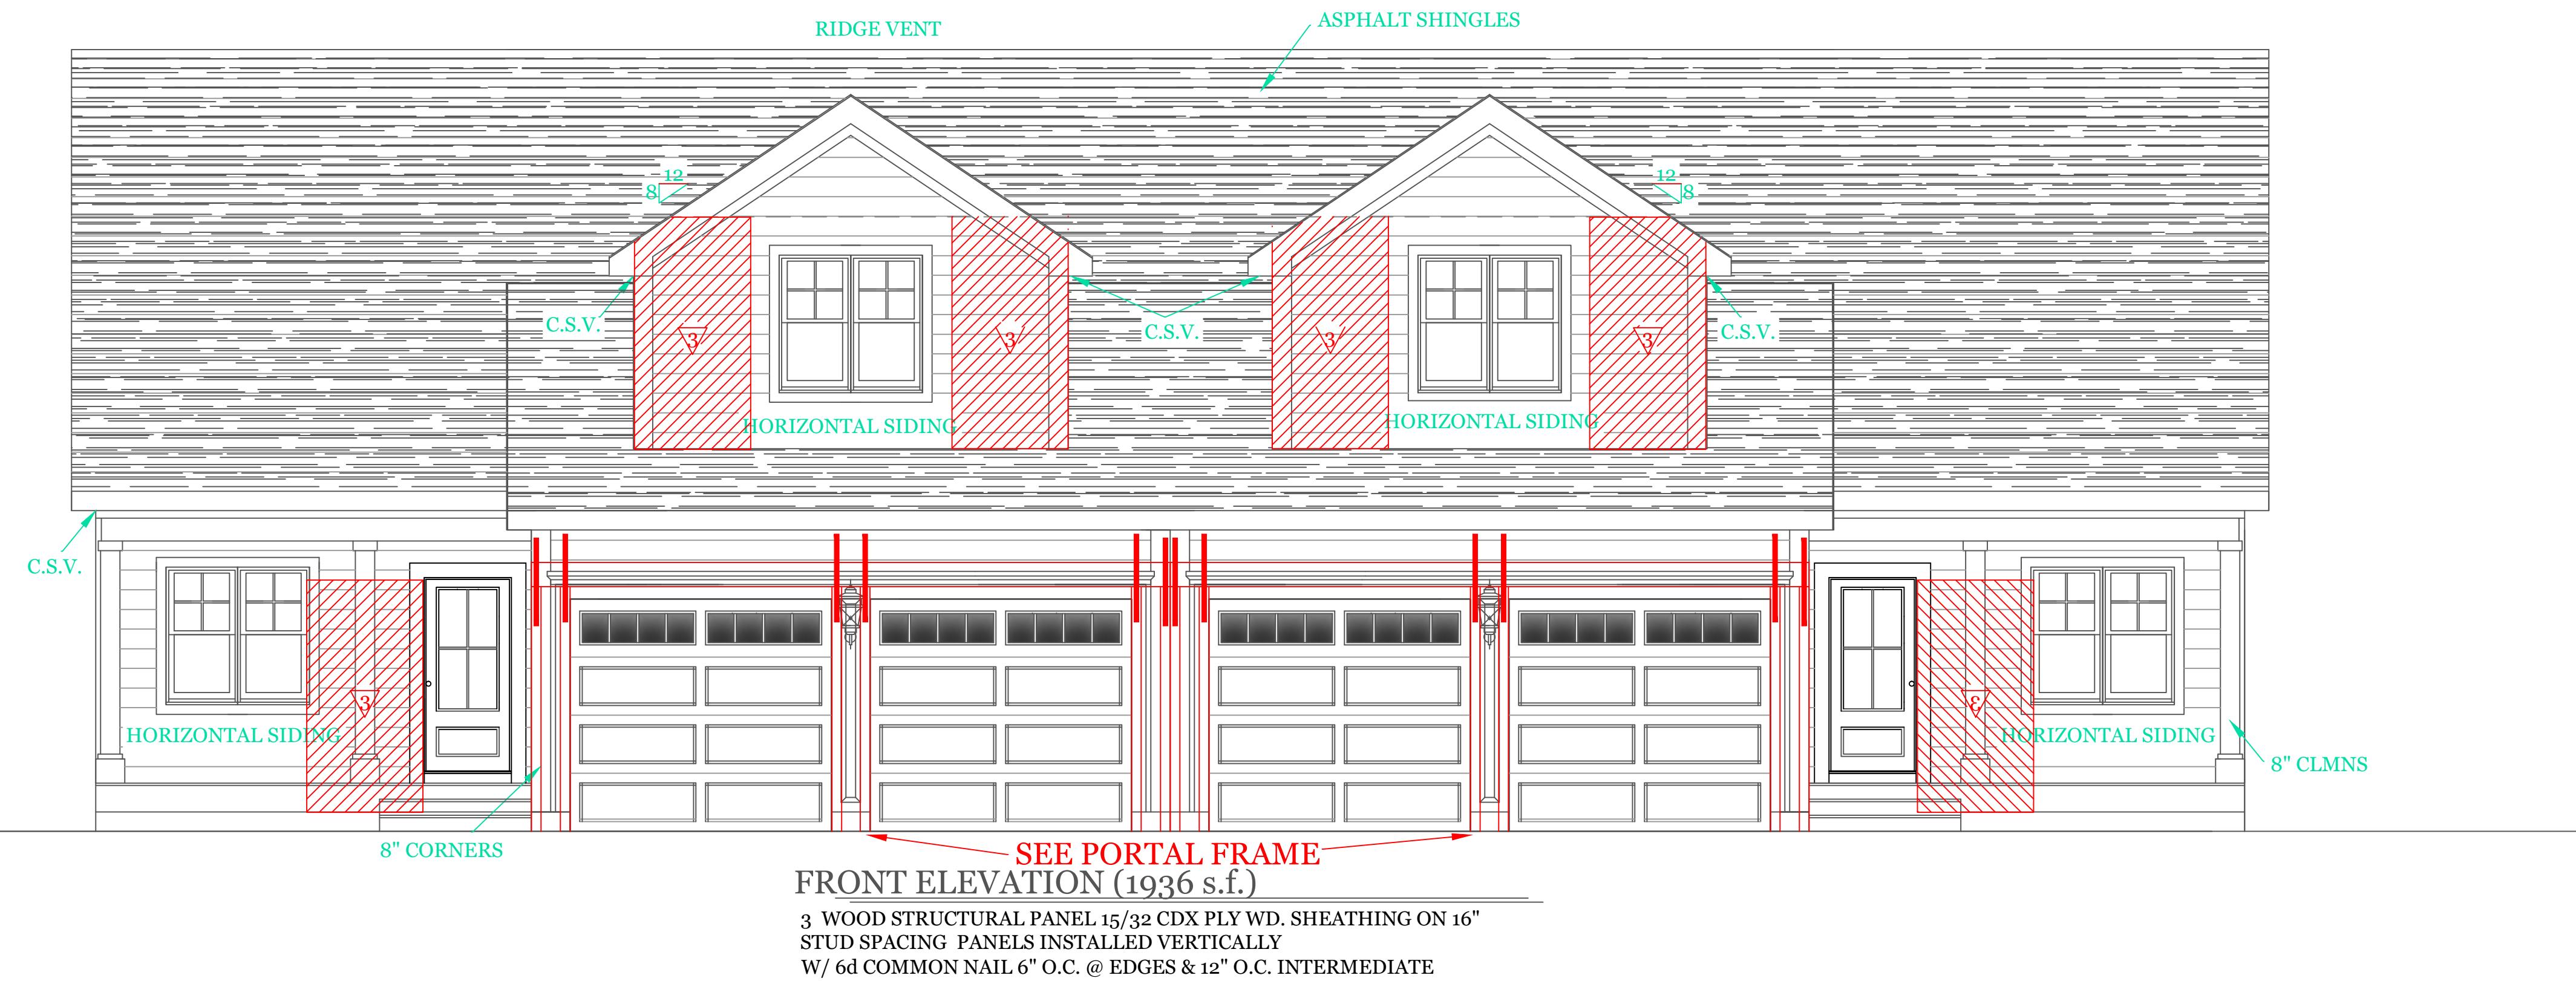


TABLE 402.1.2
INSULATION AND FENESTRATION REQUIREMENTS BY COMPONENT^a

CLIMATE ZONE	FENESTRATION U-FACTOR ^b	SKYLIGHT ^b U-FACTOR	GLAZED FENESTRATION SHGC _{b,e}	CEILING R-VALUE	WOOD FRAME WALL R-VALUE	MASS WALL R-VALUE ⁱ	FLOOR R-VALUE	BASEMENT ^c WALL R-VALUE	SLAB ^d R-VALUE & DEPTH	CRAWL SPACE ^c WALL R-VALUE
5 and Marine 4	0.30	0.55	NR	49	20 or 13+5 ^h	13/17	30g	15/19	10, 2 ft	15/19

2018 INTERNATIONAL ENERGY CONSERVATION CODE® AND MASSACHUSETTES 780 CMR 9TH EDITION

- For SI: 1 foot = 304.8 mm.
 a. R-values are minimums. U-factors and SHGC are maximums. R-19 batts compressed into a nominal 2 x 6 framing cavity such that the R-value is reduced by R-1 or more shall be marked with the compressed batt R-value in addition to the full thickness R-value.
 b. The fenestration U-factor column excludes skylights. The SHGC column applies to all glazed fenestration.
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 d. R-5 shall be added to the required slab edge R-values for heated slabs. Insulation depth shall be the depth of the footing or 2 feet, whichever is less in Zones 1 through 3 for heated slabs.
 e. There are no SHGC requirements in the Marine Zone.
 f. Basement wall insulation is not required in warm-humid locations as defined by Figure 301.1 and Table 301.
 g. Or insulation sufficient to fill the framing cavity, R-19 minimum.
 h. "13+5" means R-13 cavity insulation plus R-5 insulated sheathing. If structural sheathing covers 25 percent or less of the exterior, insulating sheathing is not required where structural sheathing is used. If structural sheathing covers more than 25 percent of exterior, structural sheathing shall be supplemented with insulated sheathing of at least R-2.
 i. The second R-value applies when more than half the insulation is on the interior of the mass wall.
 j. For impact rated fenestration complying with Section R301.21.2 of the International Residential Code or Section 1608.1.2 of the International Building Code, the maximum U-factor shall be 0.75 in Zone 2 and 0.65 in Zone 3.

DESIGN CRITERIA

GROUND SNOW LOAD	WIND SPEED (MPH)	SEISMIC DESIGN	WEATHERING	FROST LINE DEPTH	TERMITES	DECAY	WINTER DESIGN TEMP	ICE SHIELD UNDERLAYMENT REQUIRED	FLOOD HAZARD	AIR FREEZING INDEX	MEAN ANNUAL TEMP
TABLE 5301.2(5)	TABLE 5301.2(4)	N/A	FIGURE 5301.2(3)	4 ft. minimum unless engineered data shows otherwise	FIGURE 5301.2(6)	FIGURE 5301.2(7)	APPENDIX 780 CMR 120.J TABLE 120.J.3.2.1	As required by the exterior roof covering manufacturer; roof pitch and local climate must also be considered	Refer to applicable Flood Insurance Rate Map (FIRM)	Only utilized in the design and construction of frost protected shallow foundations	Only utilized in the design and construction of frost protected shallow foundations
50 psf	124 mph	N/A	SEVERE	\$5403.1.4	MODERATE TO HEAVY	SLIGHT TO MODERATE	N/A	\$5905.0	FIRM MAPS	SEE NOTE J TABLE 5301.2(1)	SEE NOTE K TABLE 5301.2(1)

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Design / Build
17 Glenwood St.
Holden Ma.

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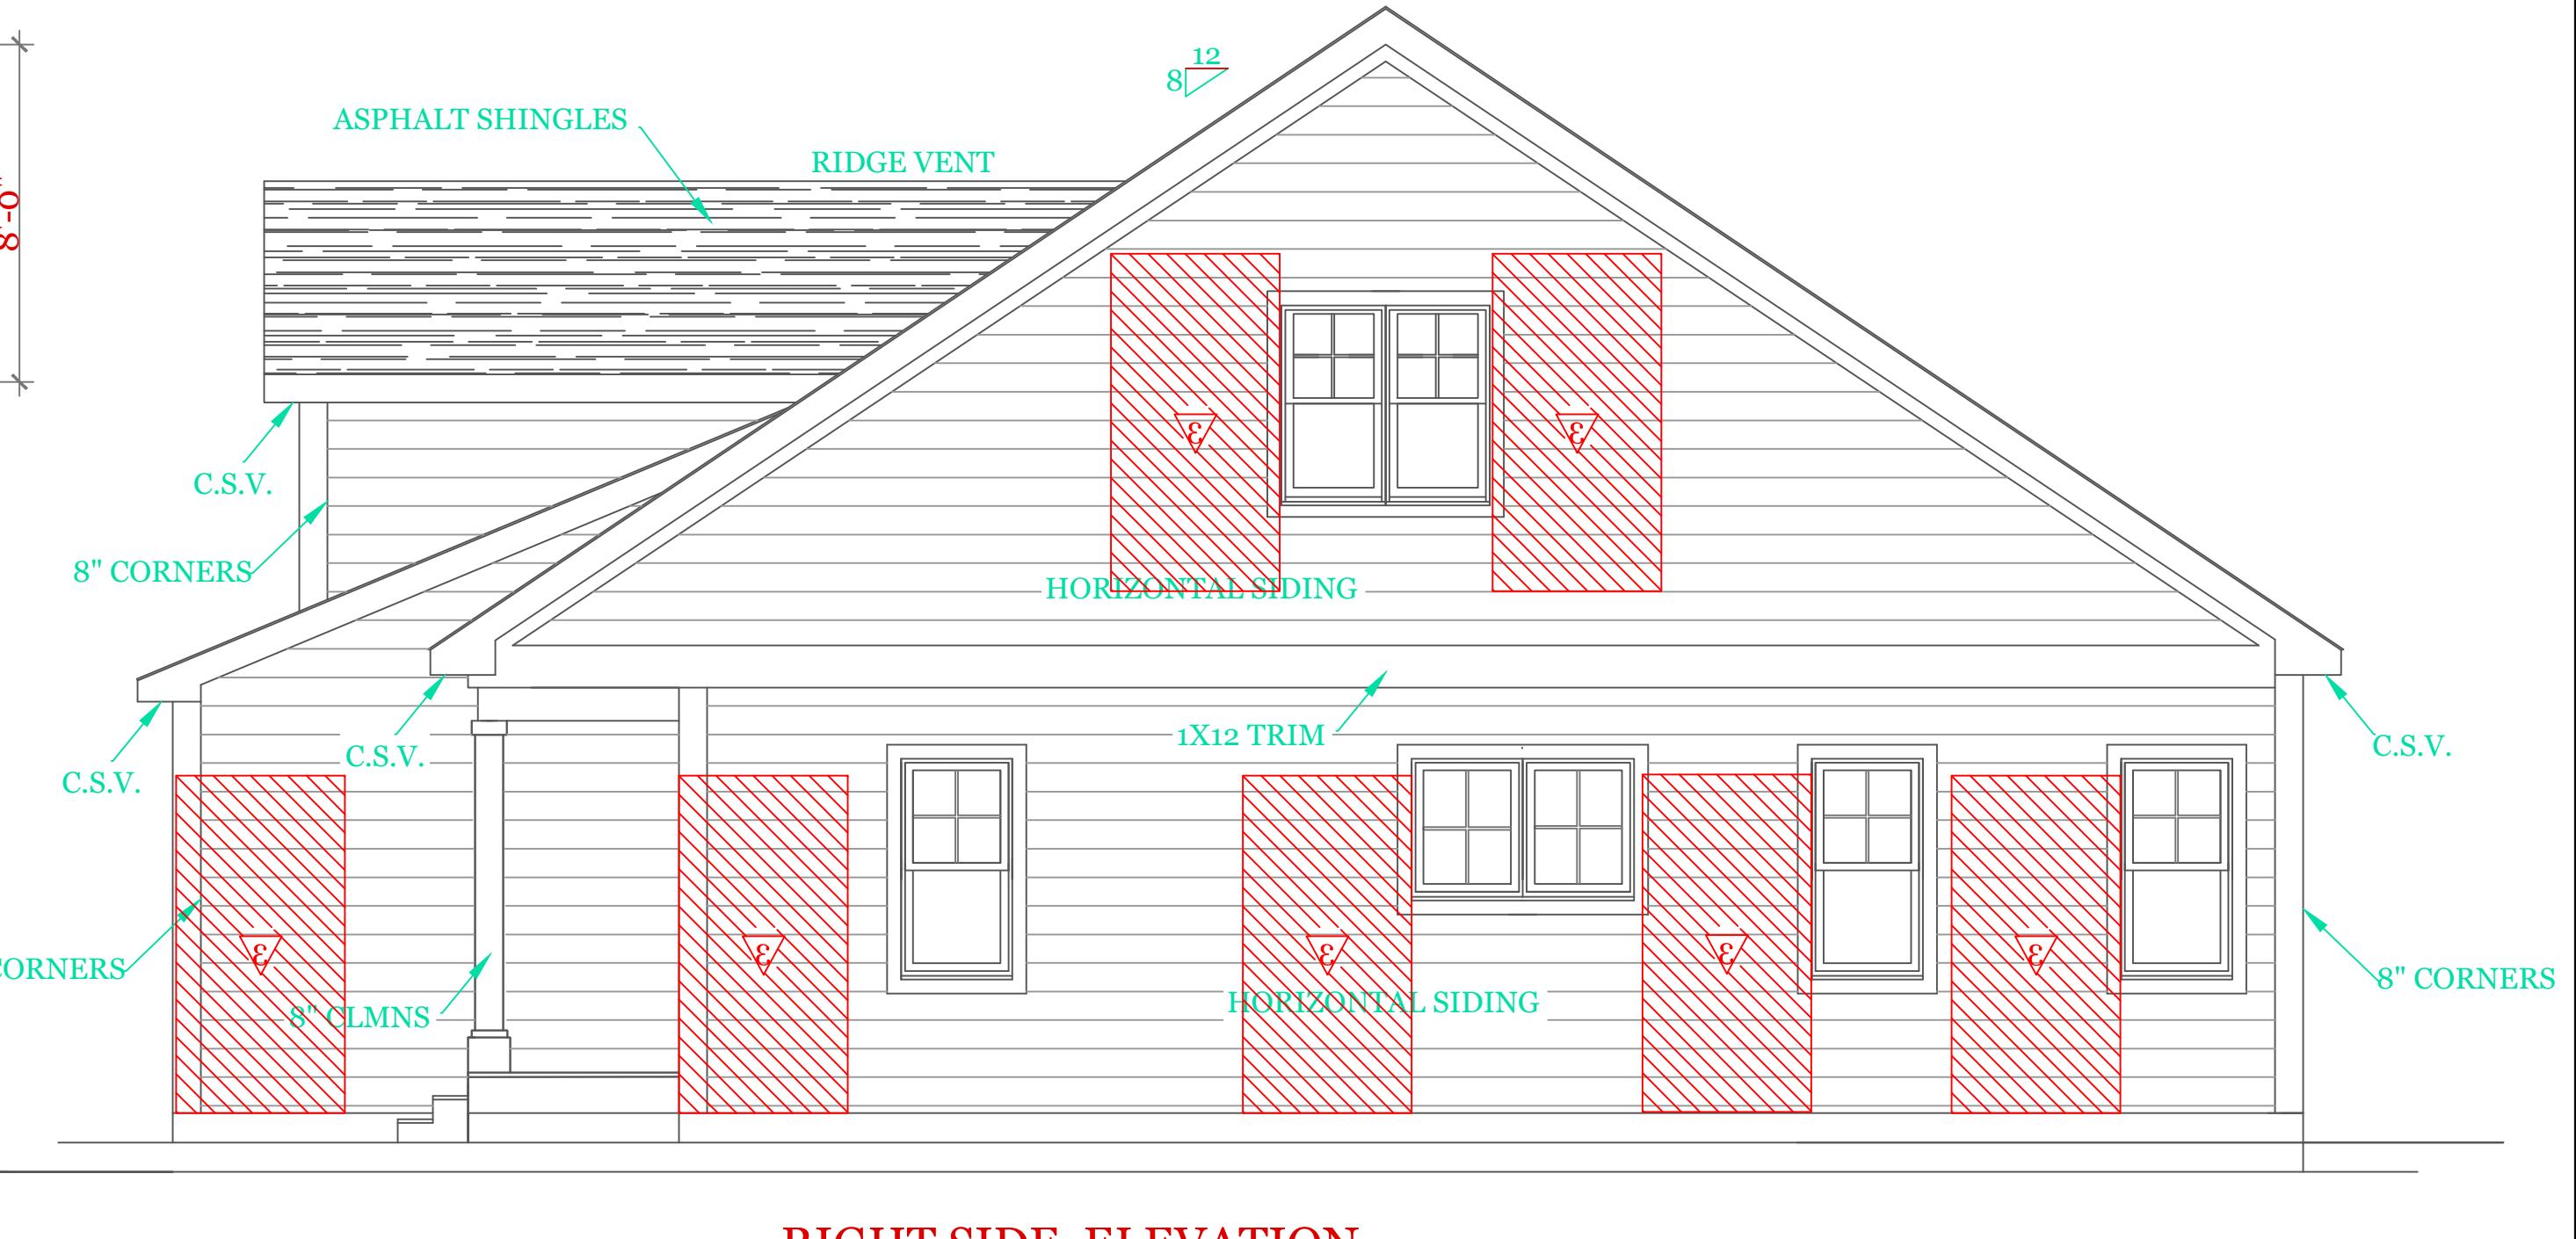
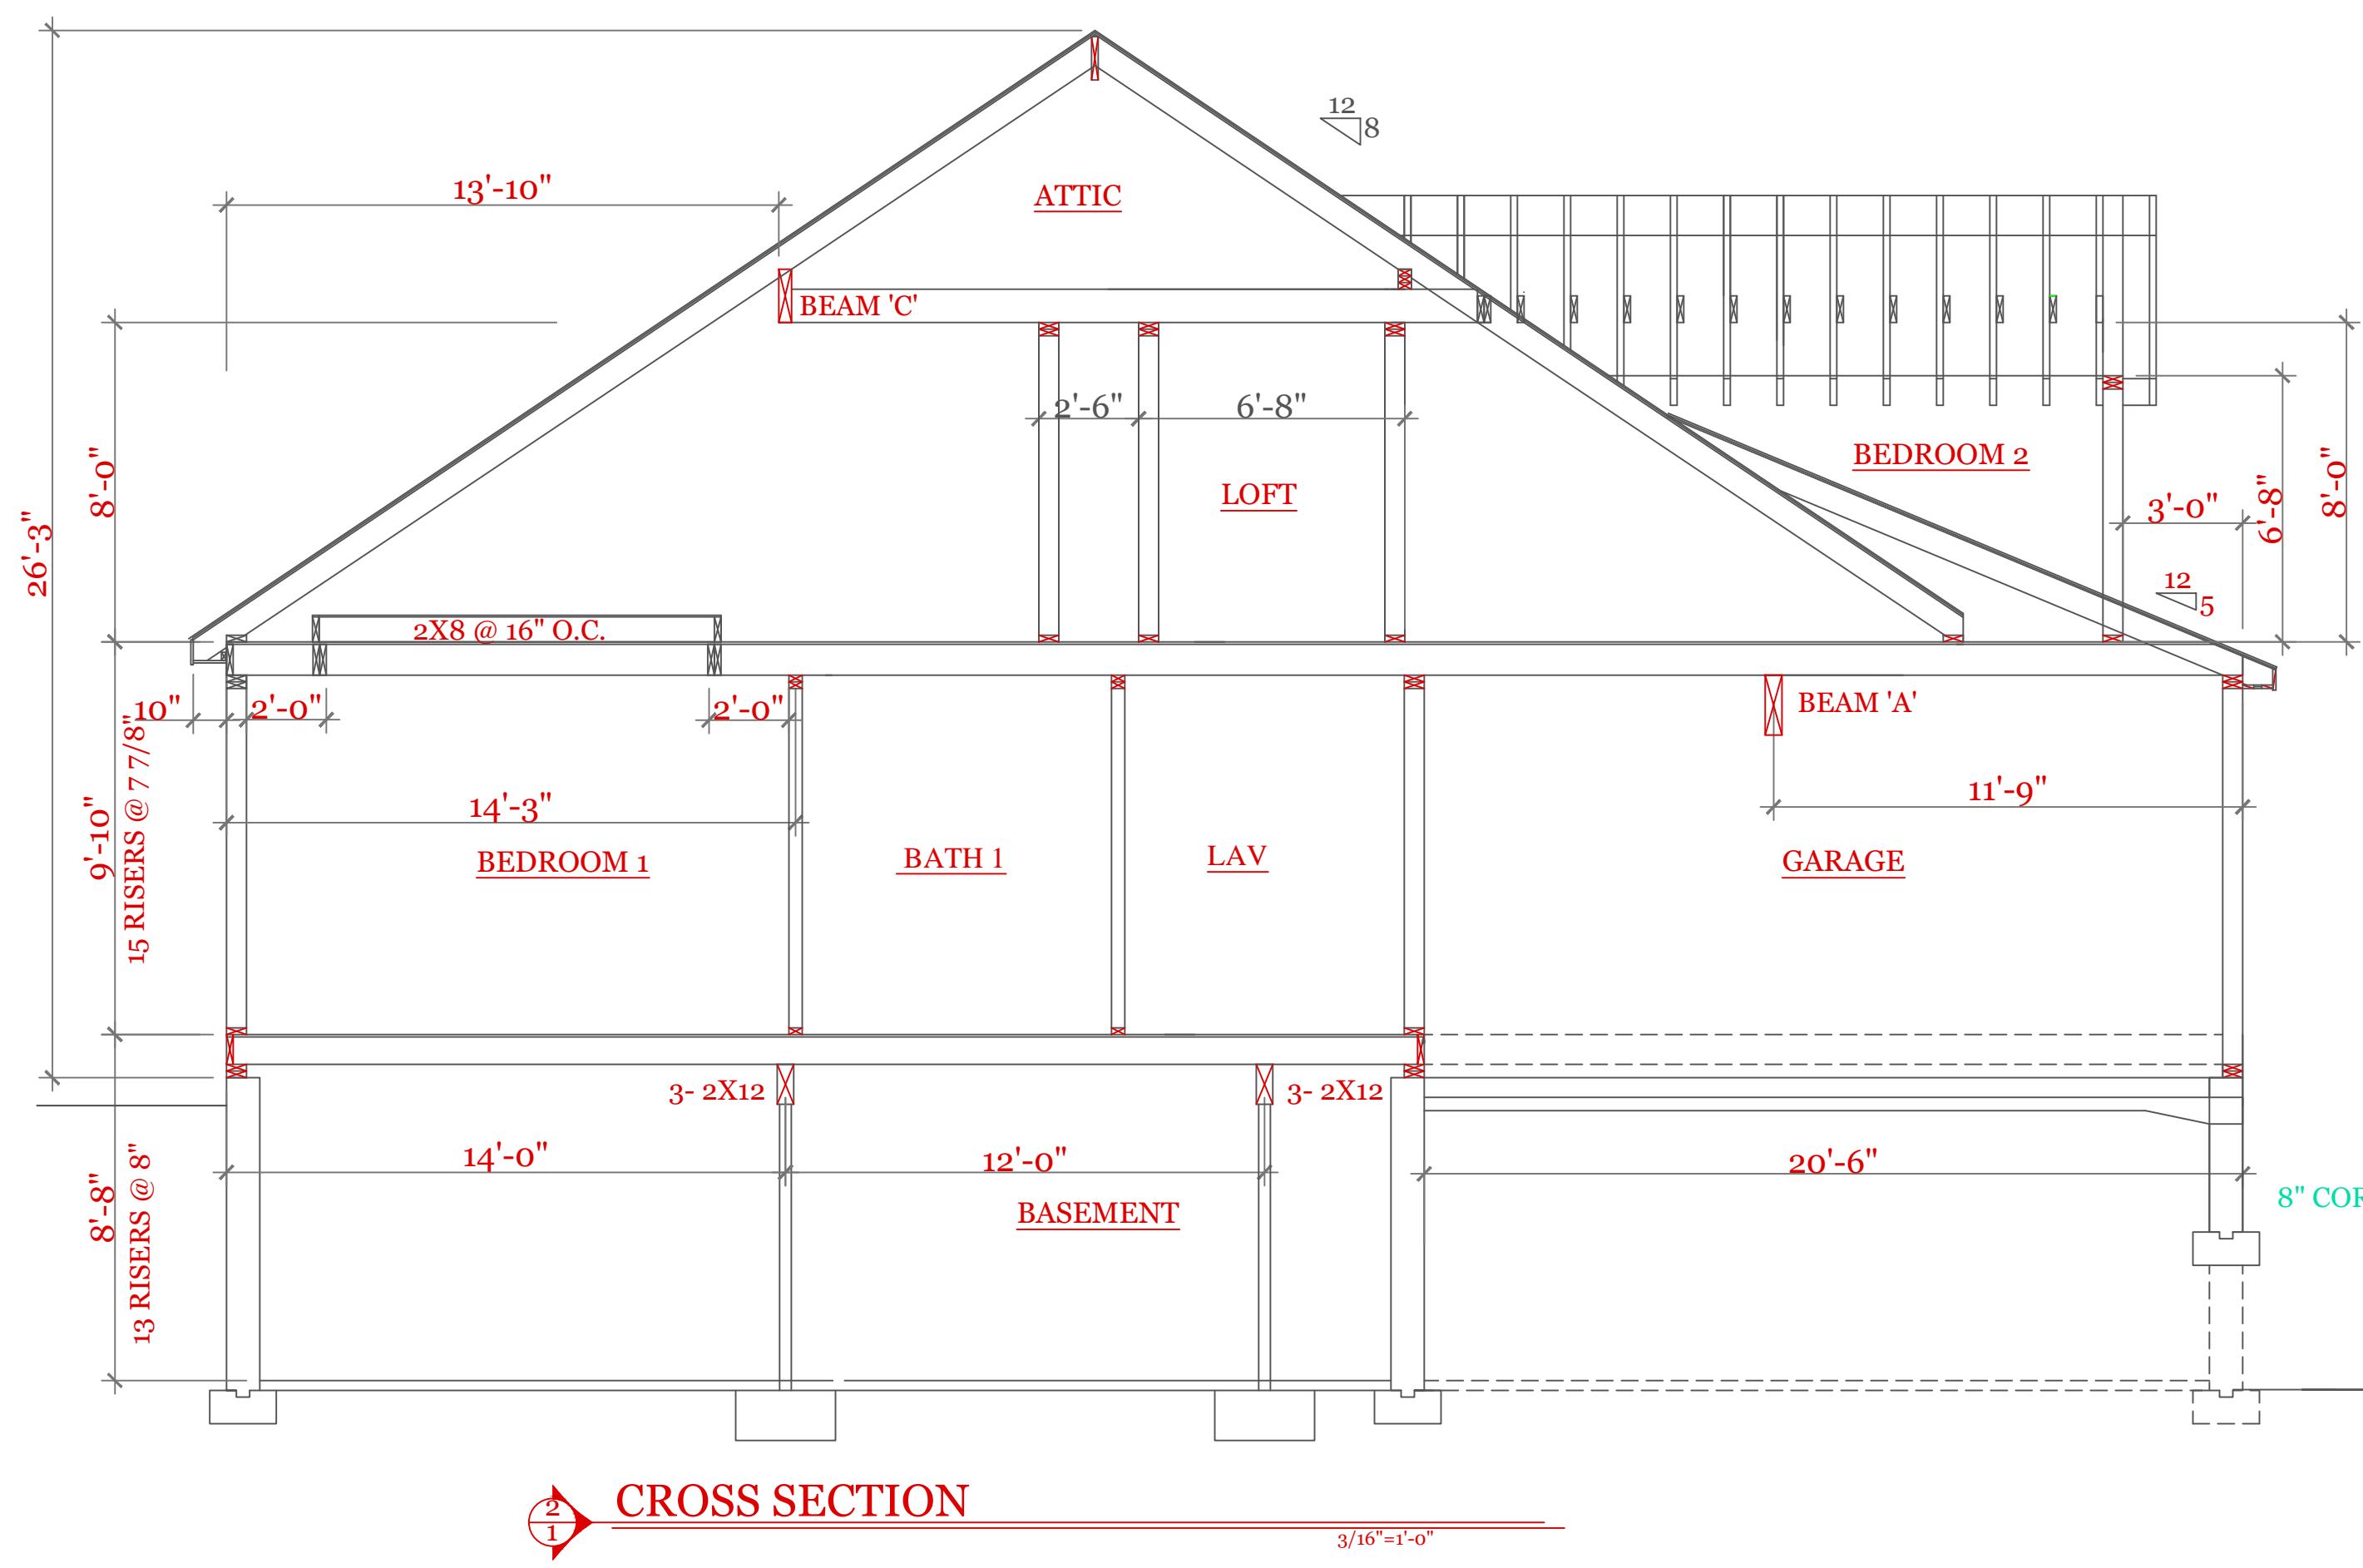
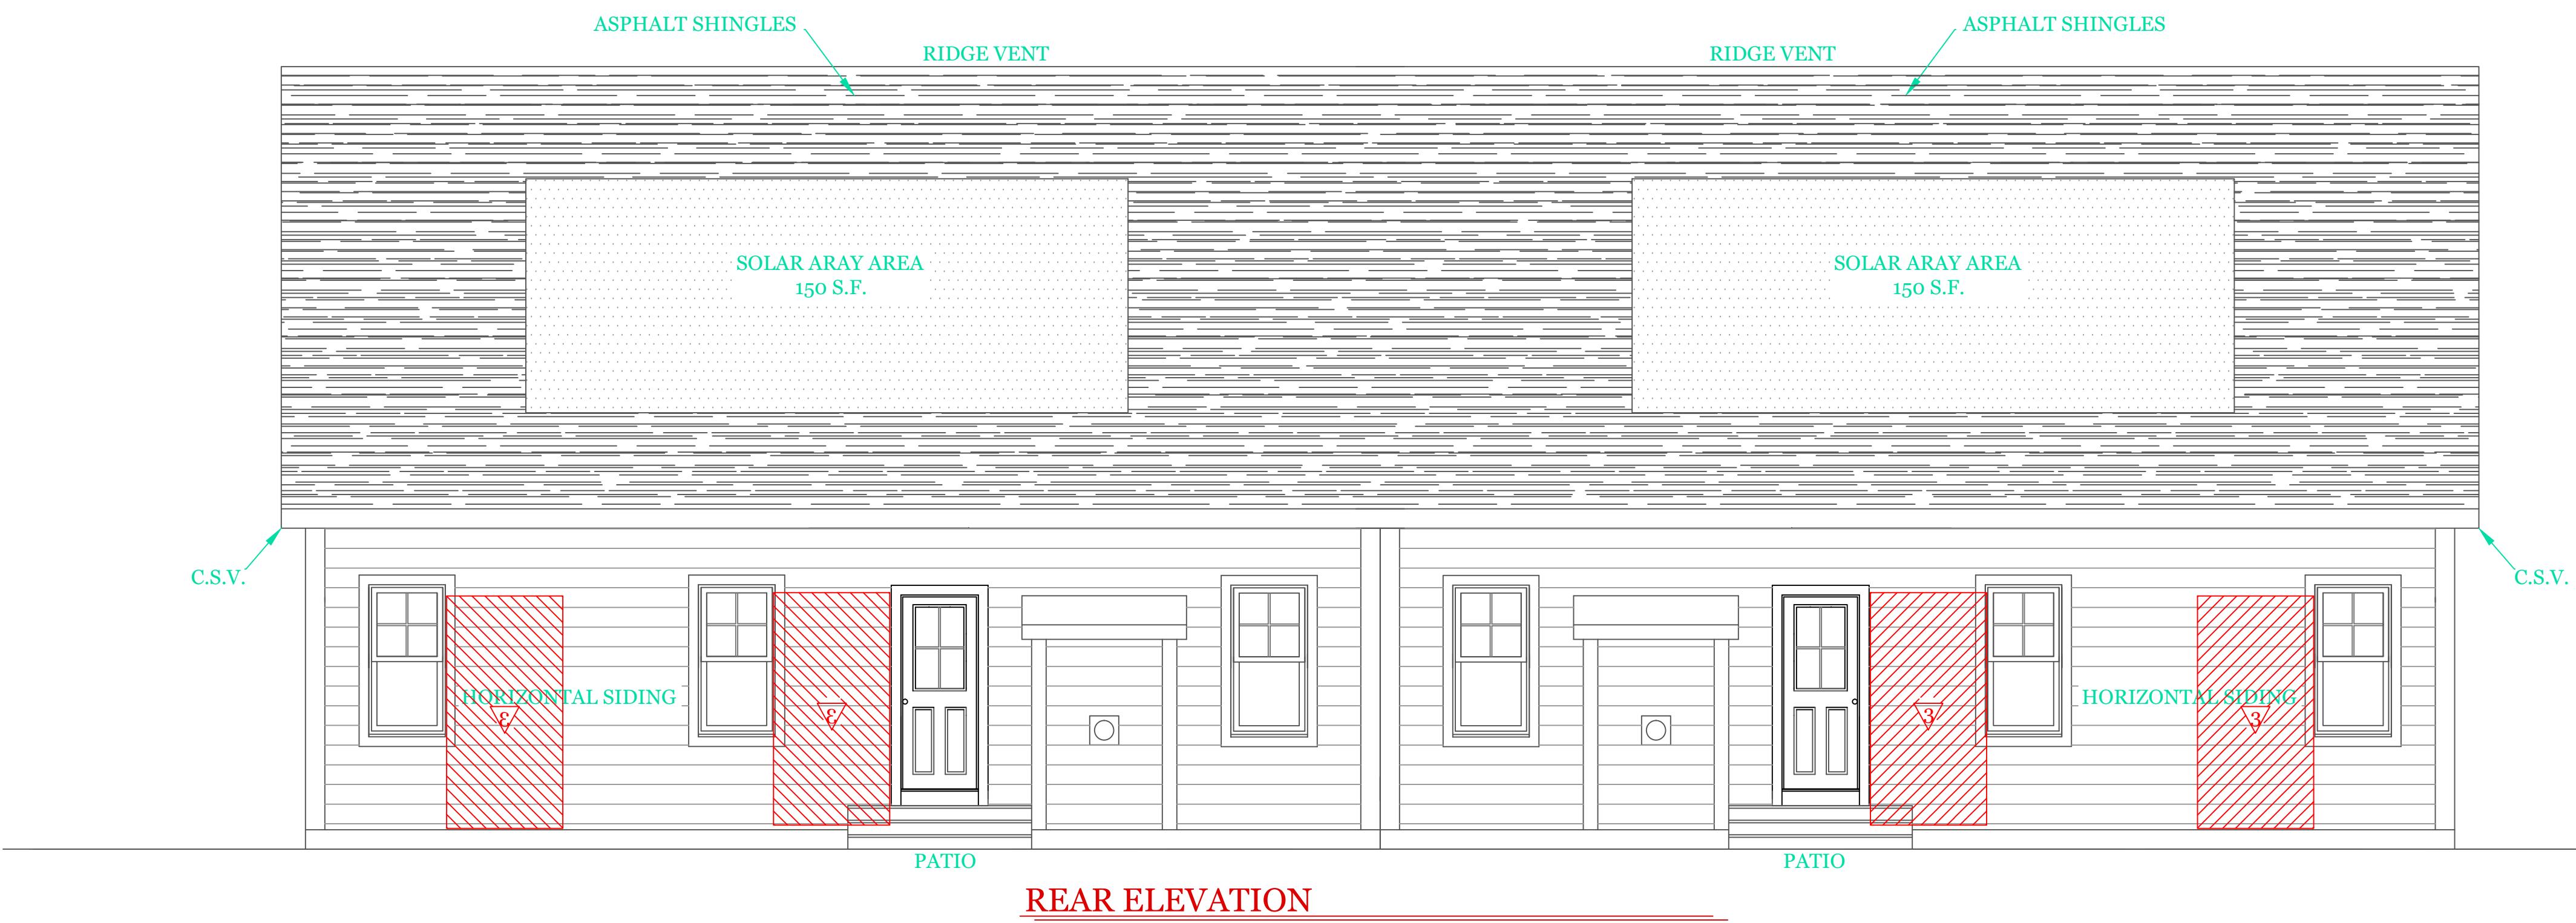
CONSULTING ENGINEER
MICHAEL J. BURKE P.E.
209 SALISBURY STR.
WORCESTER, MA
(508)450-3461

UNIT 'B' DUPLEX
HIGGINS FARM AT
SALISBURY HILL
FRONT & LEFT SIDE
ELEVATIONS
DESIGN CRITERIA

UNIT 'B' DPLX
DATE: 9/21/2022 R5/5
SCALE: 1/4"=1'-0"
DRAWN BY: RCS
CHECKED BY: MJB

Sheet 1 OF 8
1

NOTES:



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WORCESTER, MA
(508)450-3461

**UNIT 'B' DUPLEX
HIGGINS FARM AT
SALISBURY HILL**

**RIGHT & REAR
ELEVATIONS
SECTION 1**

UNIT 'B' DPLX

DATE: 9/21/2022 R5/5

SCALE: 1/4"=1'-0"

DRAWN BY: RCS

CHECKED BY: MJB


Sheet 2 OF 8

2

NOTES:

SYMBOL SCHEDULE:

V	VENT
SC	SMOKE AND CARBON DETECTOR
S	SMOKE DETECTOR
H	HEAT DETECTOR
■	BEARING POINT W/ SQUASH BLOCK

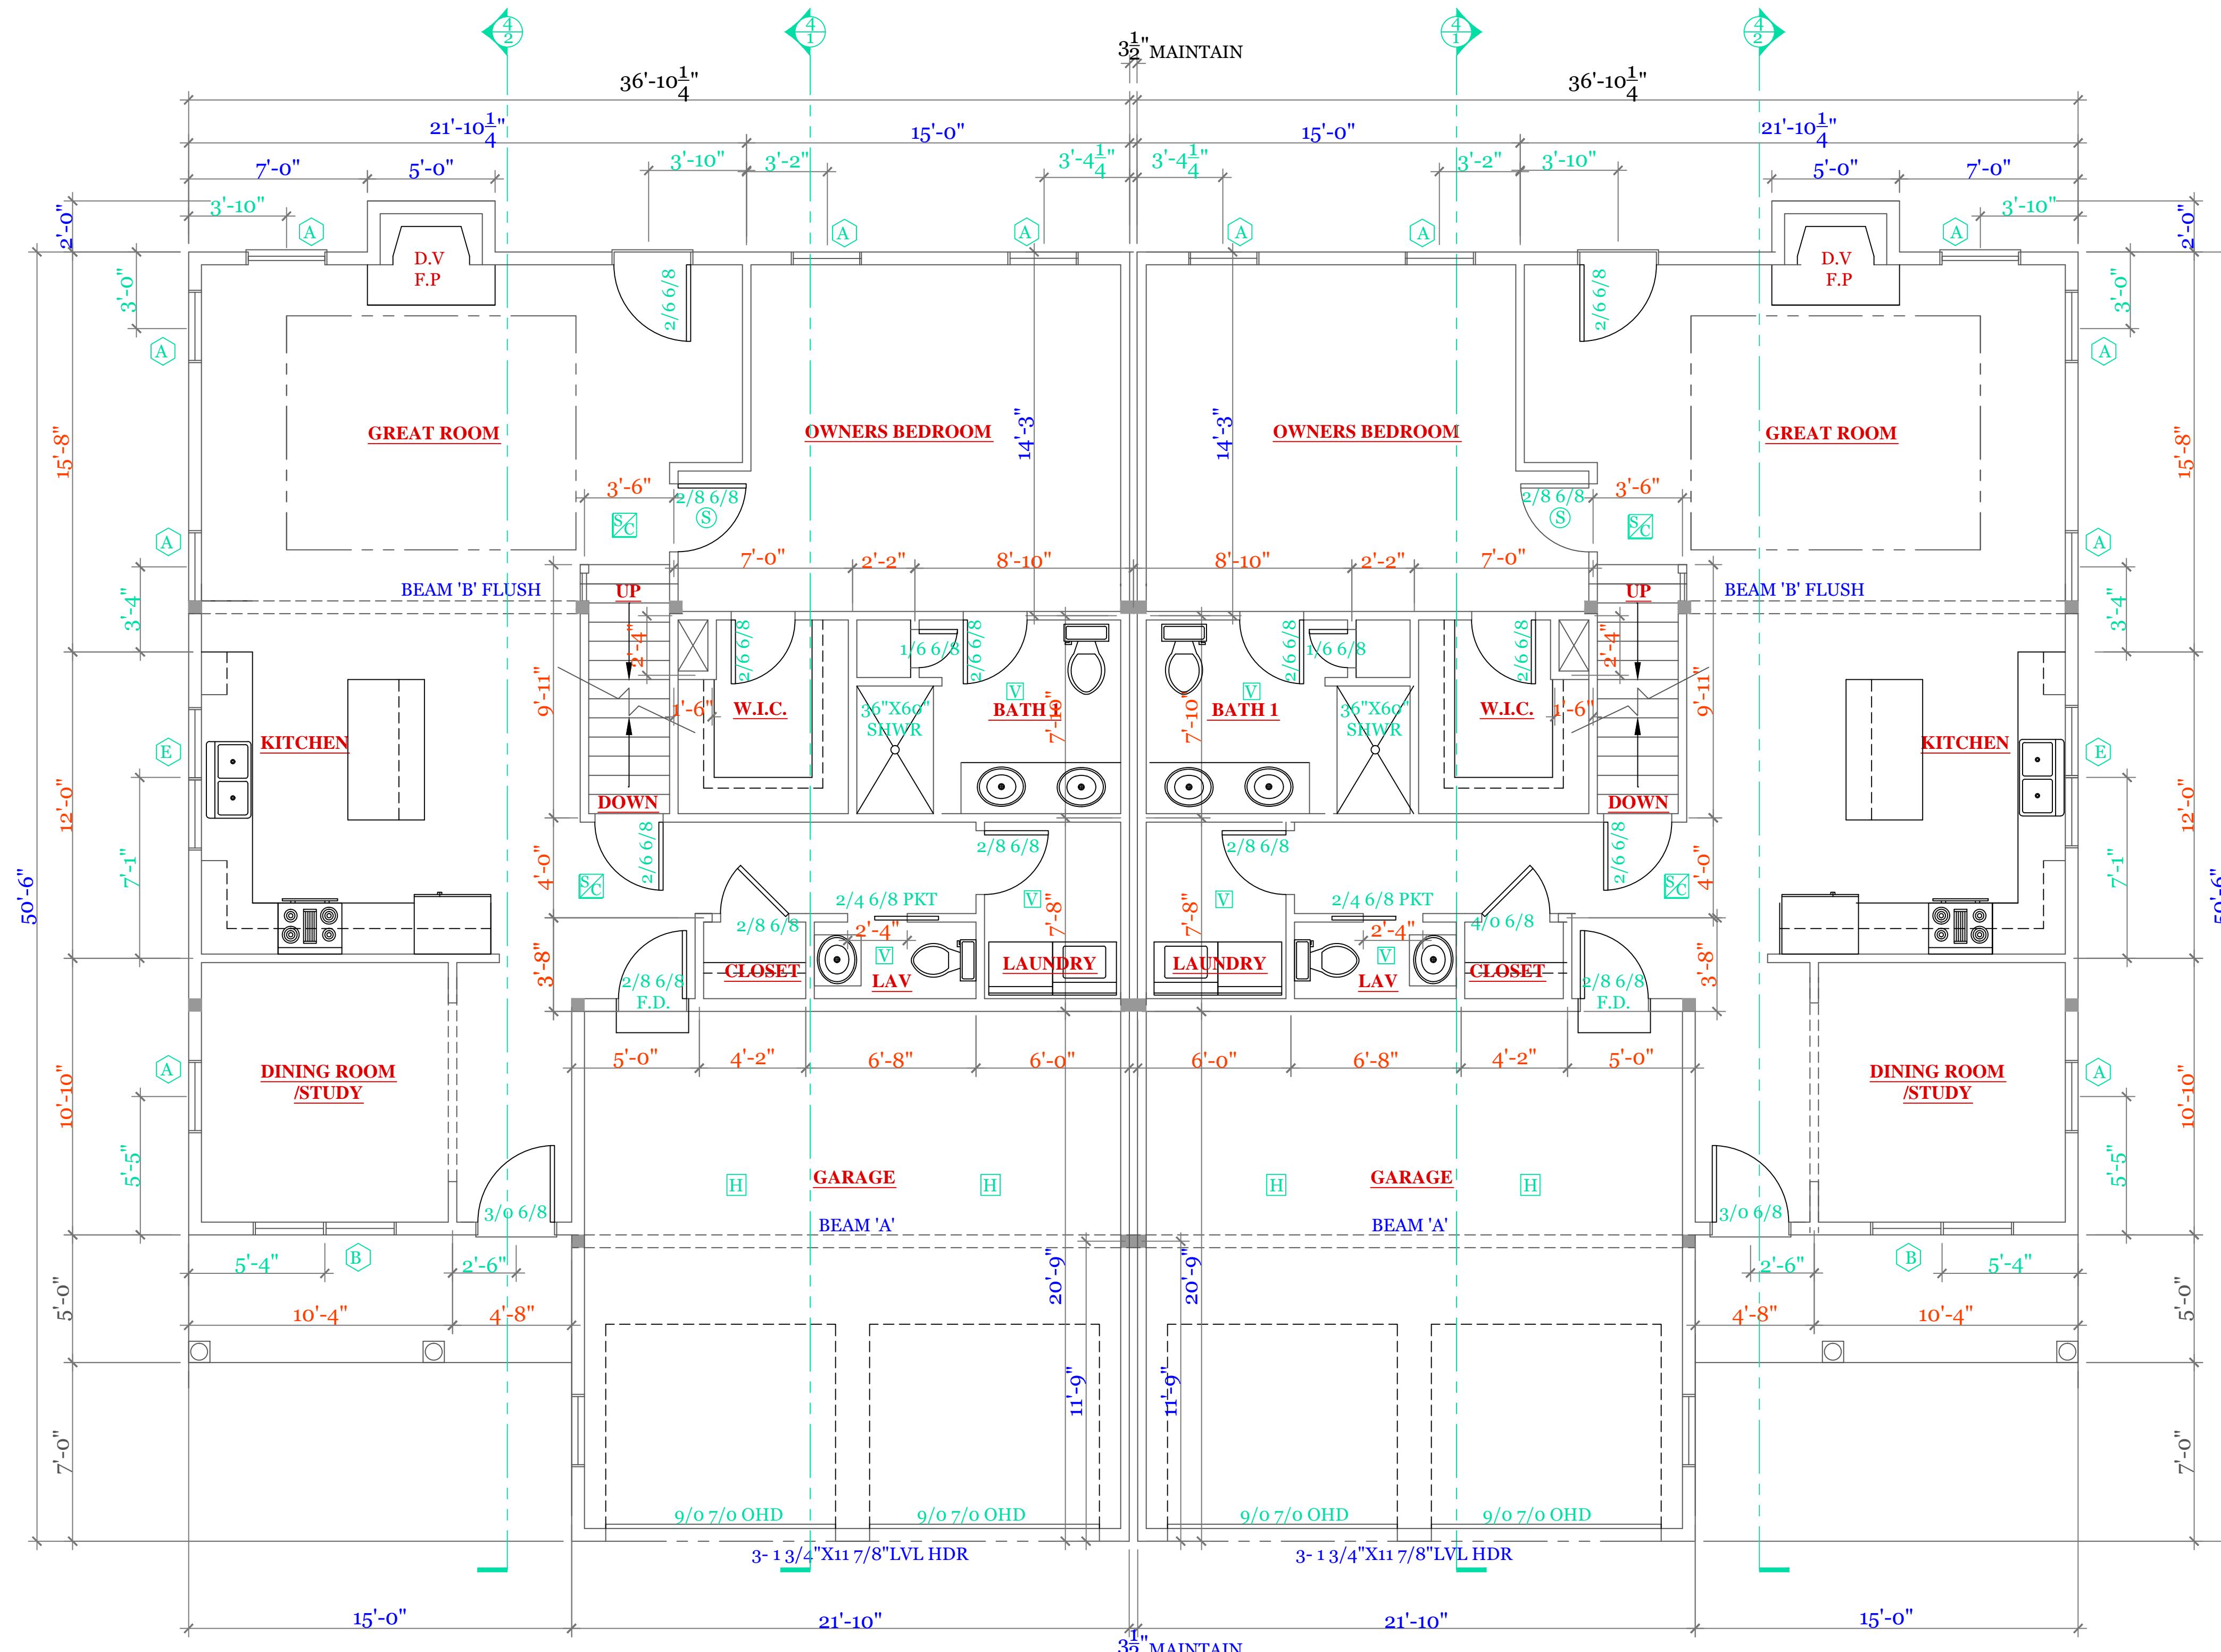

FIRST FLOOR PLAN (1231 s.f. GARAGE 448 s.f.)

WINDOW SCHEDULE: LANSING			
INDEX	QUA	CATALOG	ROUGH OPENING
A	6	10000-1	2'-8 1/8" X 5'-6"
B	1	11000-1	5'-4 1/2" X 5'-6"
C	2	12000-1	5'-4 1/2" X 4'-9"
D	0	XXX	XXX
E	1	14000-1	4'-0 1/2" X 3'-5 3/8"

NOTES: CONSULT TABLE 603.7(1) JACKS & HEADERS

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MICHAEL J. BURKE P.E.
299 SALISBURY ST.
WORCESTER, MA
(508)450-3461UNIT "B" DUPLEX
HIGGINS FARM AT
SALISBURY HILLFIRST FLOOR PLAN
WINDOW SCHEDULE

UNIT 'B' DPLX

DATE: 9/21/2022 R5/5



SCALE: 1/4"=1'-0"

DRAWN BY: RCS

CHECKED BY: MJB


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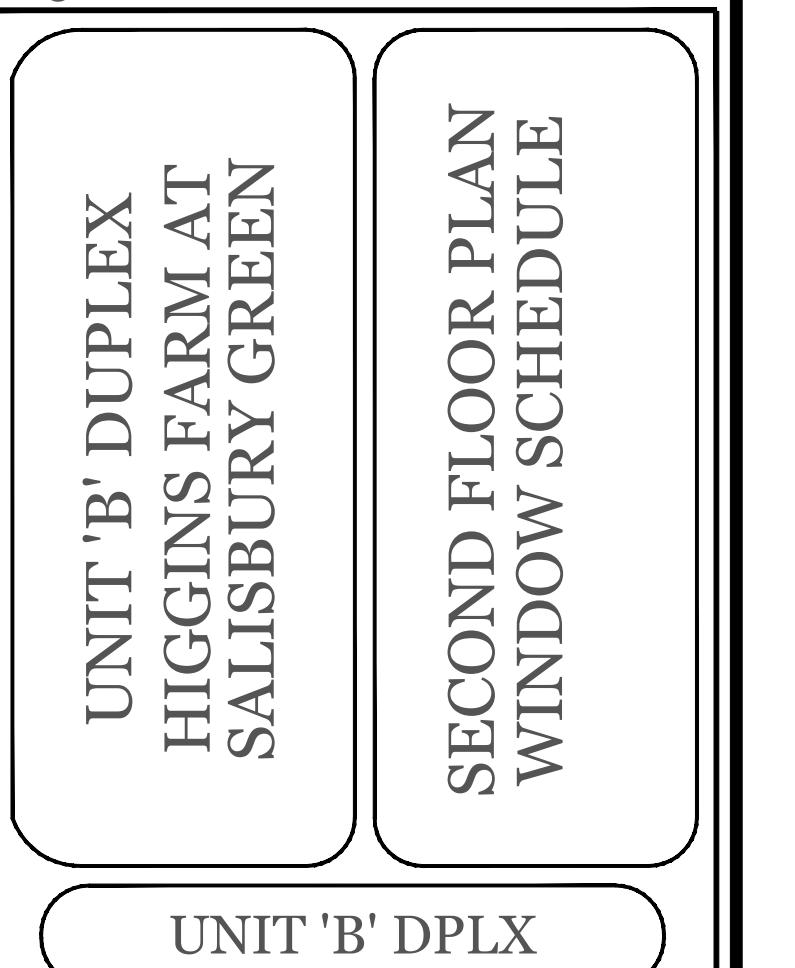


WINDOW SCHEDULE: LANSING			
INDEX	QUA	CATALOG	ROUGH OPENING
A	6	10000-1	2'-8 1/8" X 5'-6"
B	1	11000-1	5'-4 1/2" X 5'-6"
C	2	12000-1	5'-4 1/2" X 4'-9"
D	0	XXX	XXX
E	1	14000-1	4'-0 1/2" X 3'-5 3/8"

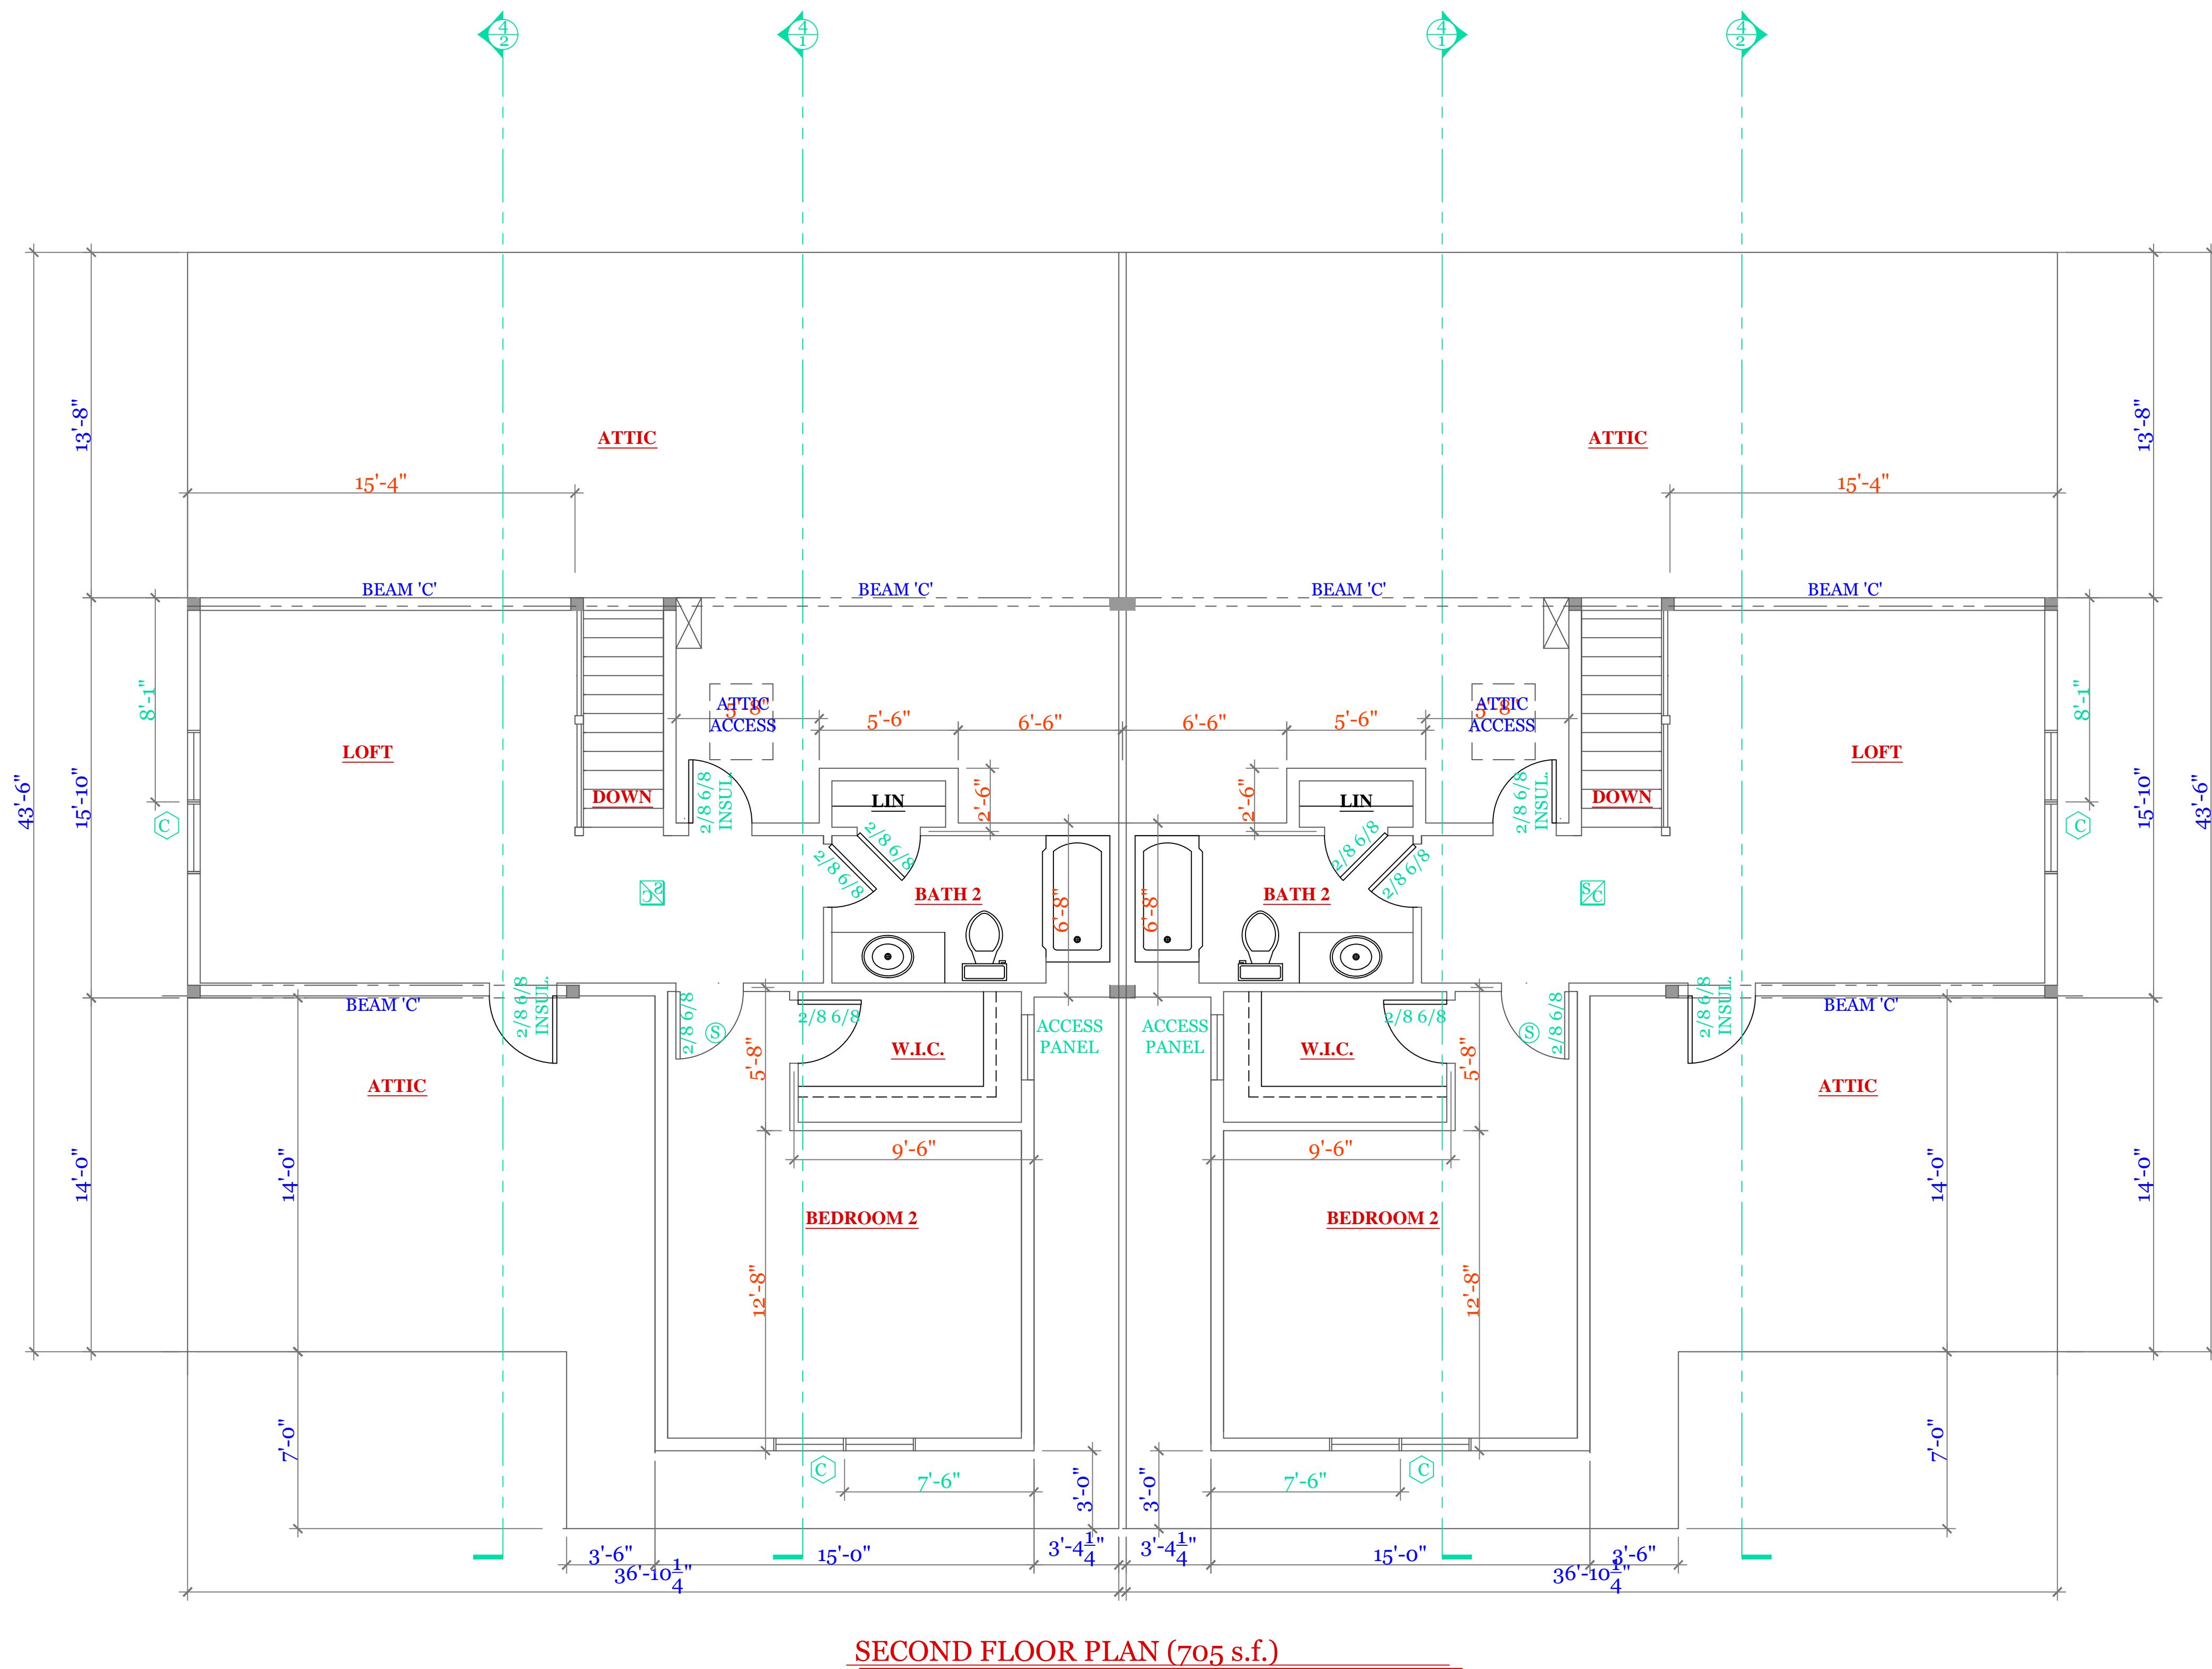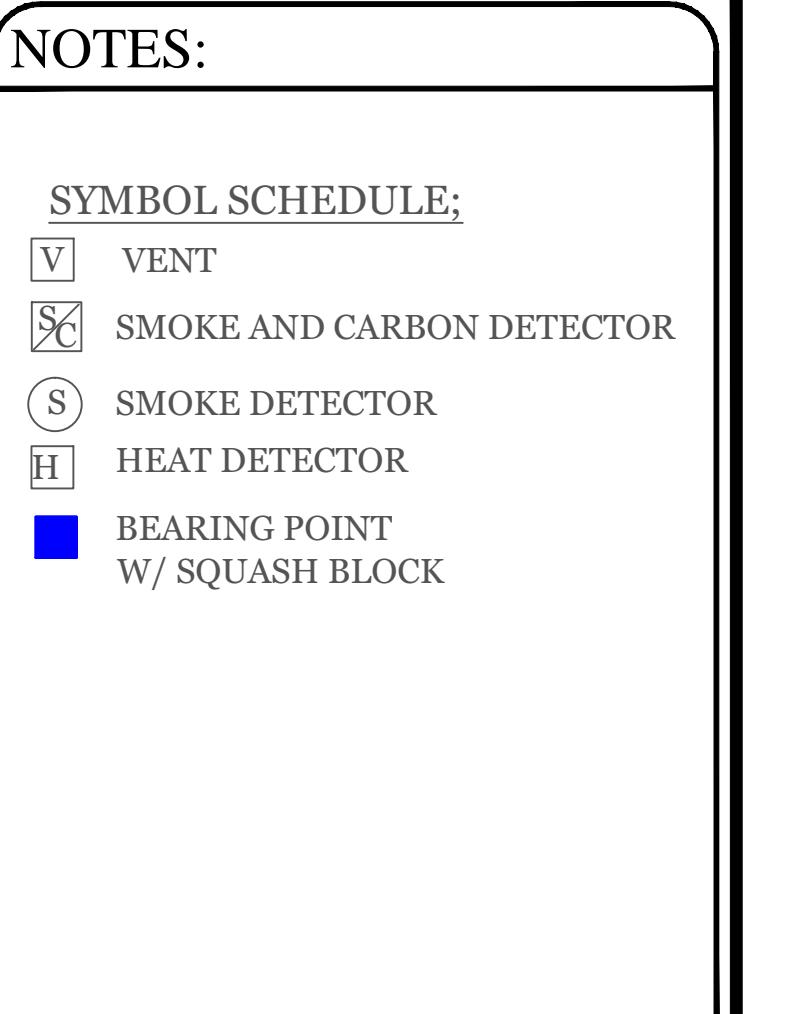NOTES: CONSULT TABLE 603.7(1) JACKS & HEADERS






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DATE: 9/21/2022 R5/5
SCALE: 1/4"=1'-0"
DRAWN BY: RCS
CHECKED BY: MJB
Sheet 5 OF 8

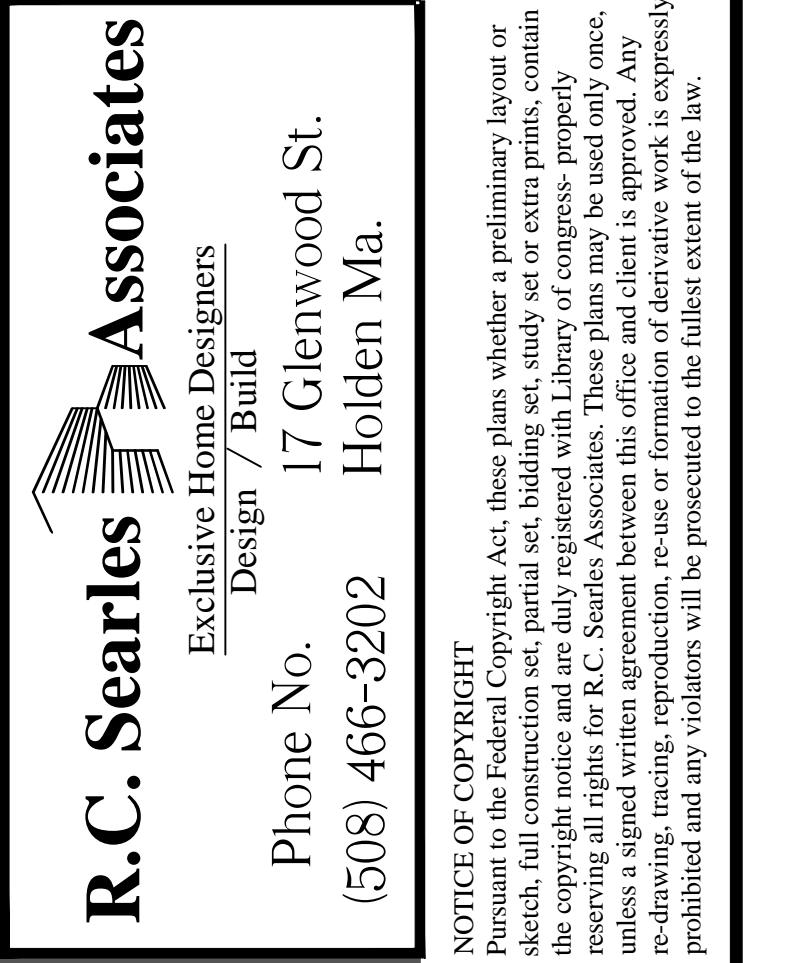5


TYPICAL BUILDING SECTION



CONSTRUCTION SCHEDULE:		(UNLESS NOTED OTHERWISE ON PLAN)
1	RIDGE BOARD:	SEE FRAMING W/ RIDGE VENT
2	ROOF MATERIAL:	ASPHALT SHINGLES ON 15# ROOF FELT
3	ROOF SHEATHING	1/2" O.S.B. w/ 15# ROOF FELT
4	ROOF RAFTER:	SEE FRAMING
5	COLLAR TIES:	1X8 @ 32" O.C.
6	DRIP EDGE	ALUMINUM DRIP EDGE
7	SOFFIT:	CONT. SOFFIT VENT
8	CEILING JOIST	SEE FRAMING
9	ATTIC INSULATION	R-38
10	EXT WALL:	2"X6" @ 16" O.C.
11	EXT. SHEATHING	1/2" O.S.B. w/ HOUSE WRAP
12	EXT. FINISH	SEE ELEVATIONS
13	INSULATION@WALL	R-21
14	INTERIOR WALL	2"X4" @ 16" O.C.
15	SUB FLOOR:	3/4" ADVANTEK GLUED & NAILED
16	JOIST:	SEE FRAMING.
17	SILL:	2"X6" P.T. SILL W/ 2X6 KD TOP PLATE
18	INSULATION @ FLOOR	R-30
19	ANCHOR:	1/2" Ø STL ANCHOR BOLTS
20	BEAM:	SEE FRAMING PLAN
21	COLUMN:	3 1/2" L.C.
22	FND. WALL:	10"X7"-10" CONC. WALL
23	SLAB:	SEE FOUNDATION NOTES
24	FOOTING:	20"X10" CONT. KEYED FTNG
25	CONC. PAD:	30"X30"X15" CONC. PAD

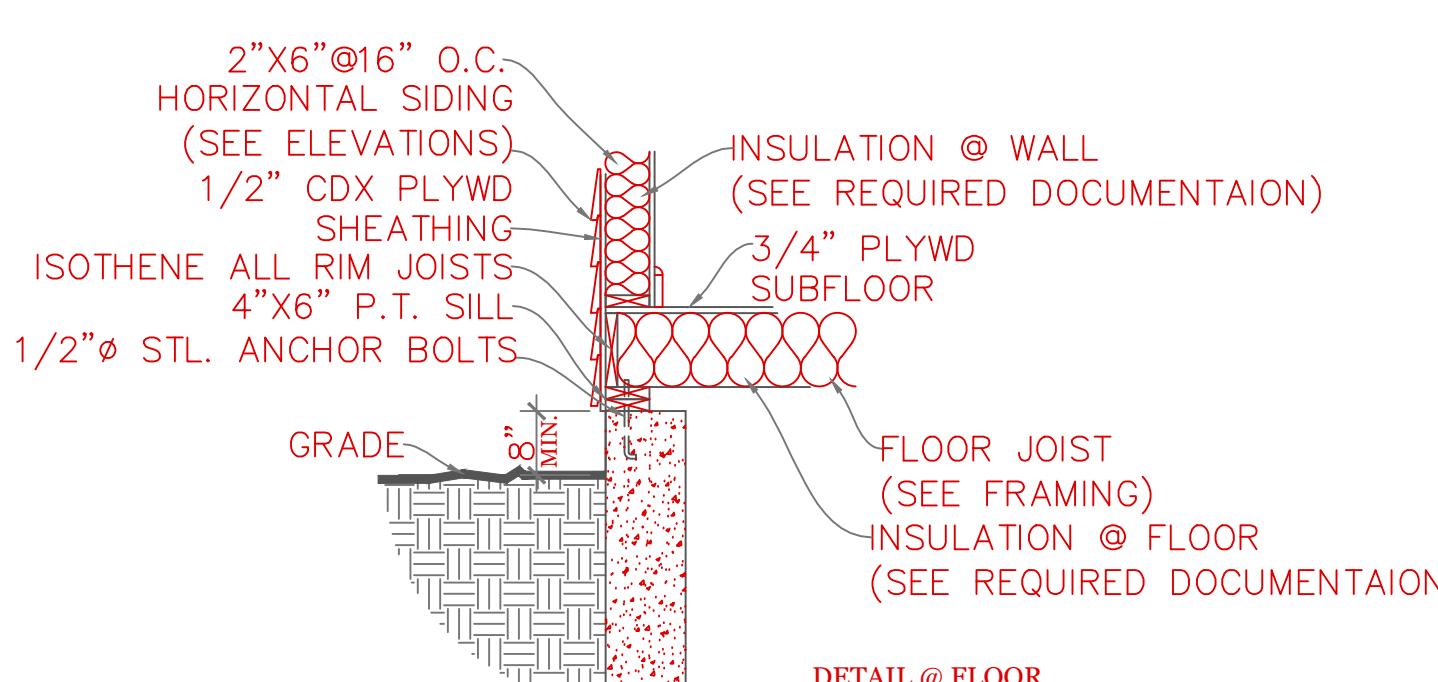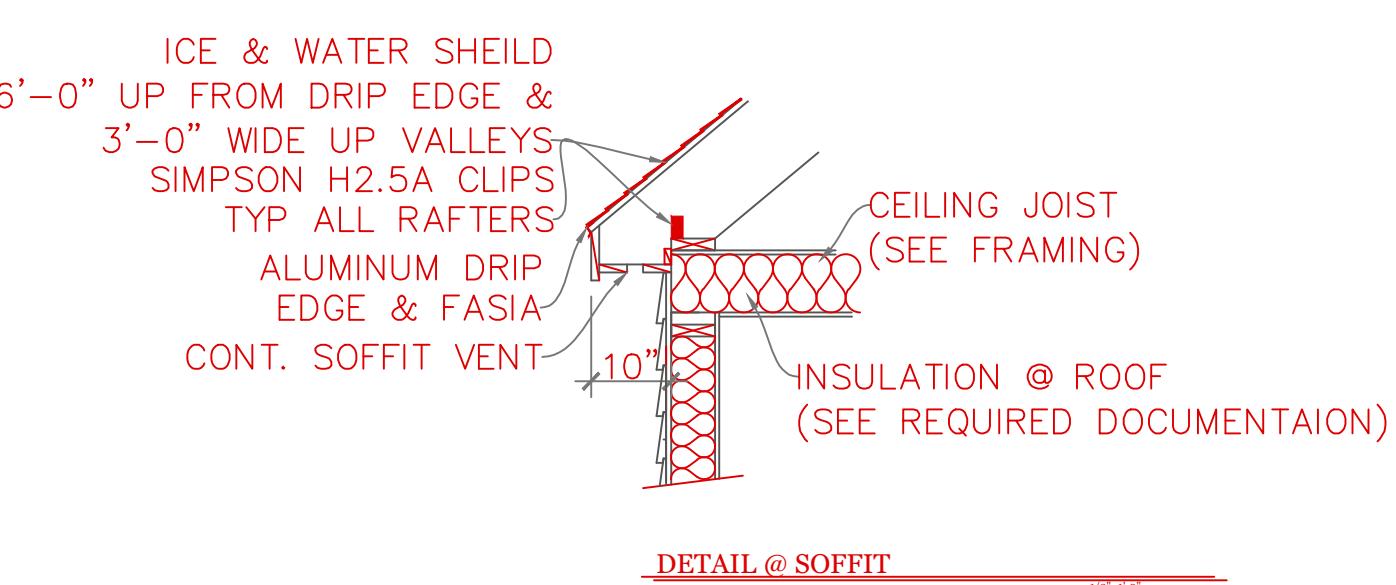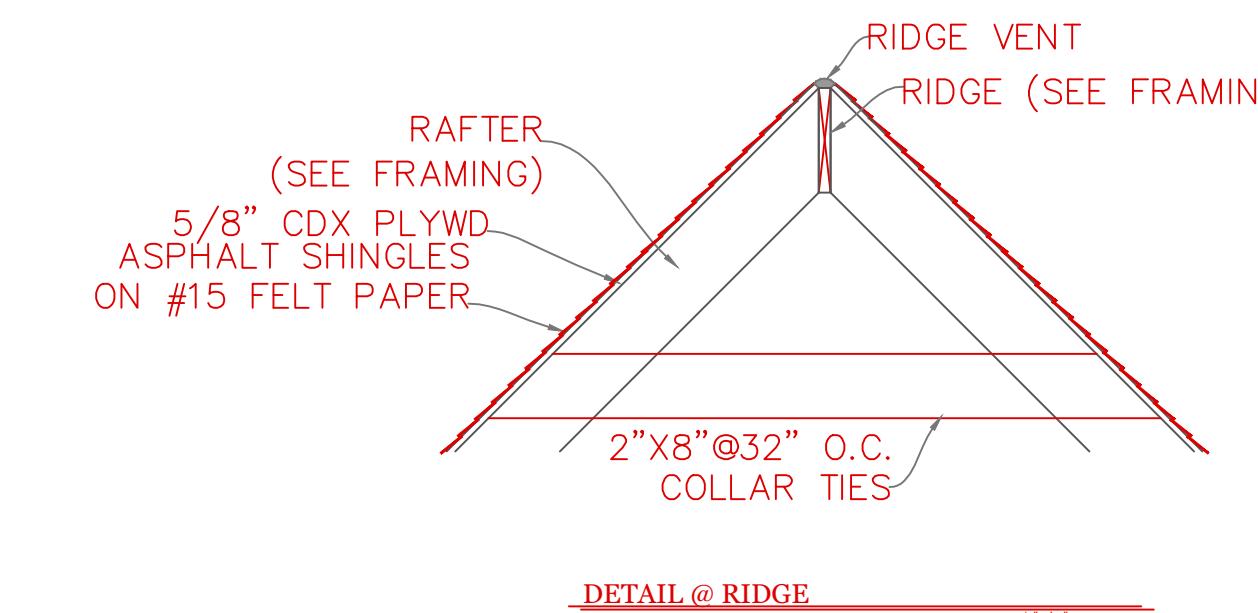NOTES: -ISOTHENE ALL RIM JOISTS (OPTIONAL)
-ICE & WATER SHEILD 6'-0" UP FROM DRIP EDGE
& 3'-0" WIDE UP VALLEYS

DUPLEX BUILDING ONLY

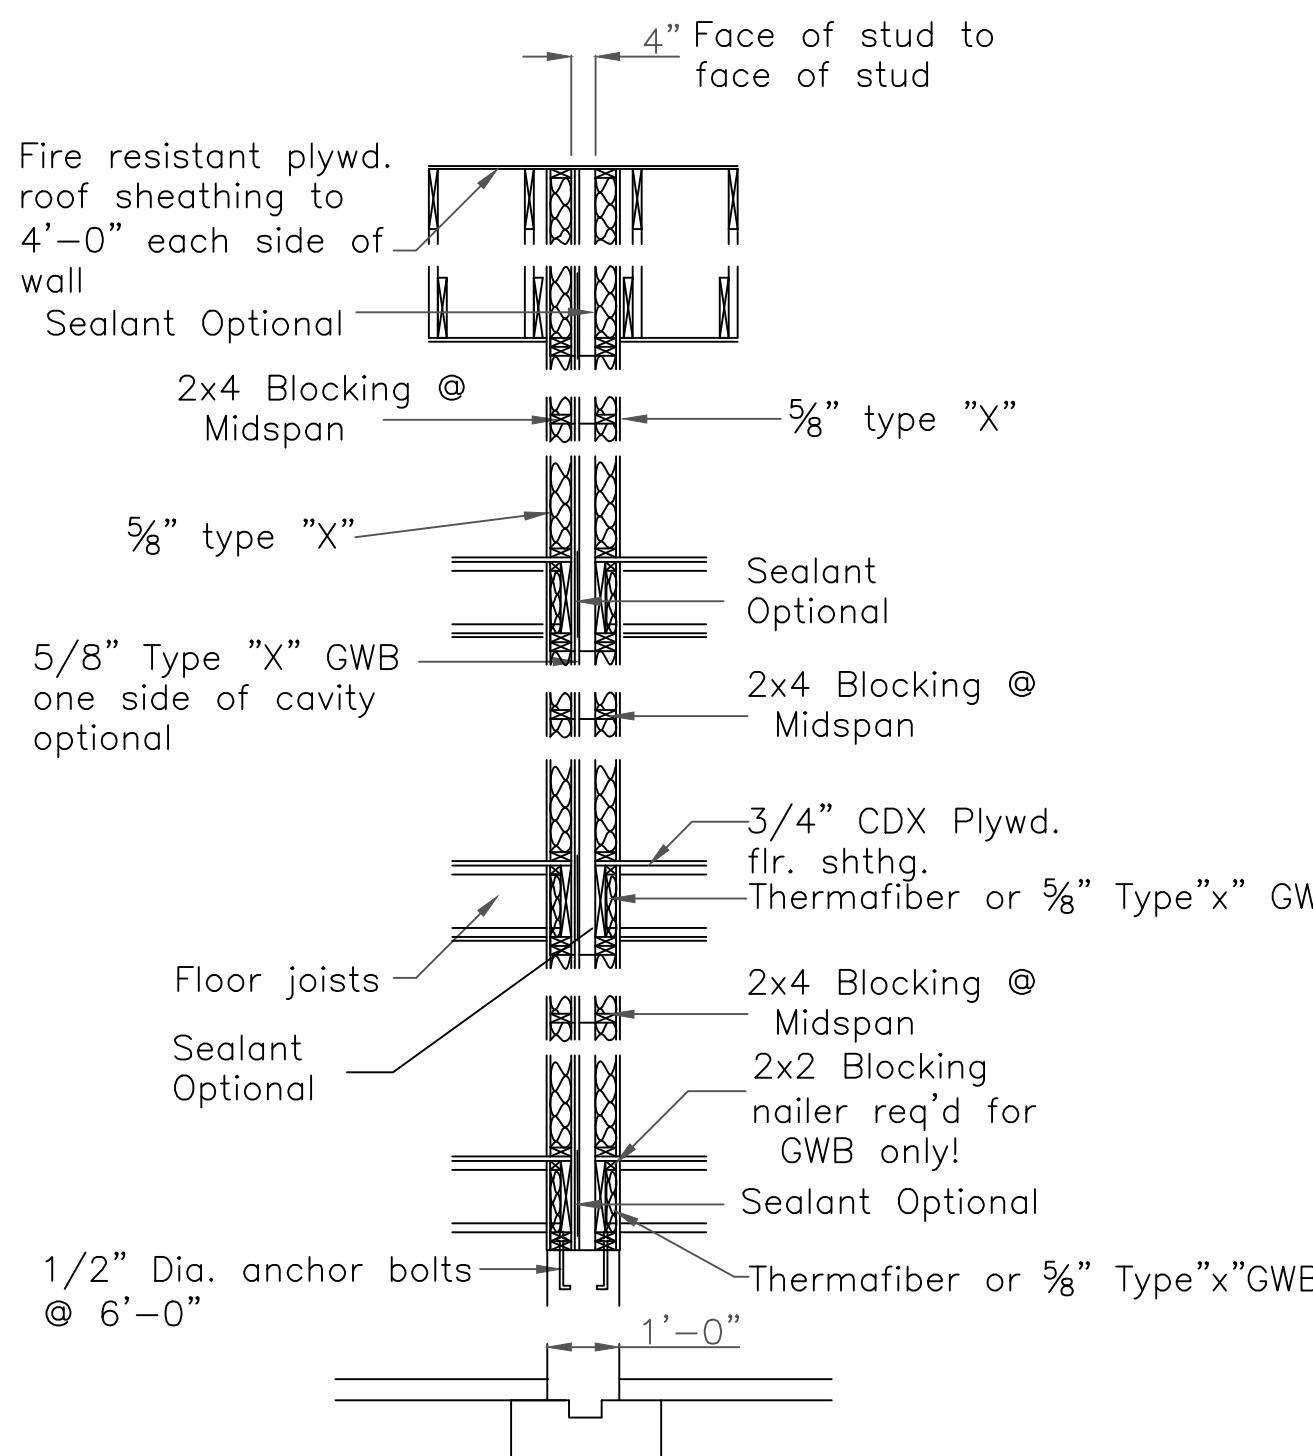


A Fire Resistance Rated Wall Section


For more information see U.L. LISTING --- U-305
STC Rating = 56
Bearing wall Rating = 1 HR.

FIRE RESISTANCE RATINGS - ANSI/UL 263 (BXUV)

DESIGN NO. U366
Bearing Wall Rating - 2 HR
Finish Rating - 120 MIN.
STC 60-64

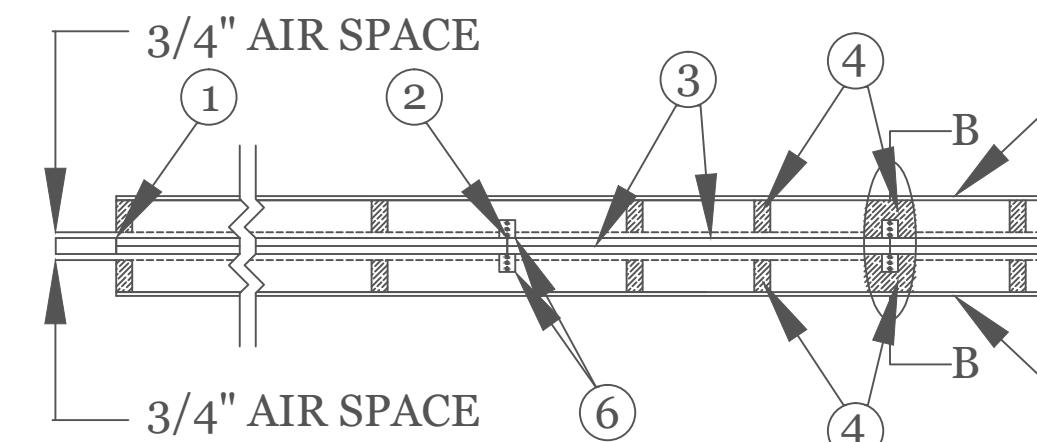

CONFIGURATION B
EXPOSED TO FIRE FROM EITHER SIDE

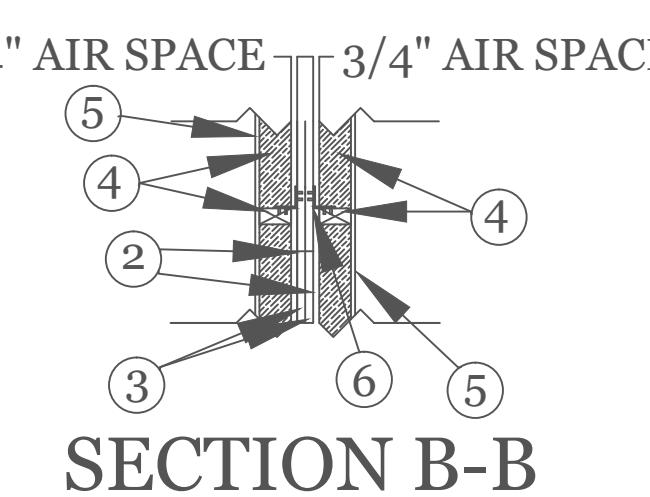

SECTION B-B

AREA SEPARATION WALL: - (Max Height - 44 ft)

1. Floor, Intermediate or Top Wall - 2 in. wide channel shaped with 1 in. long legs formed from No. 25 MSG galv steel, secured with suitable fasteners spaced 24 in. O.C.

2. Steel Studs - Steel members formed from No. 25 MSG galv steel having "H" - shaped flanged spaced 24 in. O.C.; overall depth 2in. and flange width 1-3/8 in.

3. Gypsum Board* - Two layers of 1 in. thick gypsum wallboard liner panels, supplied in nom 24 in. widths. Vertical edges of panels friction fitted into "H" - shaped studs.

BPB AMERICA INC - ProRoc Shaftliner

JAMES HARDIE GYPSUM INC - ProRoc Shaftliner

PROTECTED WALL: - (Bearing or Nonbearing Wall)

4. Wood Studs - Nom 2 by 4 in. max spacing 16 in. O.C. Studs cross-braced at midheight where necessary for clip attachment. Min 3/4 in. separation between wood framing and area separation wall.

5. Gypsum Board - Classified or Unclassified - Min. 1/2 in. thick, 4 ft. wide, applied either horizontally or vertically. Wallboard attached to studs with 1-1/4 in. long steel drywall nails space 8 in. O.C. Vertical joints located over studs. (Optional) Joints covered with paper tape and joint compound. Nail heads covered with joint compound.

6. Attachment Clips - Aluminum angle; 0.063 in. thick, min 2 in. wide with min 2 in. and 2-1/4 in. legs. Clips secured with Type S screws 3/8 in. long to "H" studs and with Type W screws 1-1/4 in. long to wood framing through holes provided in clip. Clips spaced a max of 10ft. O.C. vertically between wood framing and "H" studs for separation walls up to 23 ft. high. For separation walls up to 44 ft. high, clips spaced as described above for the upper 24 ft. and the remaining wall area below requires clips spaced a max of 5 ft. O.C. vertically between wood framing and "H" studs.


* Bearing the UL Classification Mark

NOTES:

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Design / Build
17 Glenwood St.
Holden Ma.


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CROSS SECTION

DESIGN CRITERIA											
GROUND SNOW LOAD	WIND SPEED (MPH)	SEISMIC DESIGN	WEATHERING	FROST LINE DEPTH	TERMITE	DECAY	WINTER DESIGN TEMP	ICE SHIELD UNDERLAYMENT REQUIRED	FLOOD HAZARD	AIR FREEZING INDEX	MEAN ANNUAL TEMP
TABLE 5301.2(5)	TABLE 5301.2(4)	N/A	FIGURE 5301.2(3)	4 ft. minimum unless engineered data shows otherwise	FIGURE 5301.2(6)	FIGURE 5301.2(7)	APPENDIX 780 CMR 120.J TABLE 120.J.3.2.1	As required by exterior roof covering manufacturer; roof pitch and local climate must also be considered	Refer to applicable Flood Insurance Rate Map (FIRM)	Only utilized in the design and construction of frost protected shallow foundations	Only utilized in the design and construction of frost protected shallow foundations
50 psf	124 mph	N/A	SEVERE	\$5403.1.4	MODERATE TO HEAVY	SLIGHT TO MODERATE	N/A	\$5905.0	FIRM MAPS	SEE NOTE K TABLE 5301.2(1)	SEE NOTE K TABLE 5301.2(1)

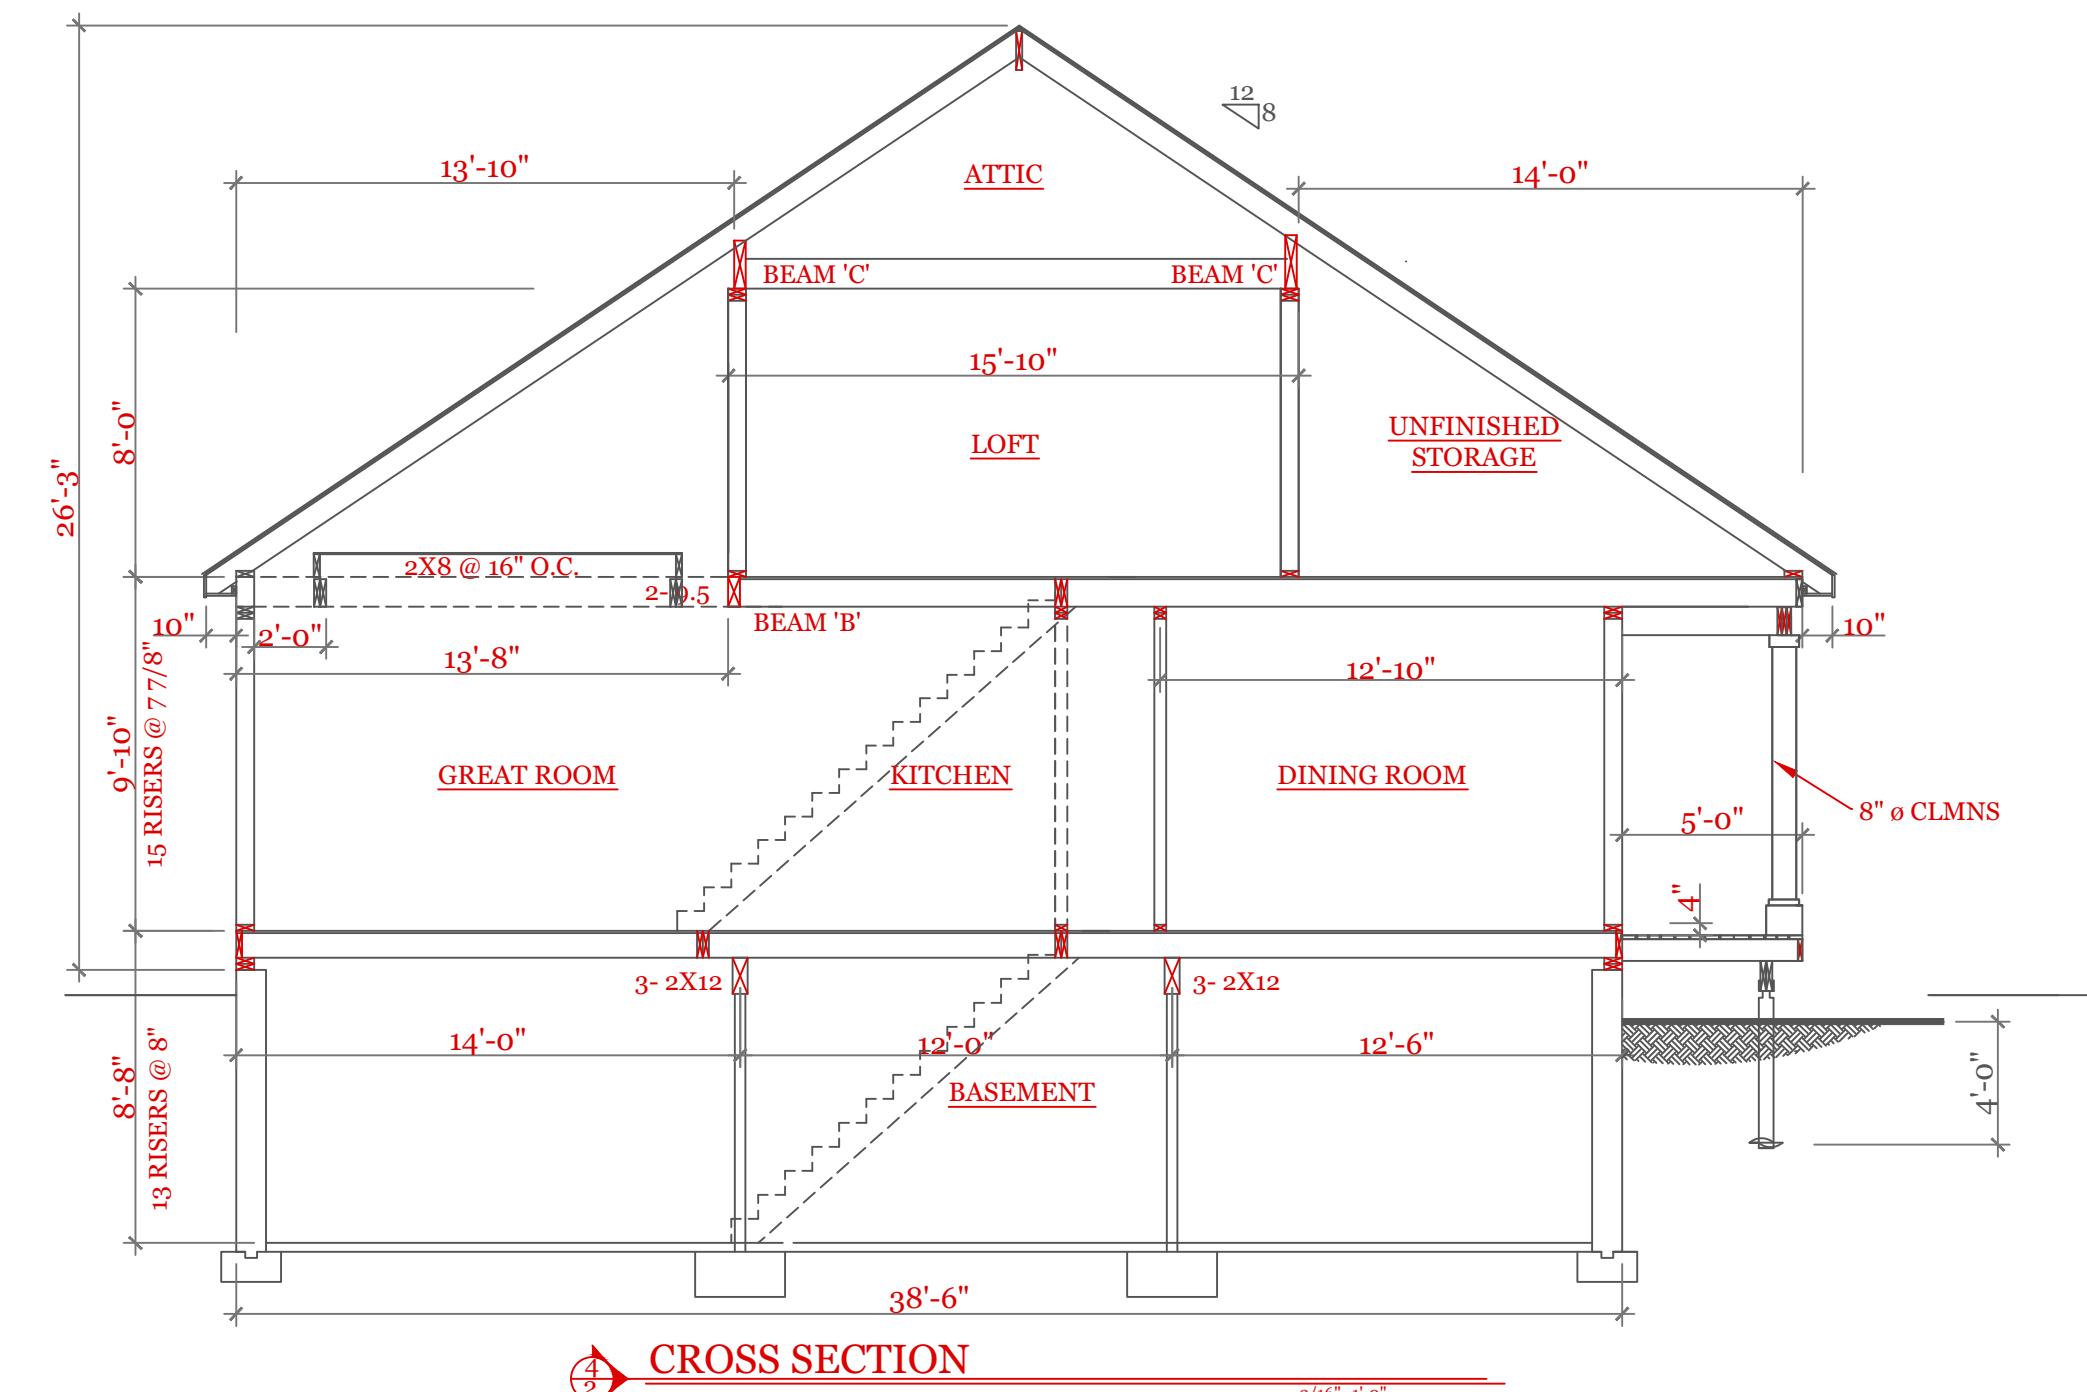

DATE: 9/21/2022 R5/5

SCALE: AS NOTED

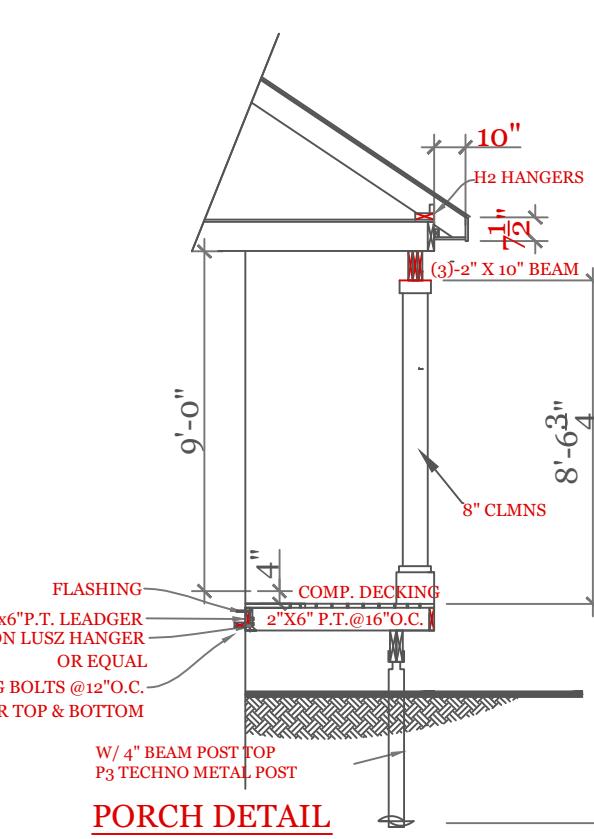
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CHECKED BY: MJB

Sheet 6 OF 8


UNIT 'B' DUPLEX
HIGGINS FARM AT SALISBURY HILL
BUILDING SECTIONS CONSTR. SCHEDULE DESIGN CRITERIA
UNIT 'B' DPLX

6

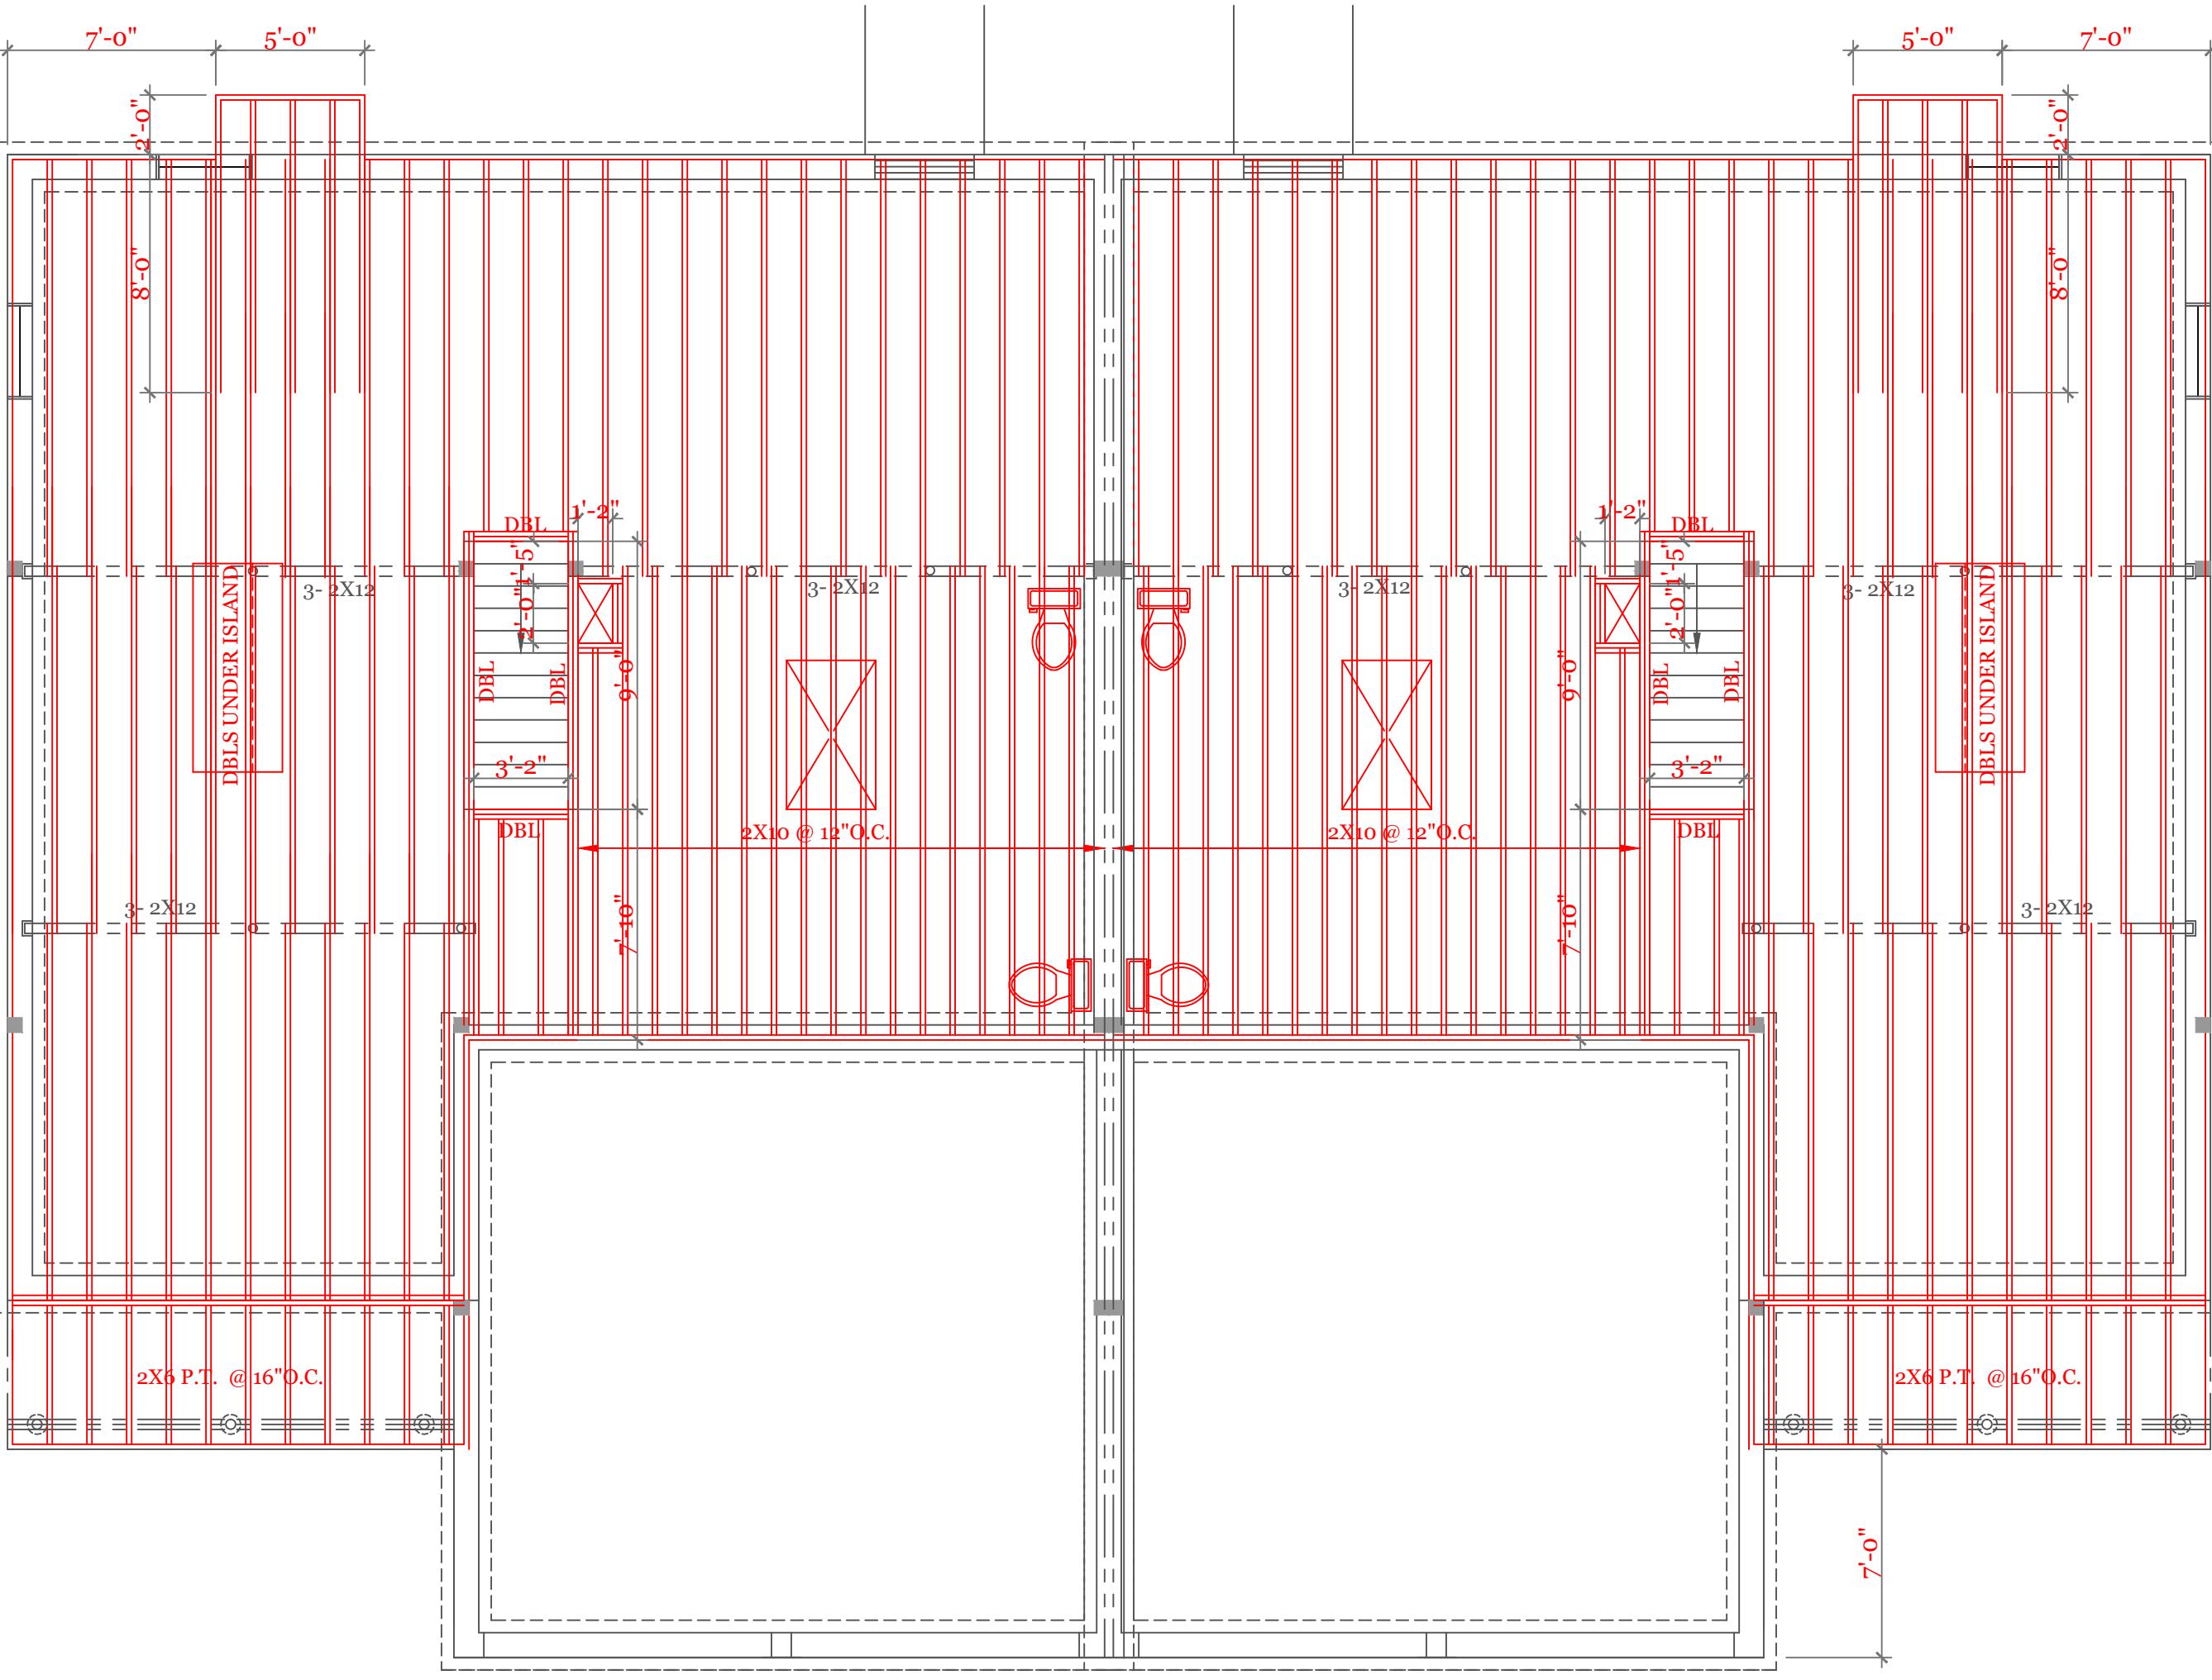

FIRST FLOOR FRAMING PLAN
2X10 @ 16'O.C. UNLESS NOTED
■ BEARING POINTS BLOCKED TO FOUNDATION OR BEAM SUPPORT.

BEAM CALCULATIONS					
BEAM	SIZE	SPAN	LIVE LOAD	TOTAL LOAD	MAX LIVE (PLF)
A	5 1/4" X 16" LVL	22'-0"	315	440	710
B	3 1/2" X 11 7/8" LVL	15'-0"	390	520	442
C	5 1/4" X 14" LVL ROOF	18'-0"	160	790	610

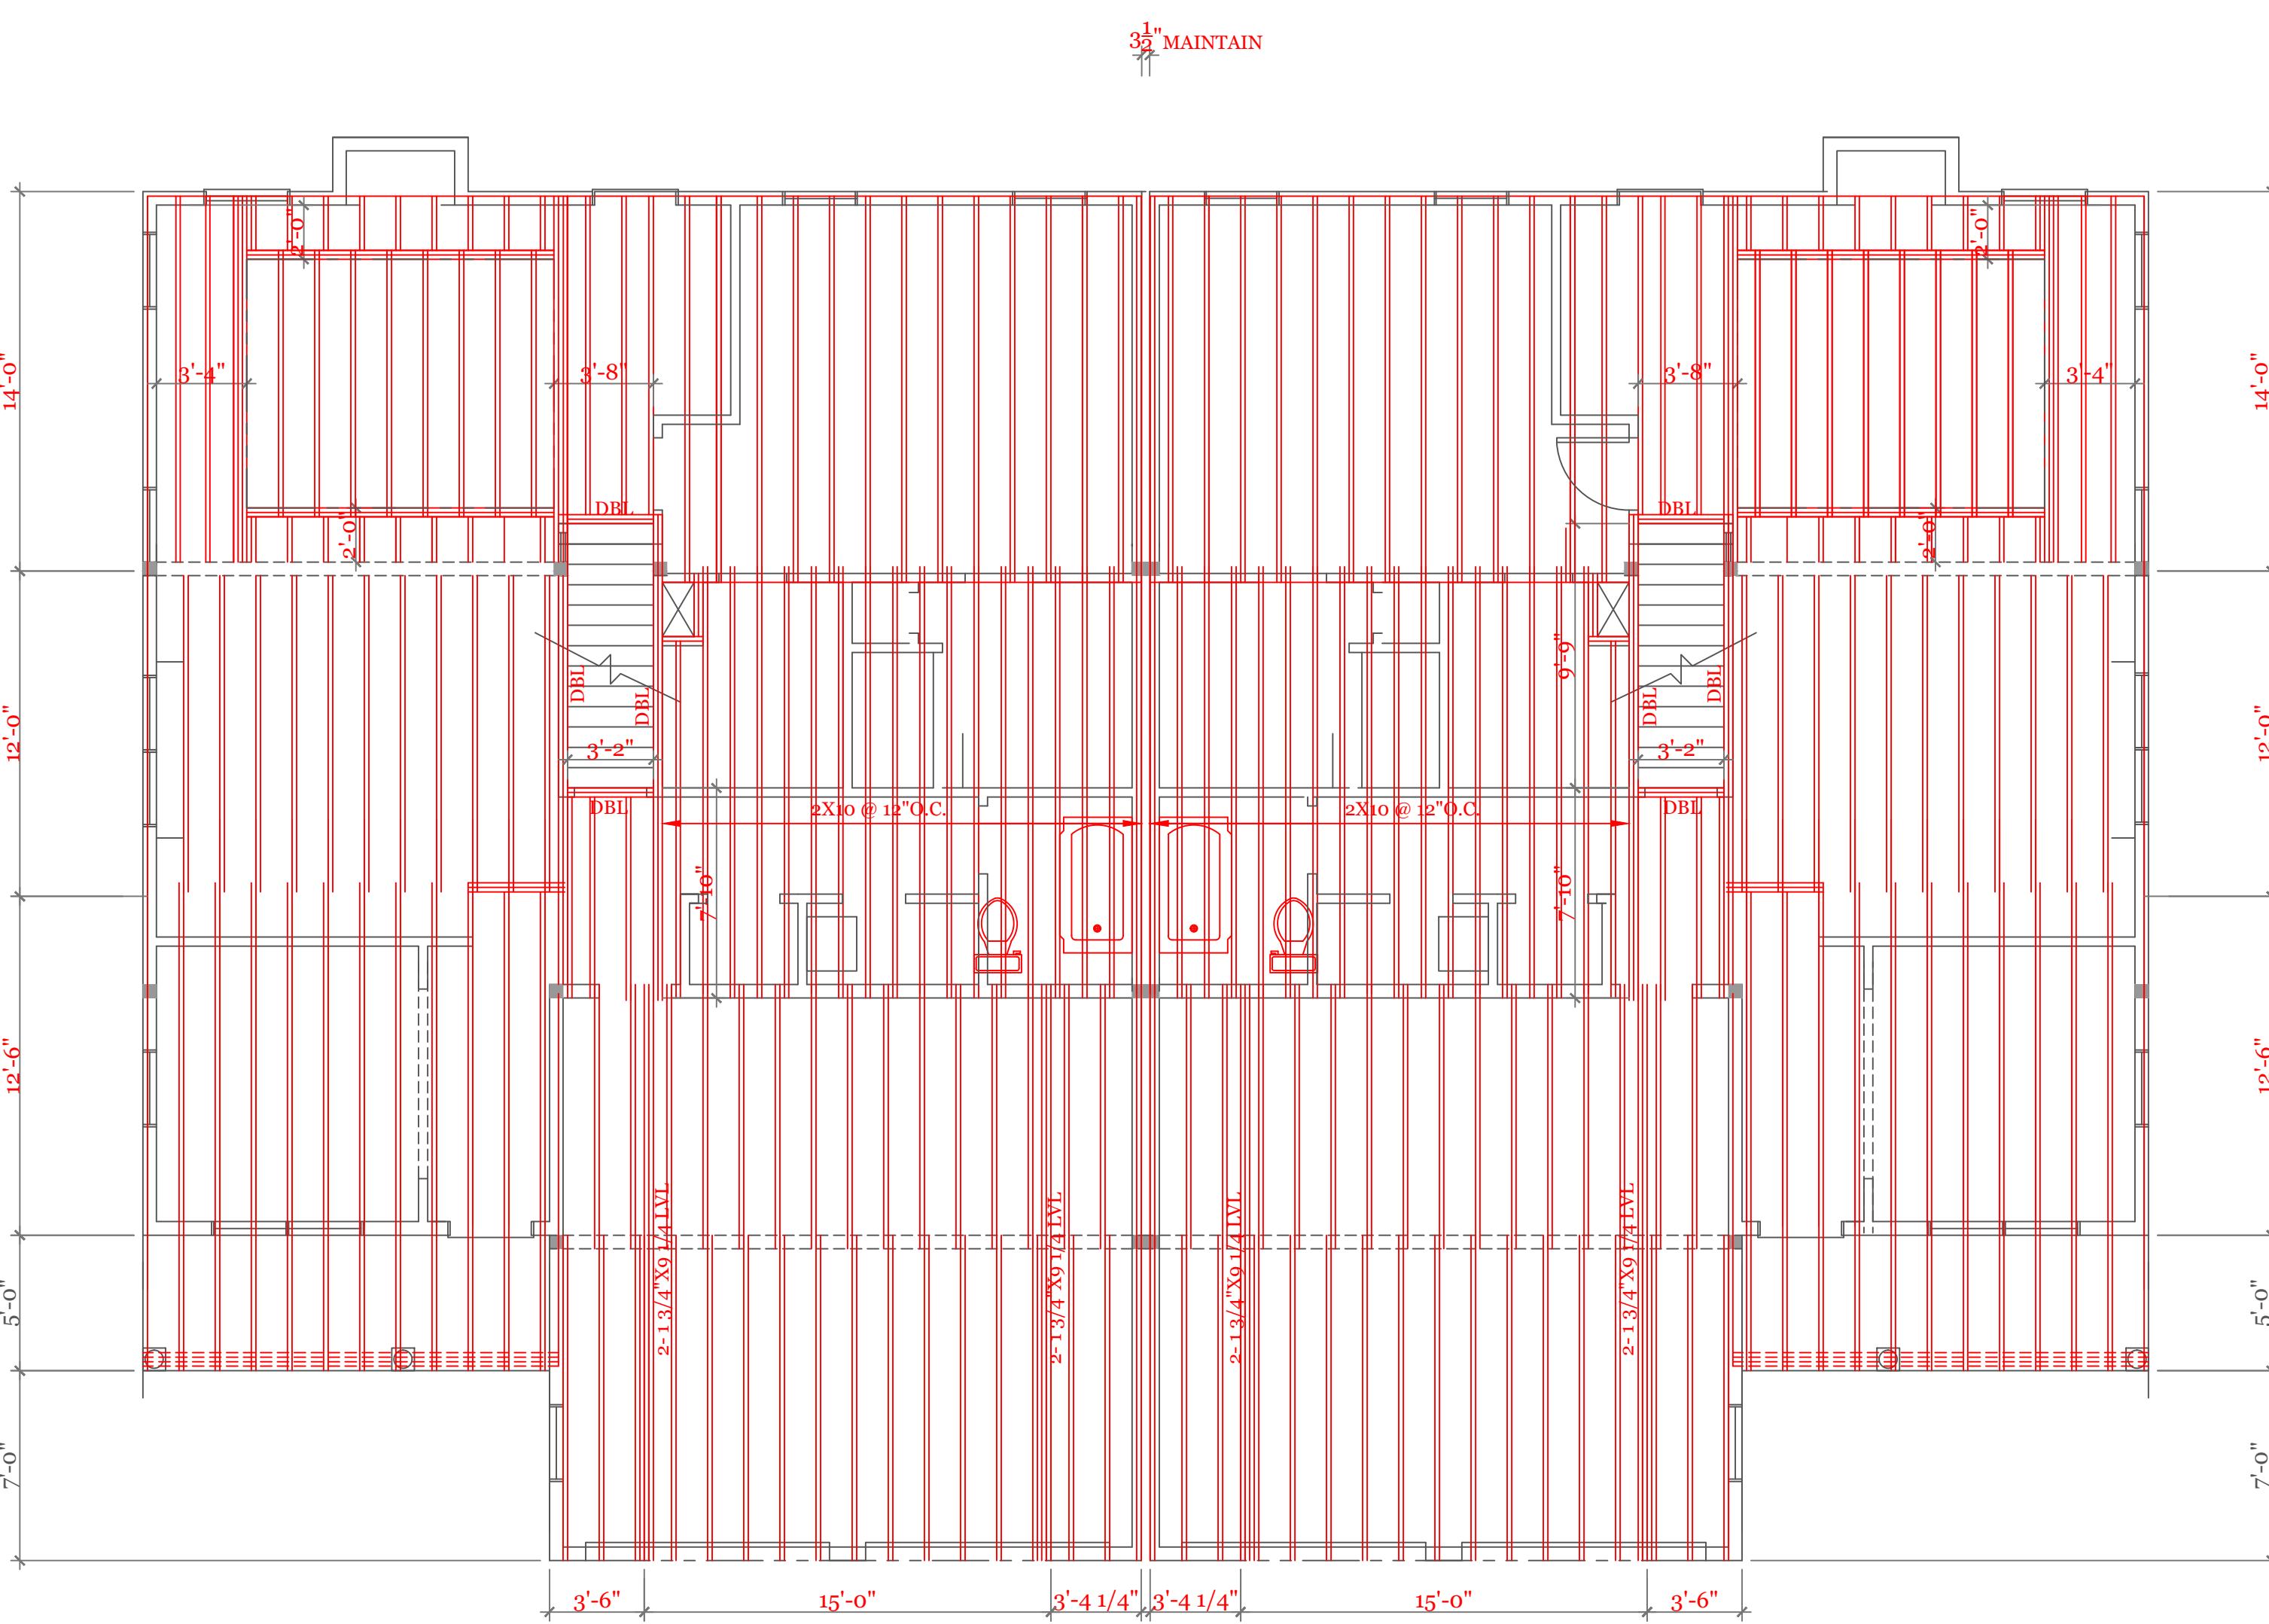

SECOND FLOOR FRAMING PLAN
2X10 @ 16'O.C. UNLESS NOTED
■ BEARING POINTS BLOCKED TO FOUNDATION OR BEAM SUPPORT.

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CONSULTING ENGINEER
MICHAEL J. BURKE P.E.
299 SALISBURY STR.
WORCESTER MA
(508)450-3461

UNIT 'B' DUPLEX
HIGGINS FARM AT
SALISBURY HILL

UNIT 'B' DPLX

DATE: 9/21/2022 R5/8


SCALE: 3/16" = 1'-0"

DRAWN BY: RCS


CHECKED BY: MJB

Sheet 7 OF 8

7

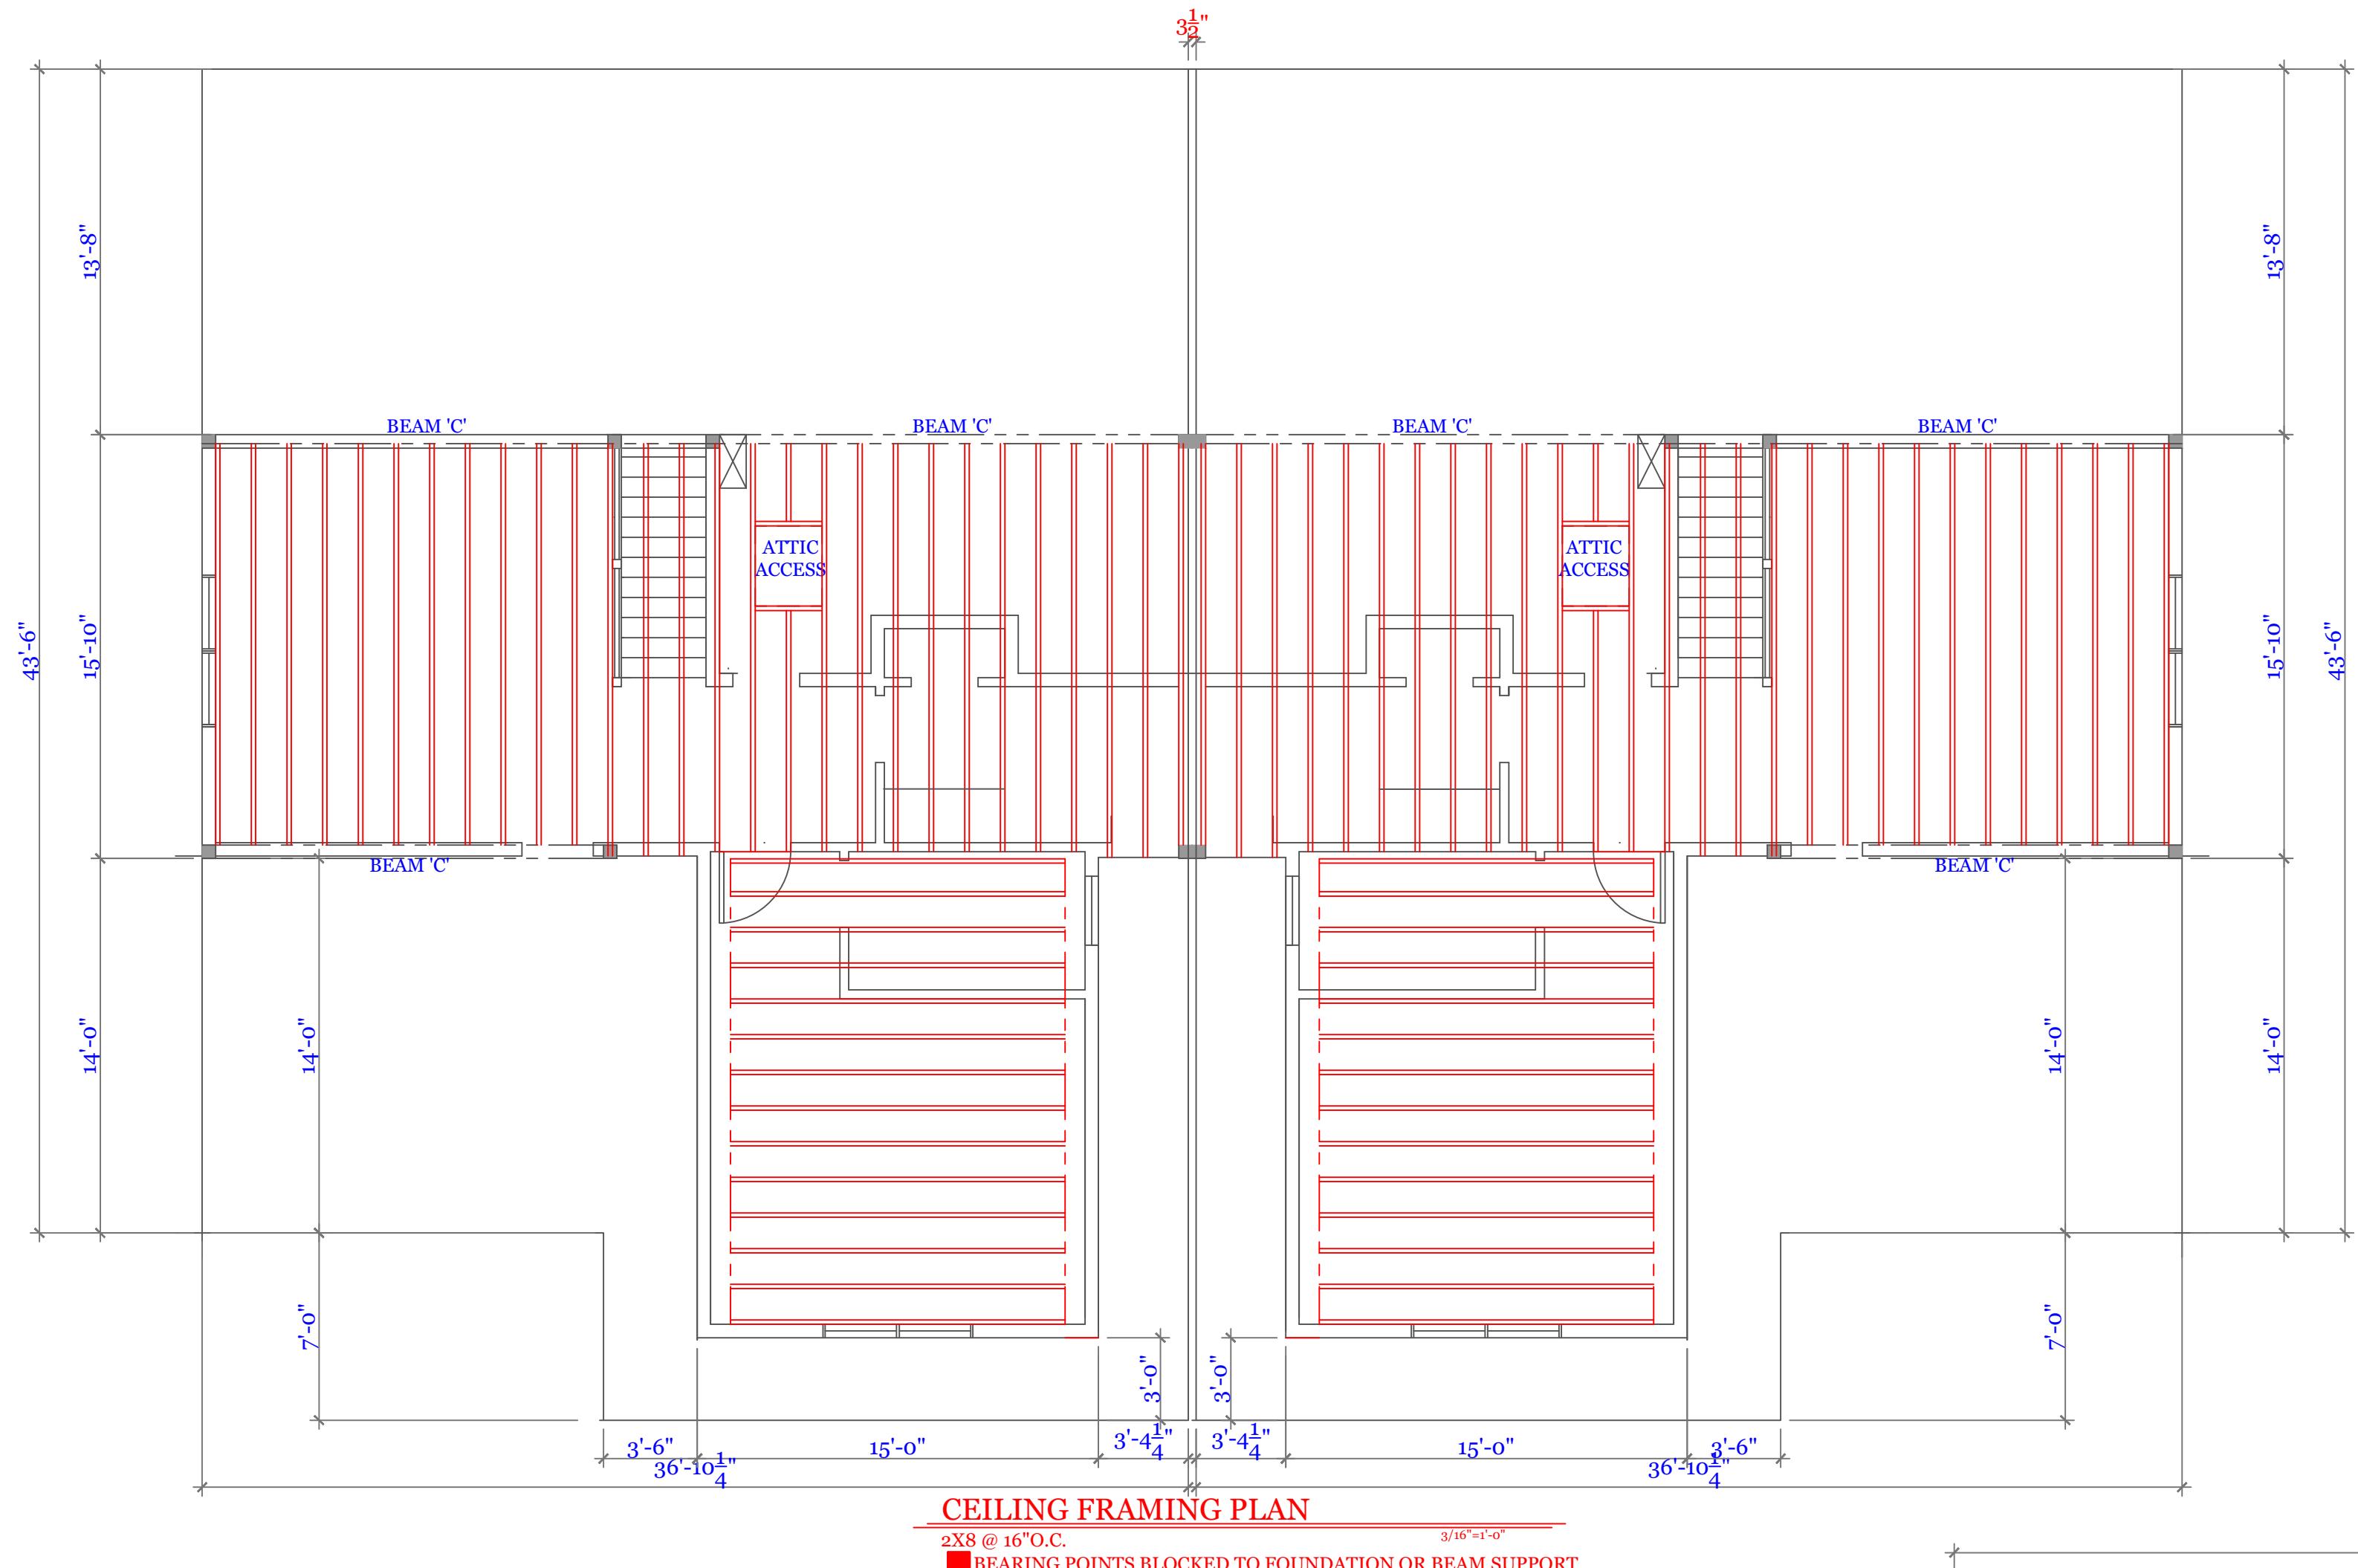

BEAM CALCULATIONS						
BEAM	SIZE	SPAN	LIVE LOAD	TOTAL LOAD	MAX LIVE (PLF)	MAX TOTAL (PLF)
A	5 1/4" X 16" LVL	22'-0"	315	440	710	1021
B	3 1/2" X 11 7/8" LVL	15'-0"	390	520	442	647
C	5 1/4" X 14" LVL ROOF	18'-0"	160	790	610	806

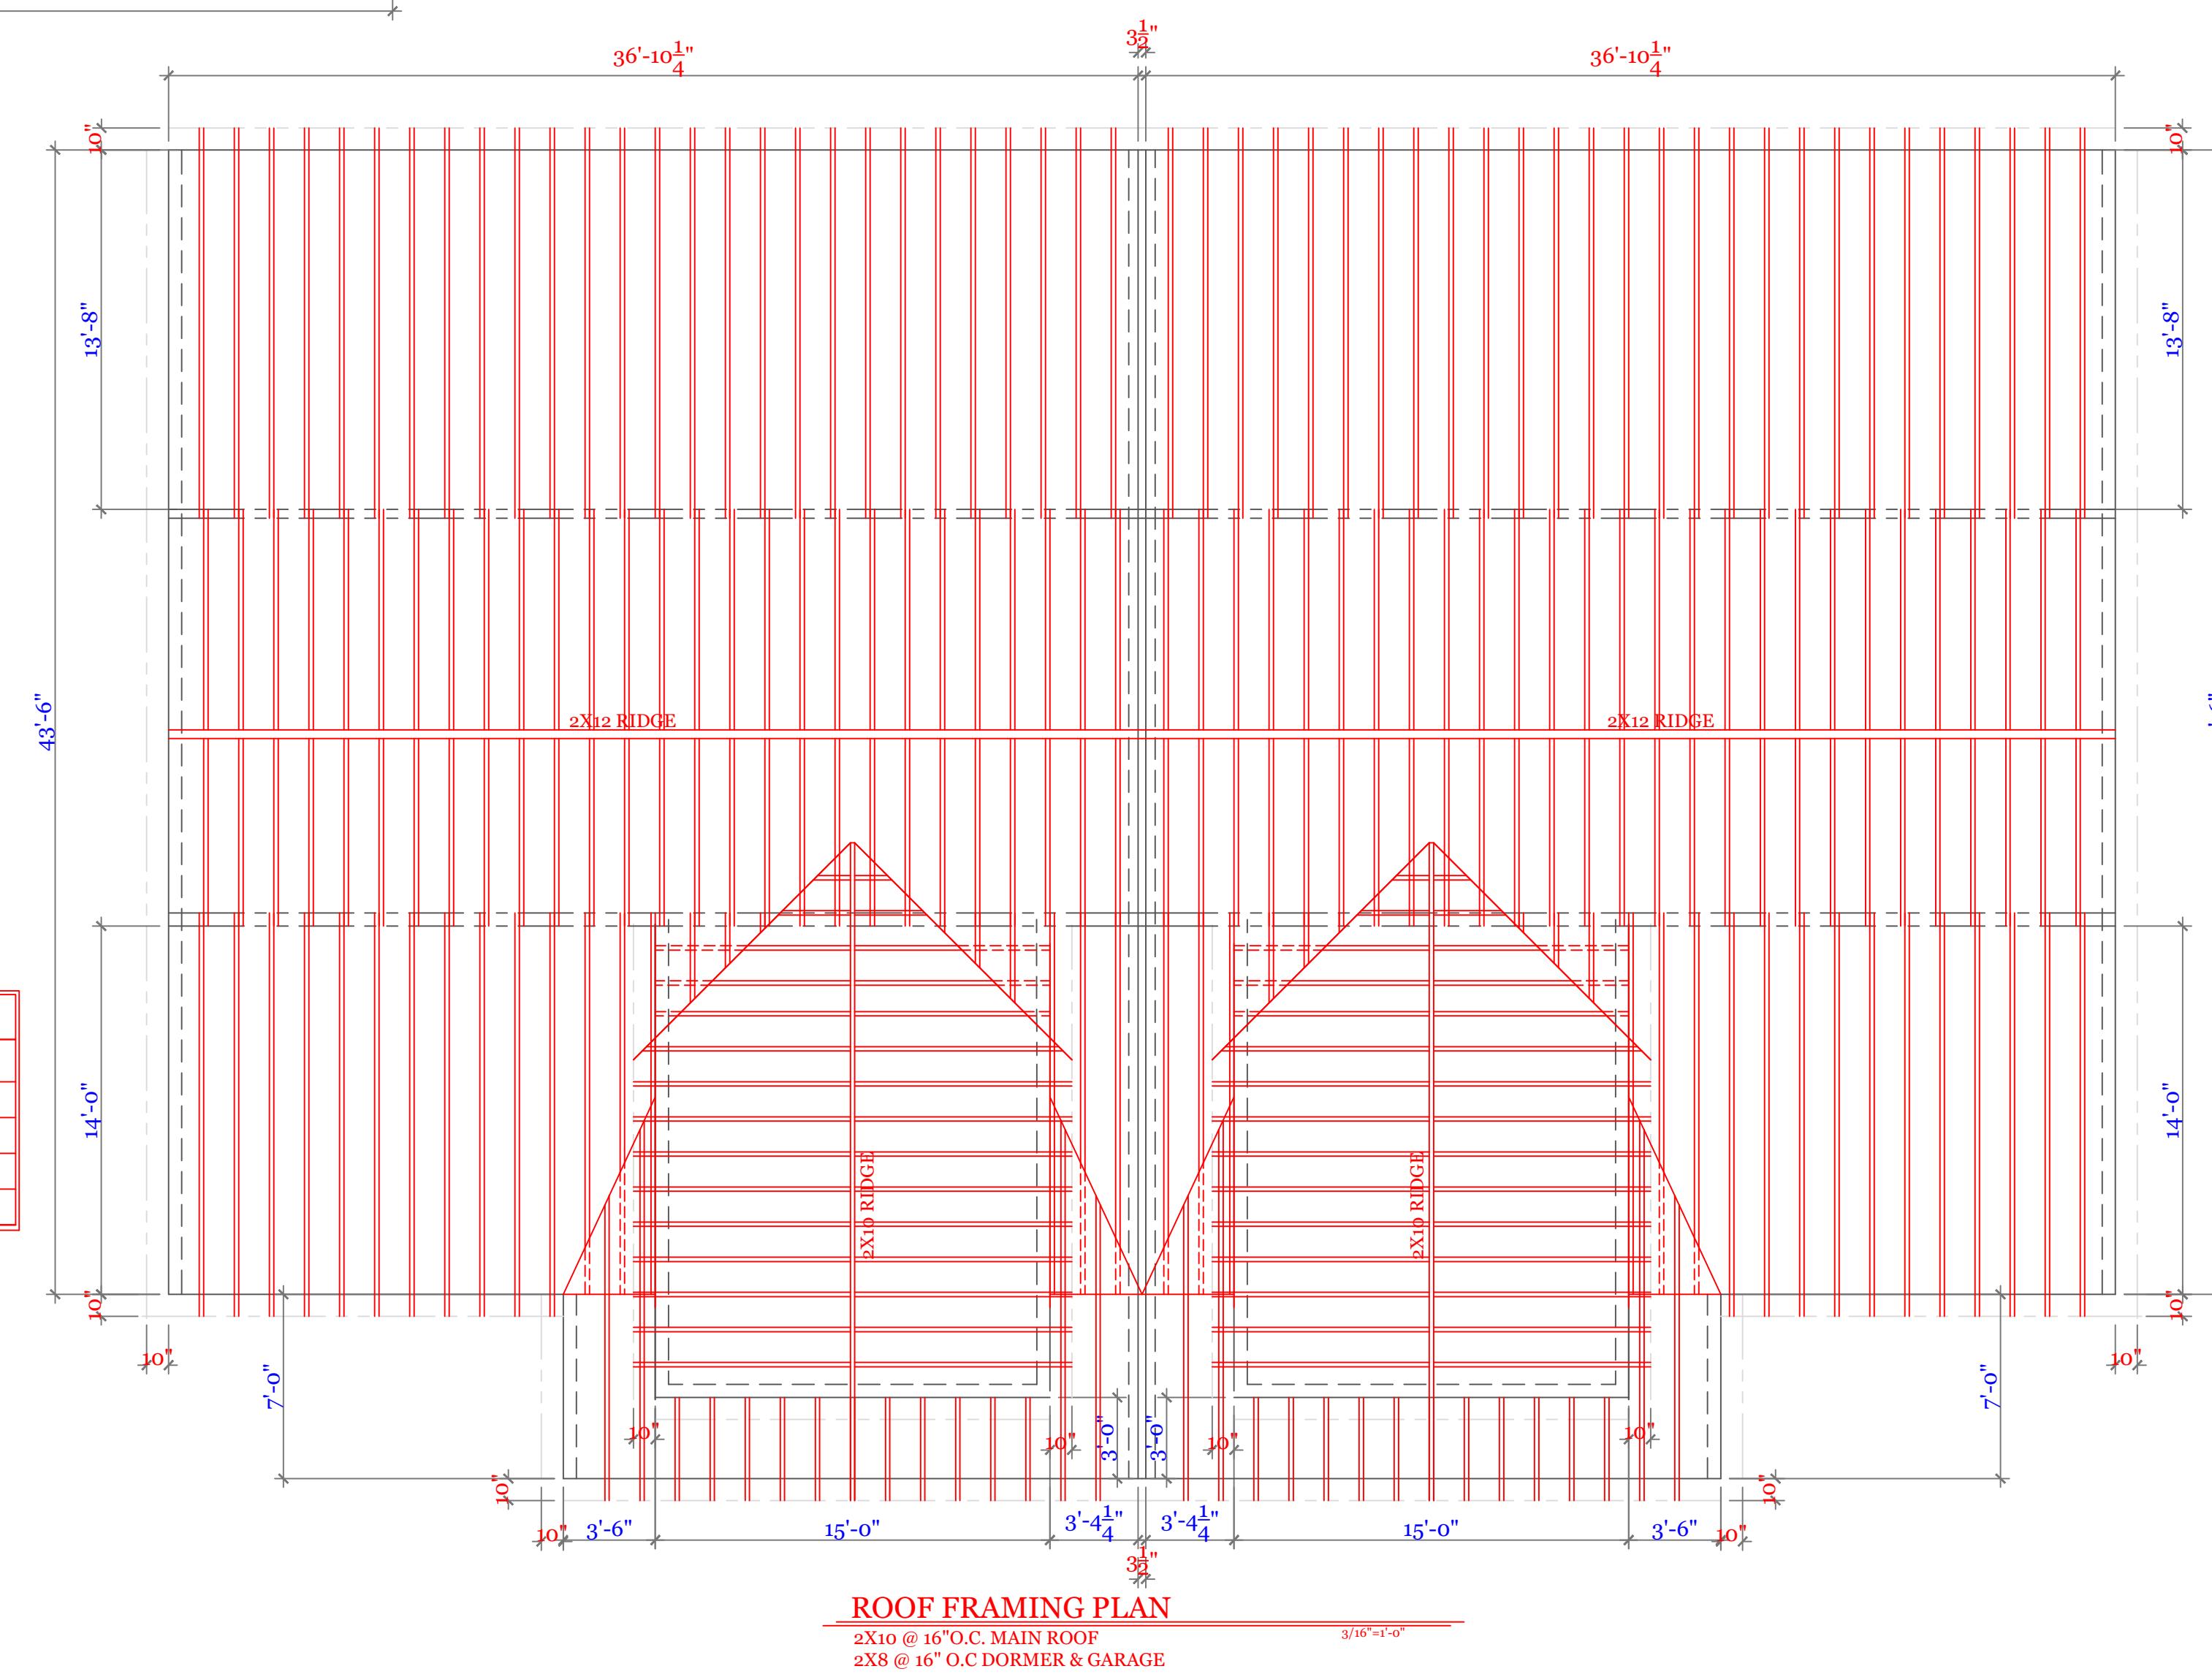

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UNIT 'B' DUPLEX
HIGGINS FARM AT
SALISBURY GREEN

CEILING & ROOF
FRAMING PLANS
BEAM SCHEDULE

UNIT 'B' DPLX

DATE: 9/21/2022 R5/5
SCALE: 3/16"=1'-0"
DRAWN BY: RCS
CHECKED BY: MJB


Sheet 8 OF 8

8


NOTES:

GENERAL NOTES:


1. These plans are drawn as required for construction by an experienced licensed general contractor.
2. The General contractor shall fully comply with the 9TH Edition of the Massachusetts State Building Code, IRC2015 and all additional local requirements.
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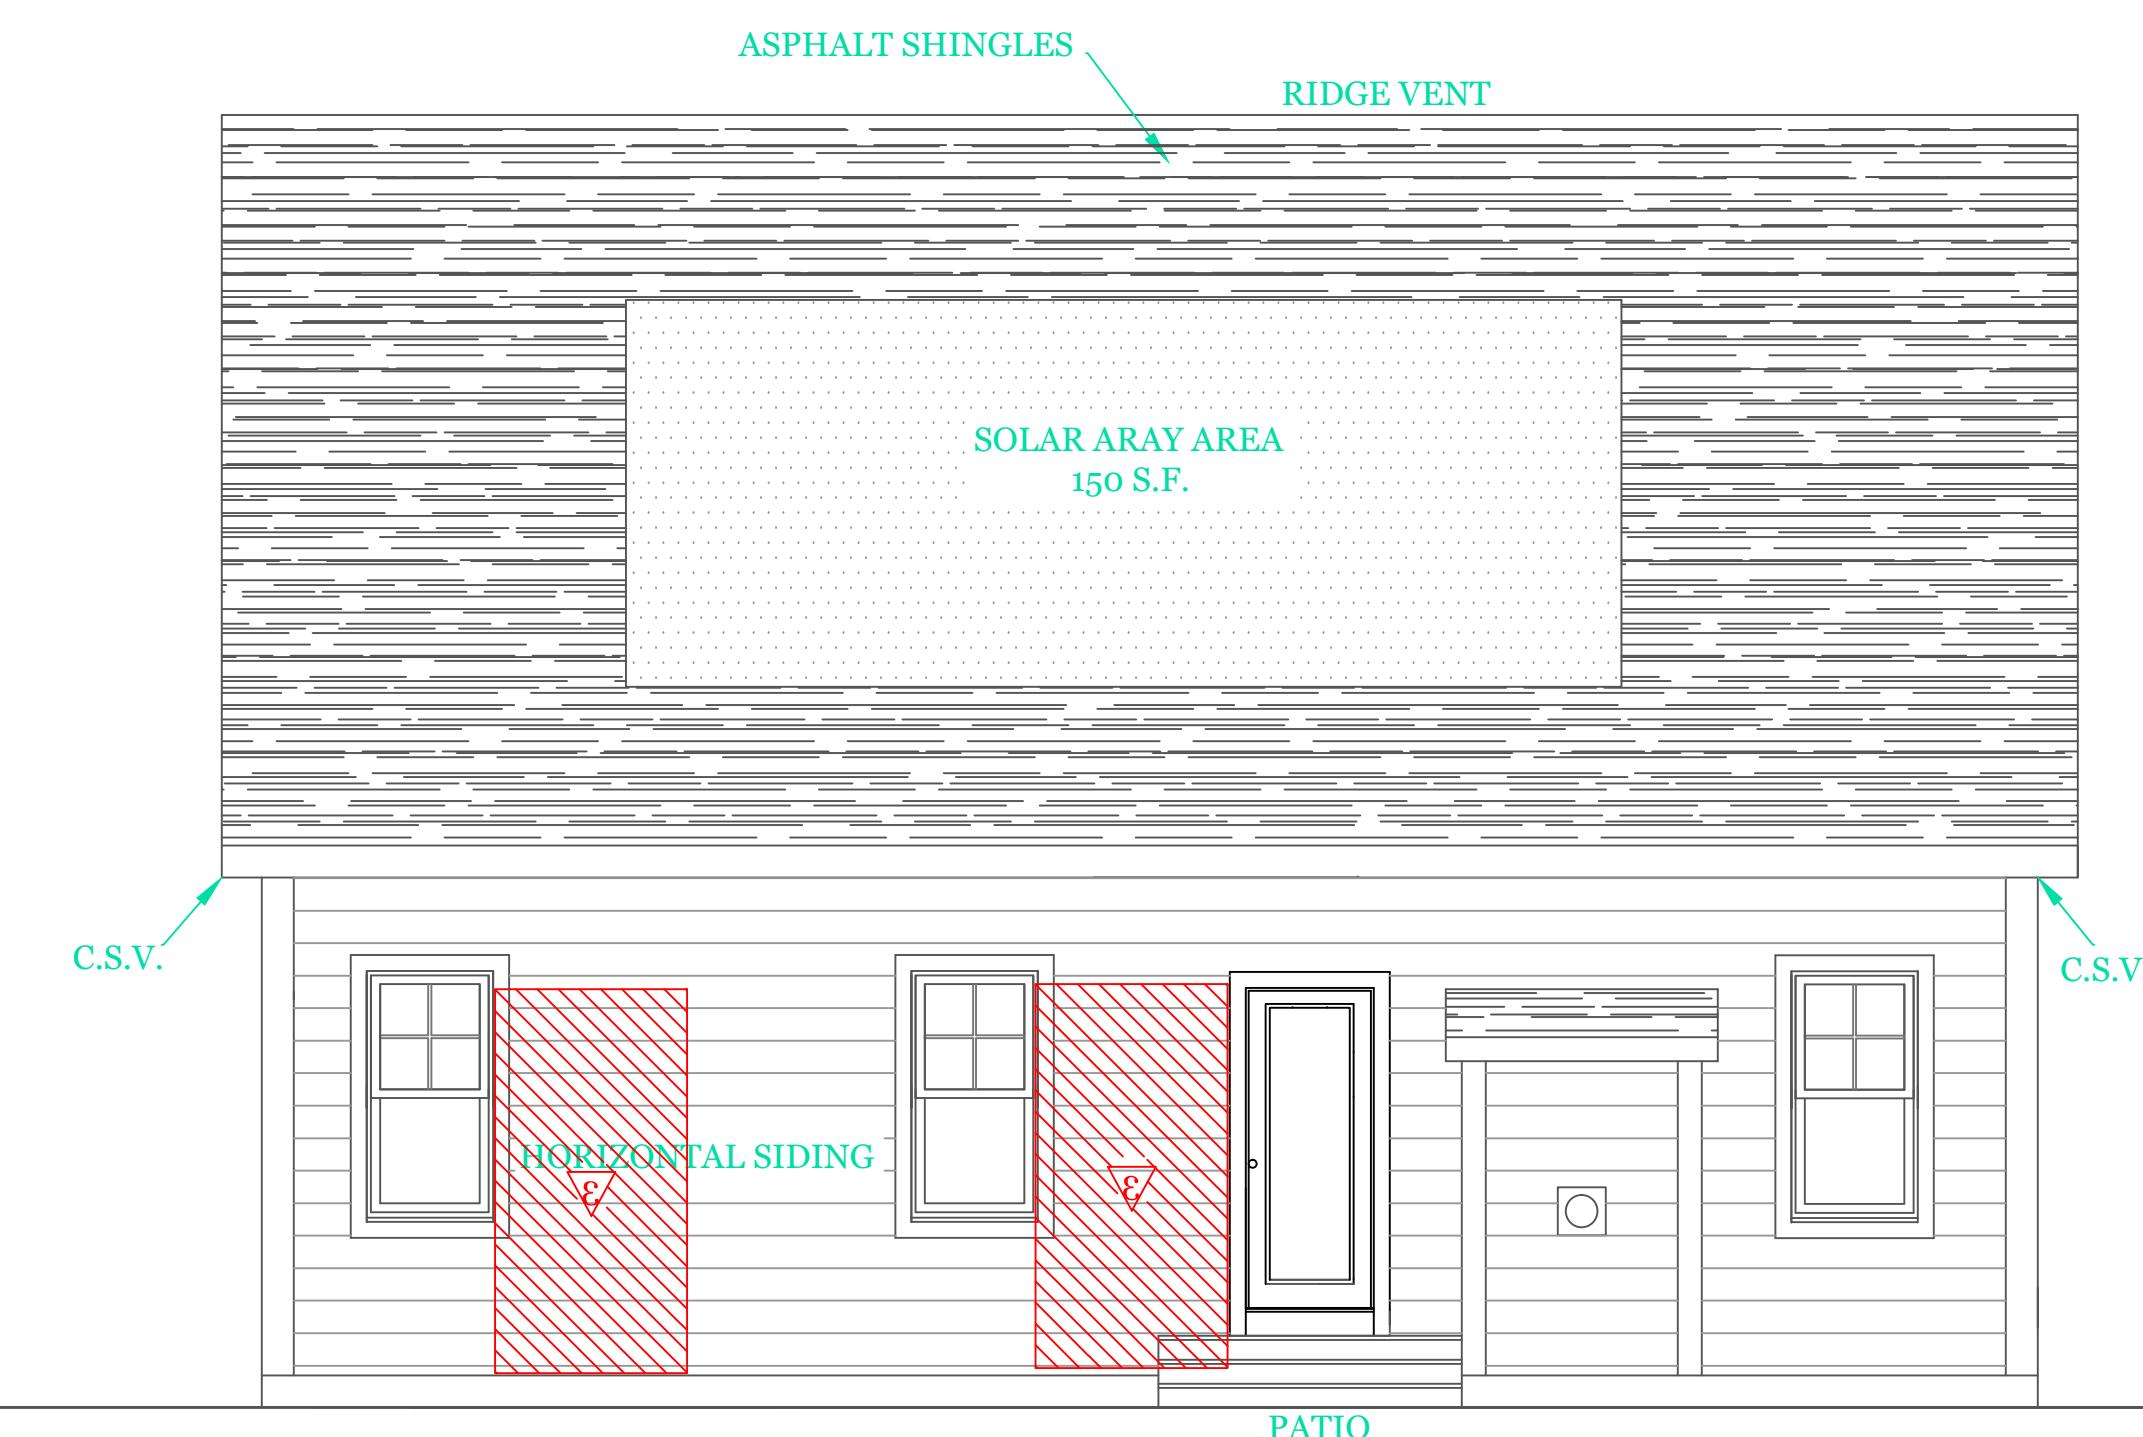
WOOD STRUCTURAL PANEL 15/32 CDX PLY WD. SHEATHING ON 16"
STUD SPACING PANELS INSTALLED VERTICALLY
W/ 6d COMMON NAIL 6" O.C. @ EDGES & 12" O.C. INTERMEDIATE
SUPPORTS

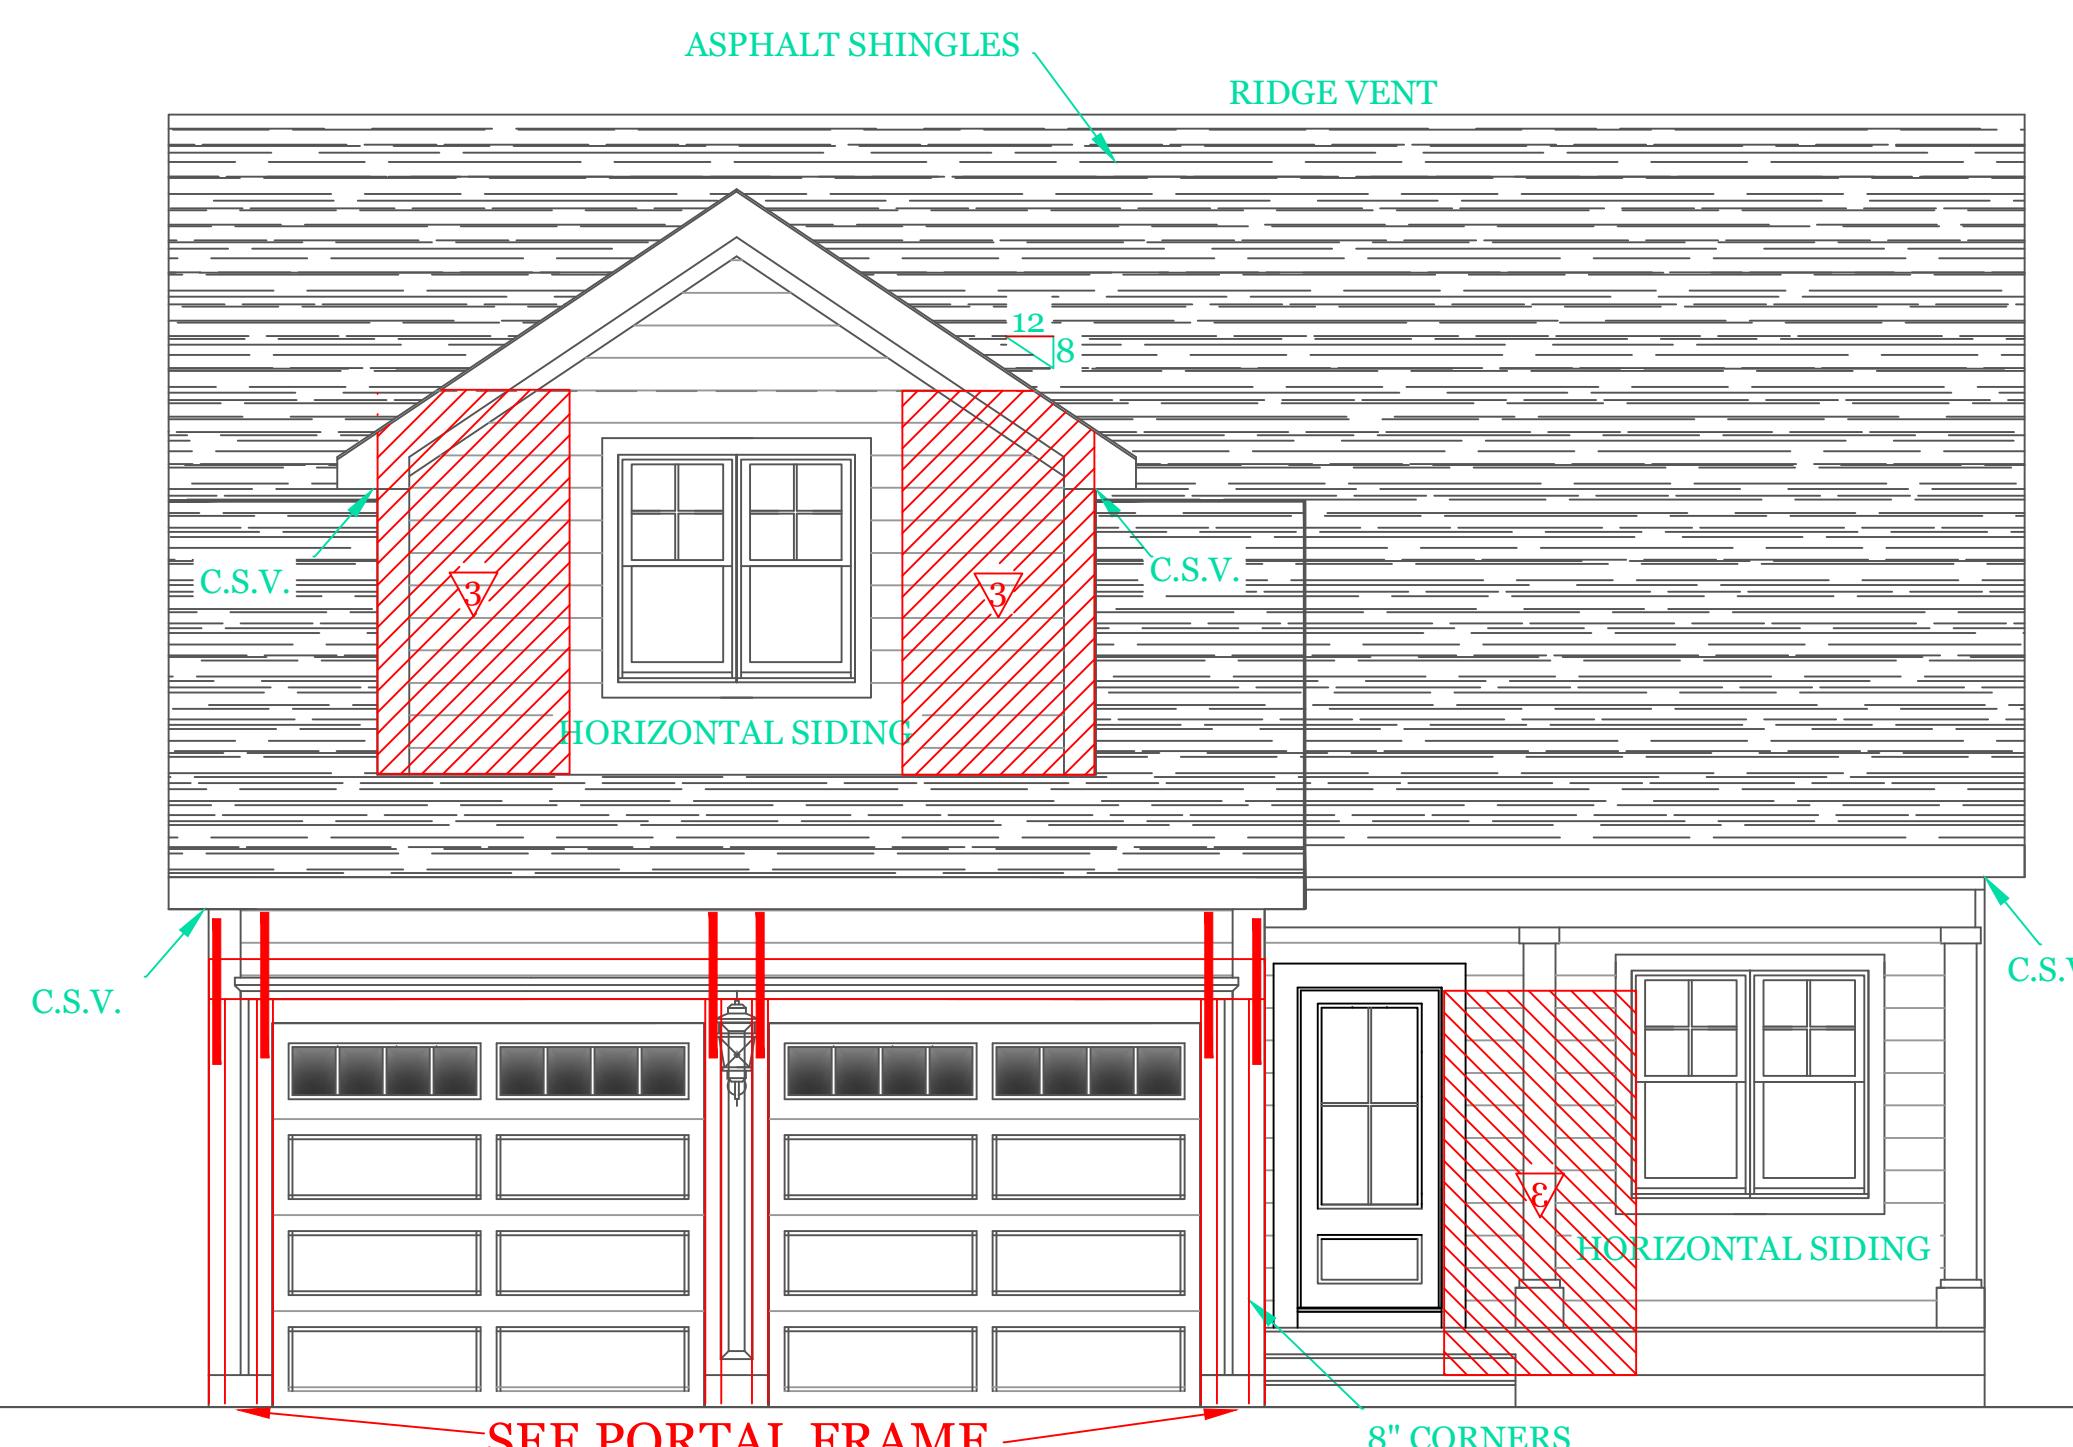

RIGHT SIDE ELEVATION

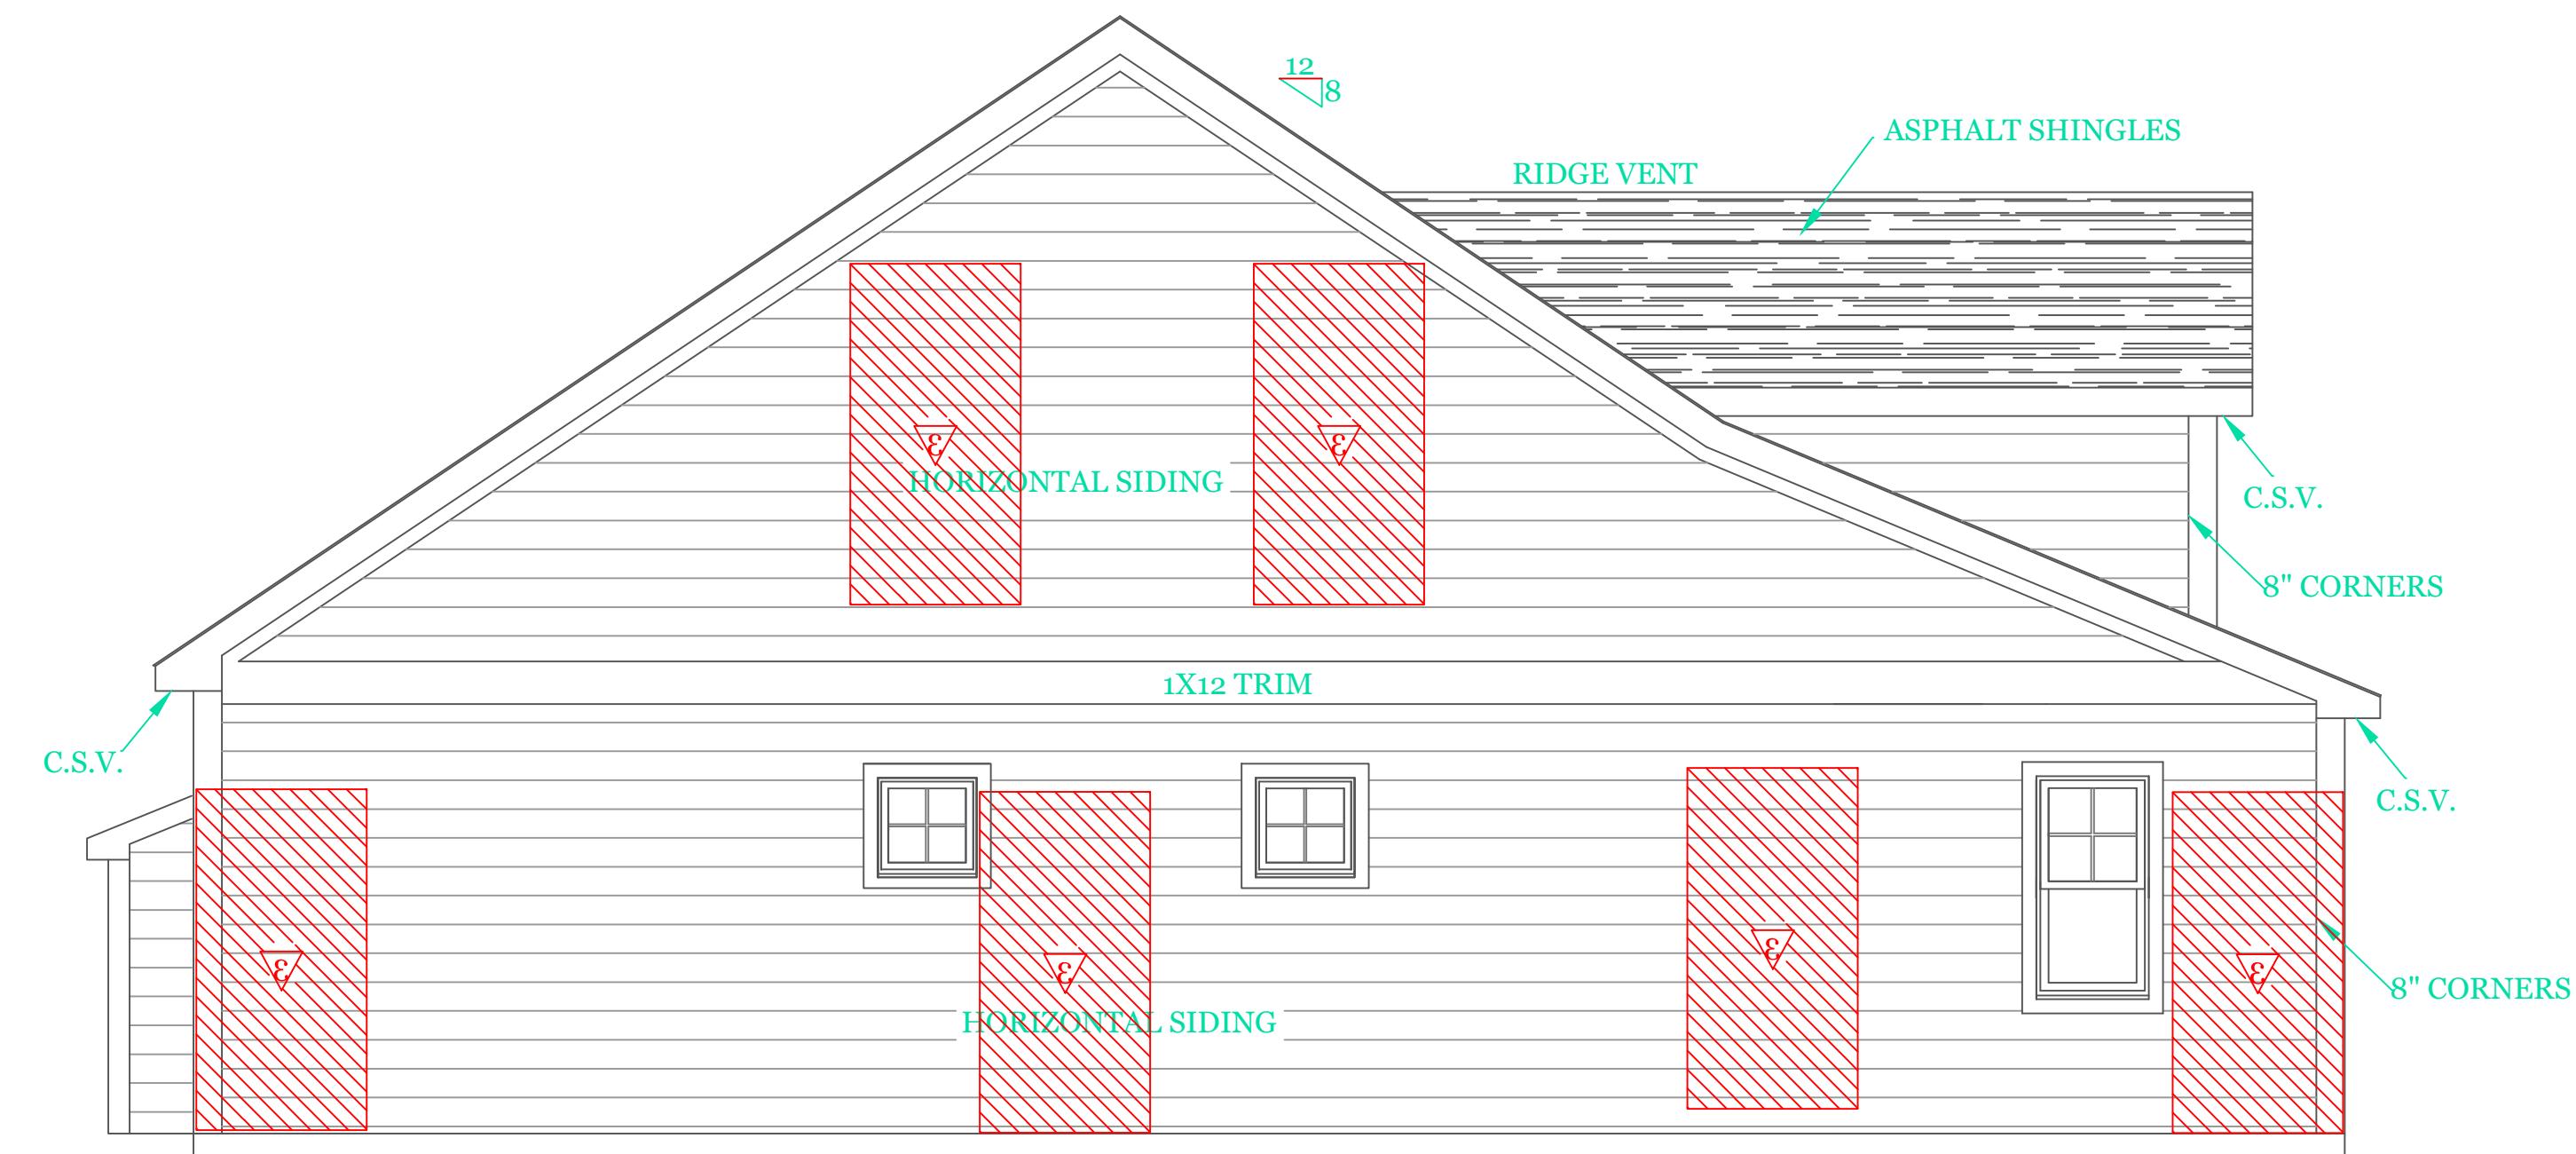

LEFT SIDE ELEVATION

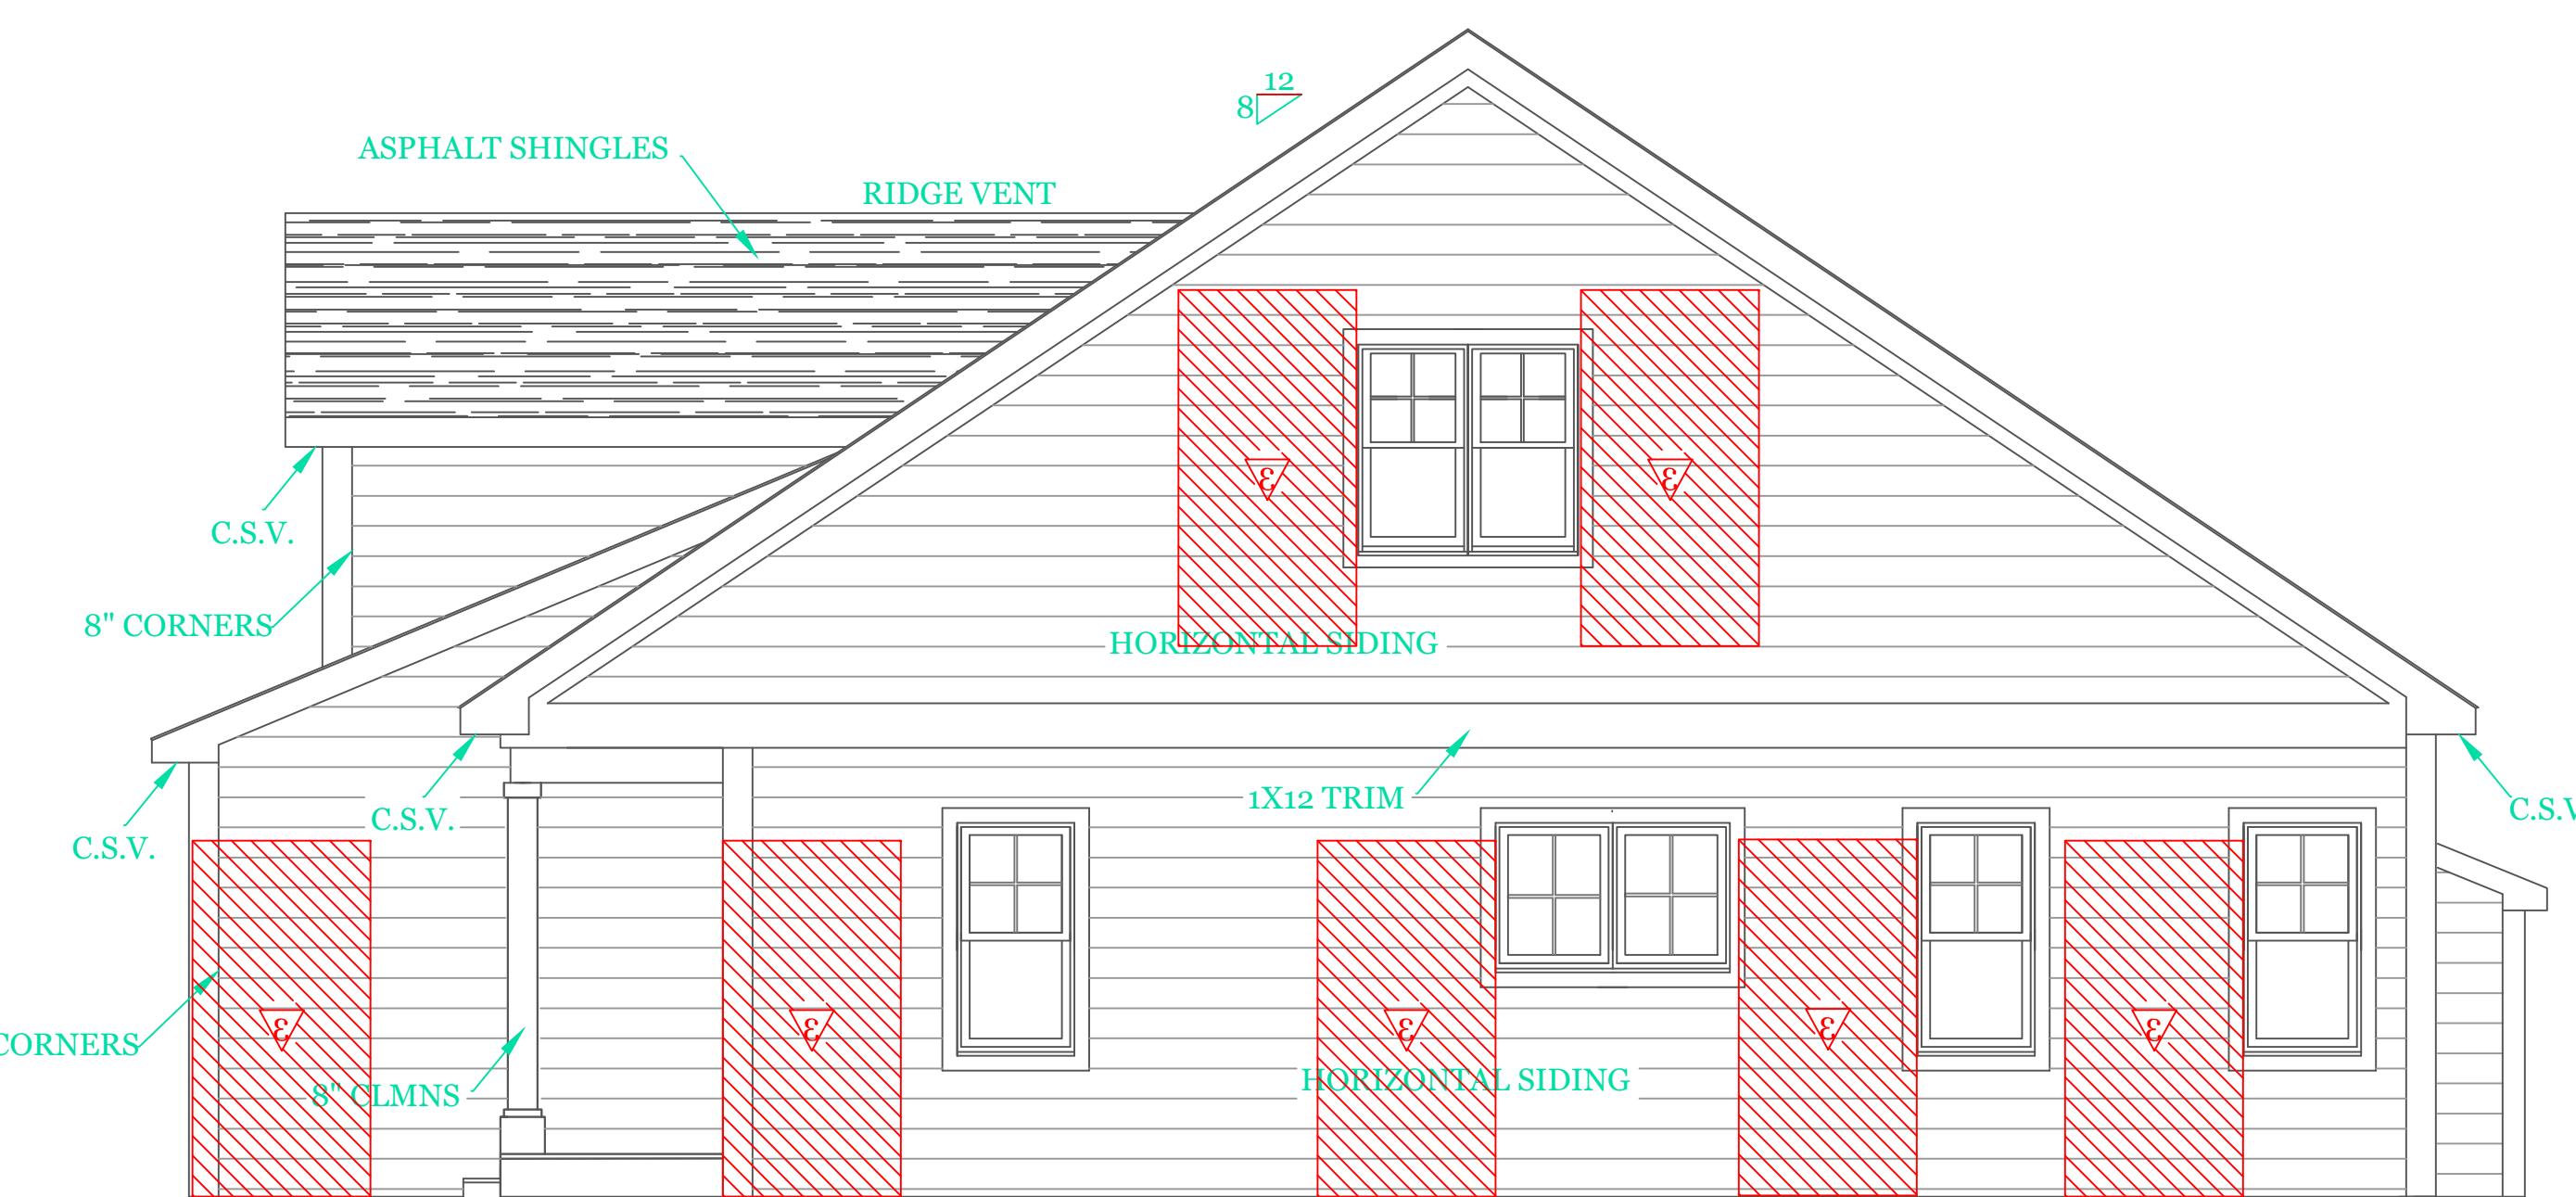

REAR ELEVATION

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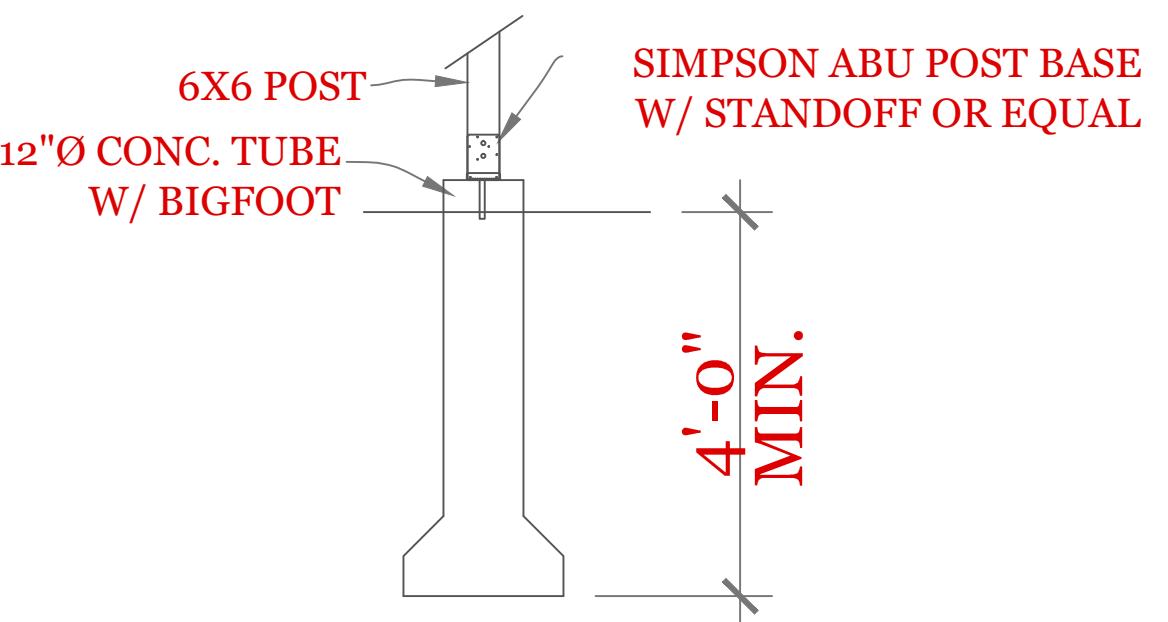
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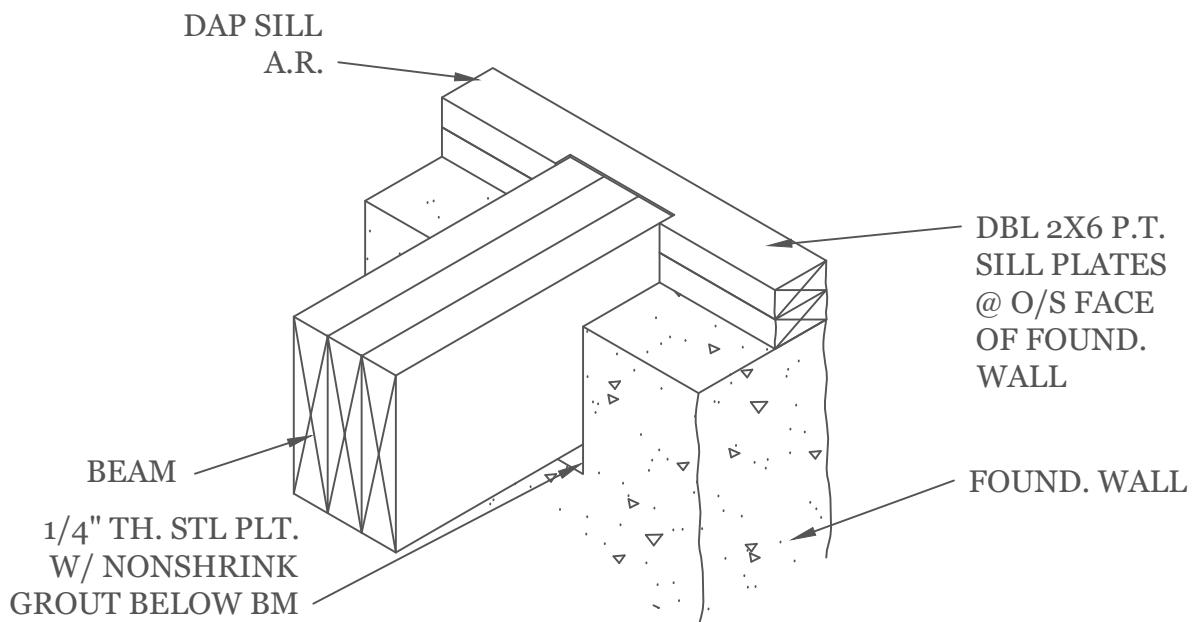
UNIT 'B' 1936 S.F.	HIGGINS FARM AT SALISBURY HILL
UNIT 'B' GL	ELEVATIONS
DATE: 9/21/2022 R5/5	
SCALE: 1/4"=1'-0"	
DRAWN BY: RCS	
CHECKED BY: MJB	

Sheet 1 OF 5
1


TYPICAL FOUNDATION DETAILS



CONCRETE TUBE DETAIL




BEAM POCKET DETAIL

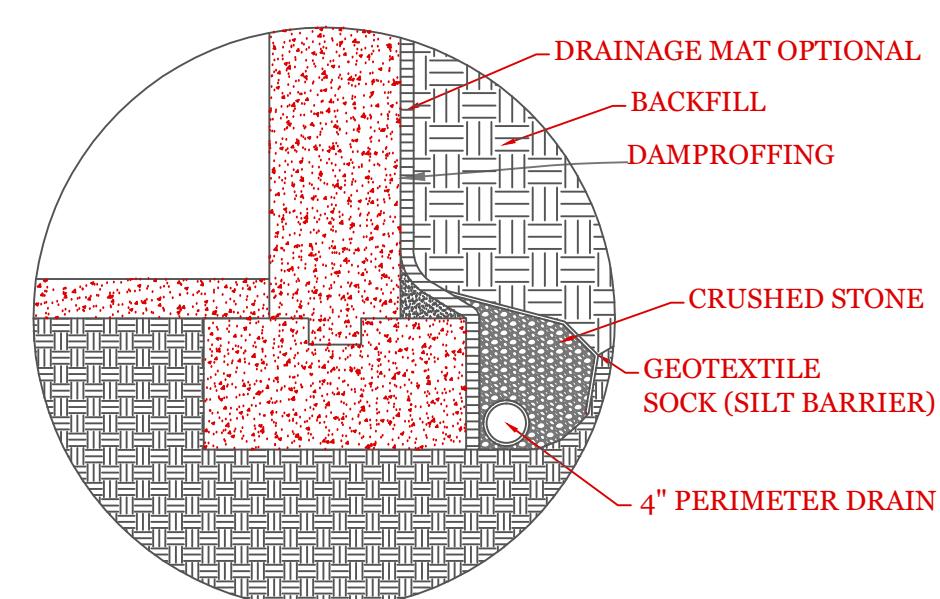

TYP. PERIMETER DRAIN DETAIL

NOTE: SLOPE DRAIN TO SUMP OR OUTFALL




NTS

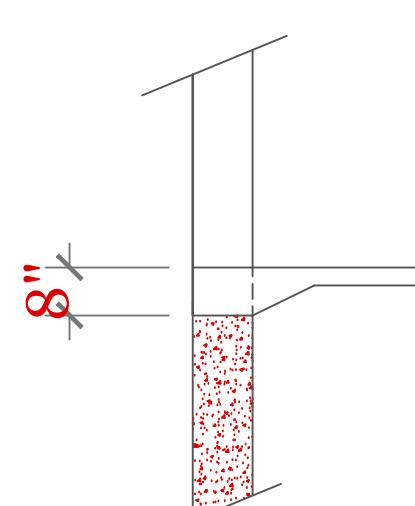

GARAGE FLOOR @ O.H.D.

SYMBOL SCHEDULE;

- [V] VENT
- [SC] SMOKE AND CARBON DETECTOR
- (S) SMOKE DETECTOR
- [H] HEAT DETECTOR
- BEARING POINT W/ SQUASH BLOCK

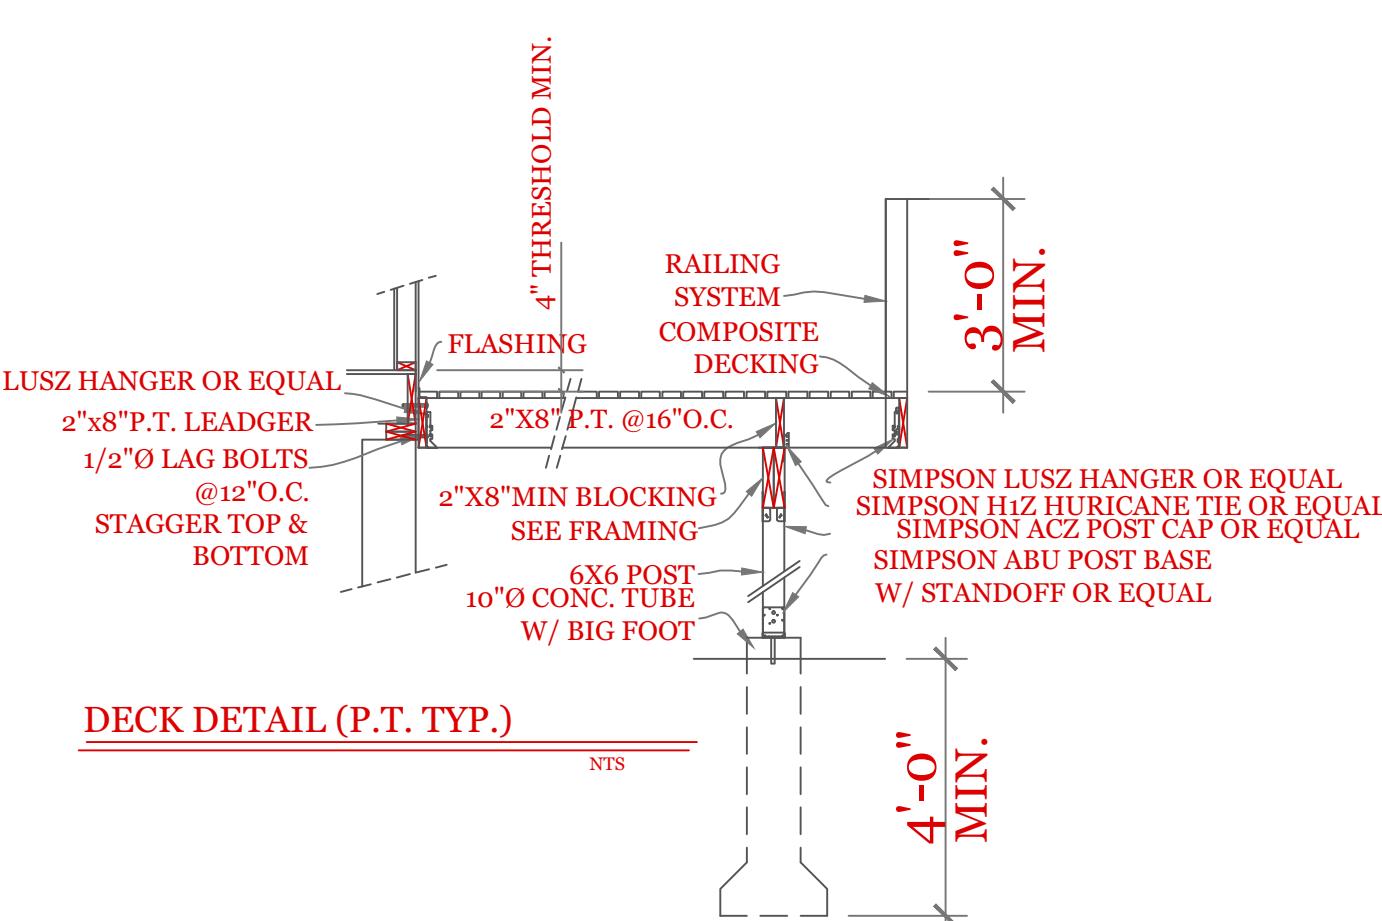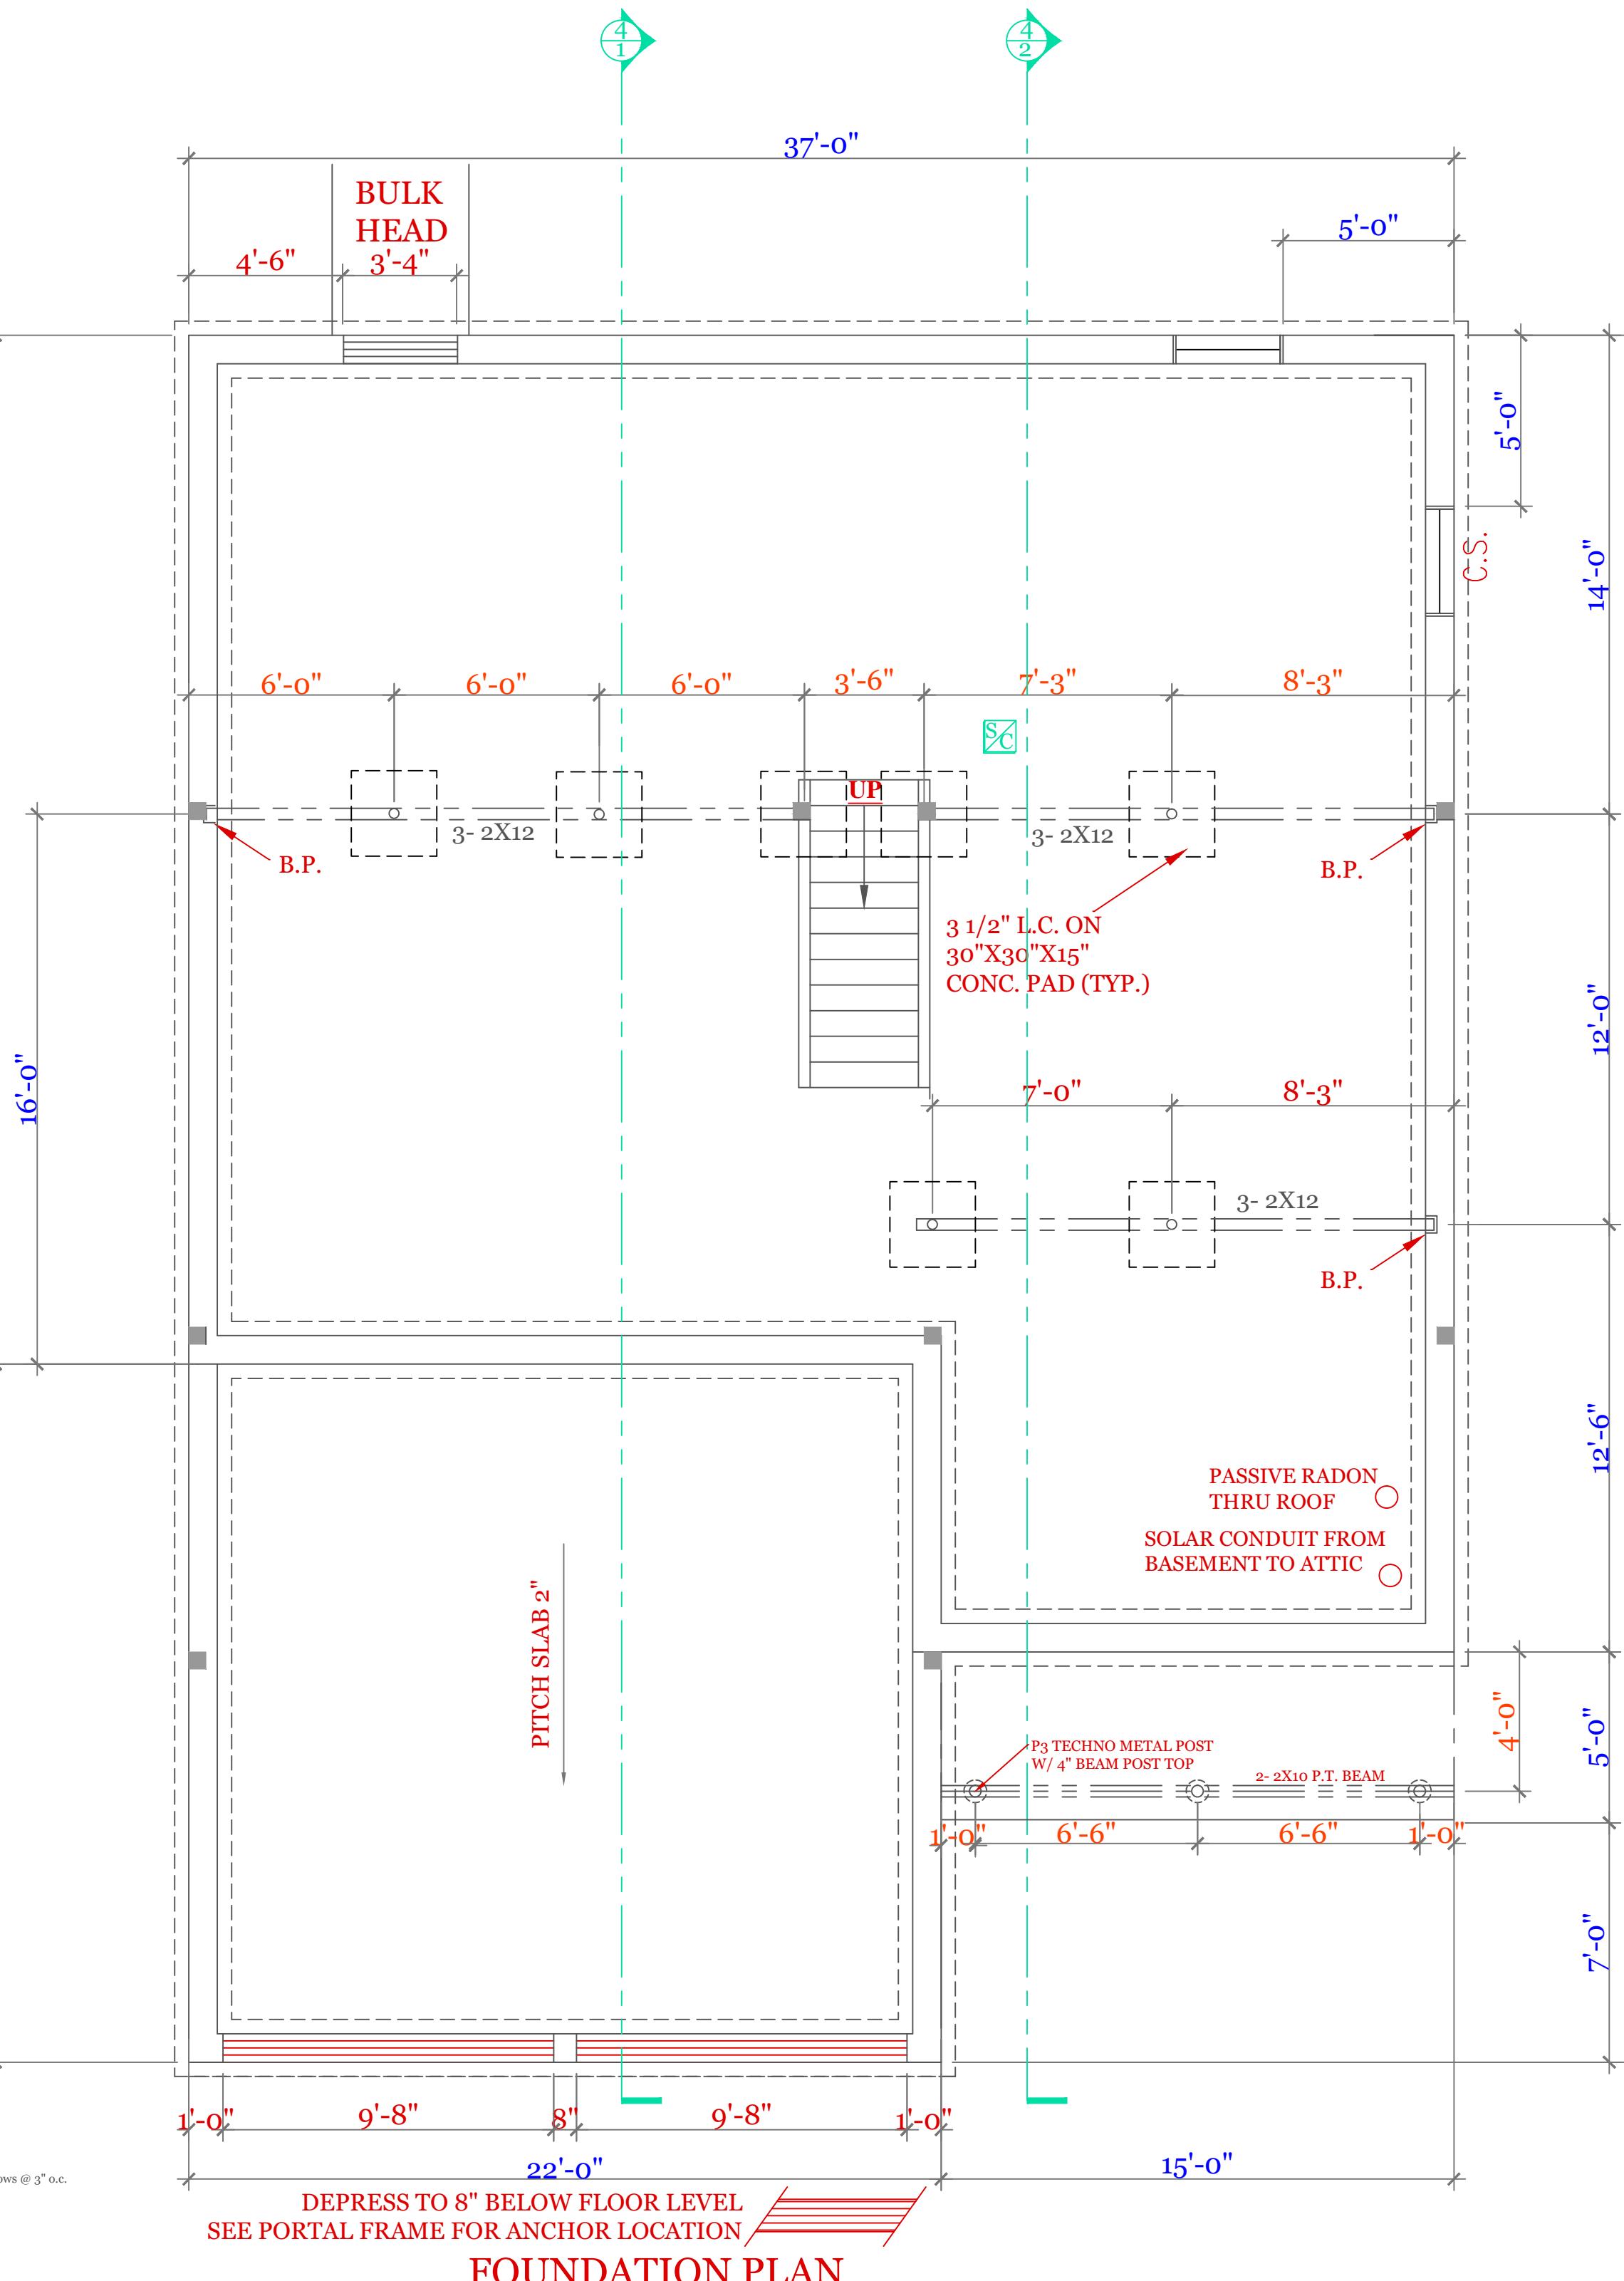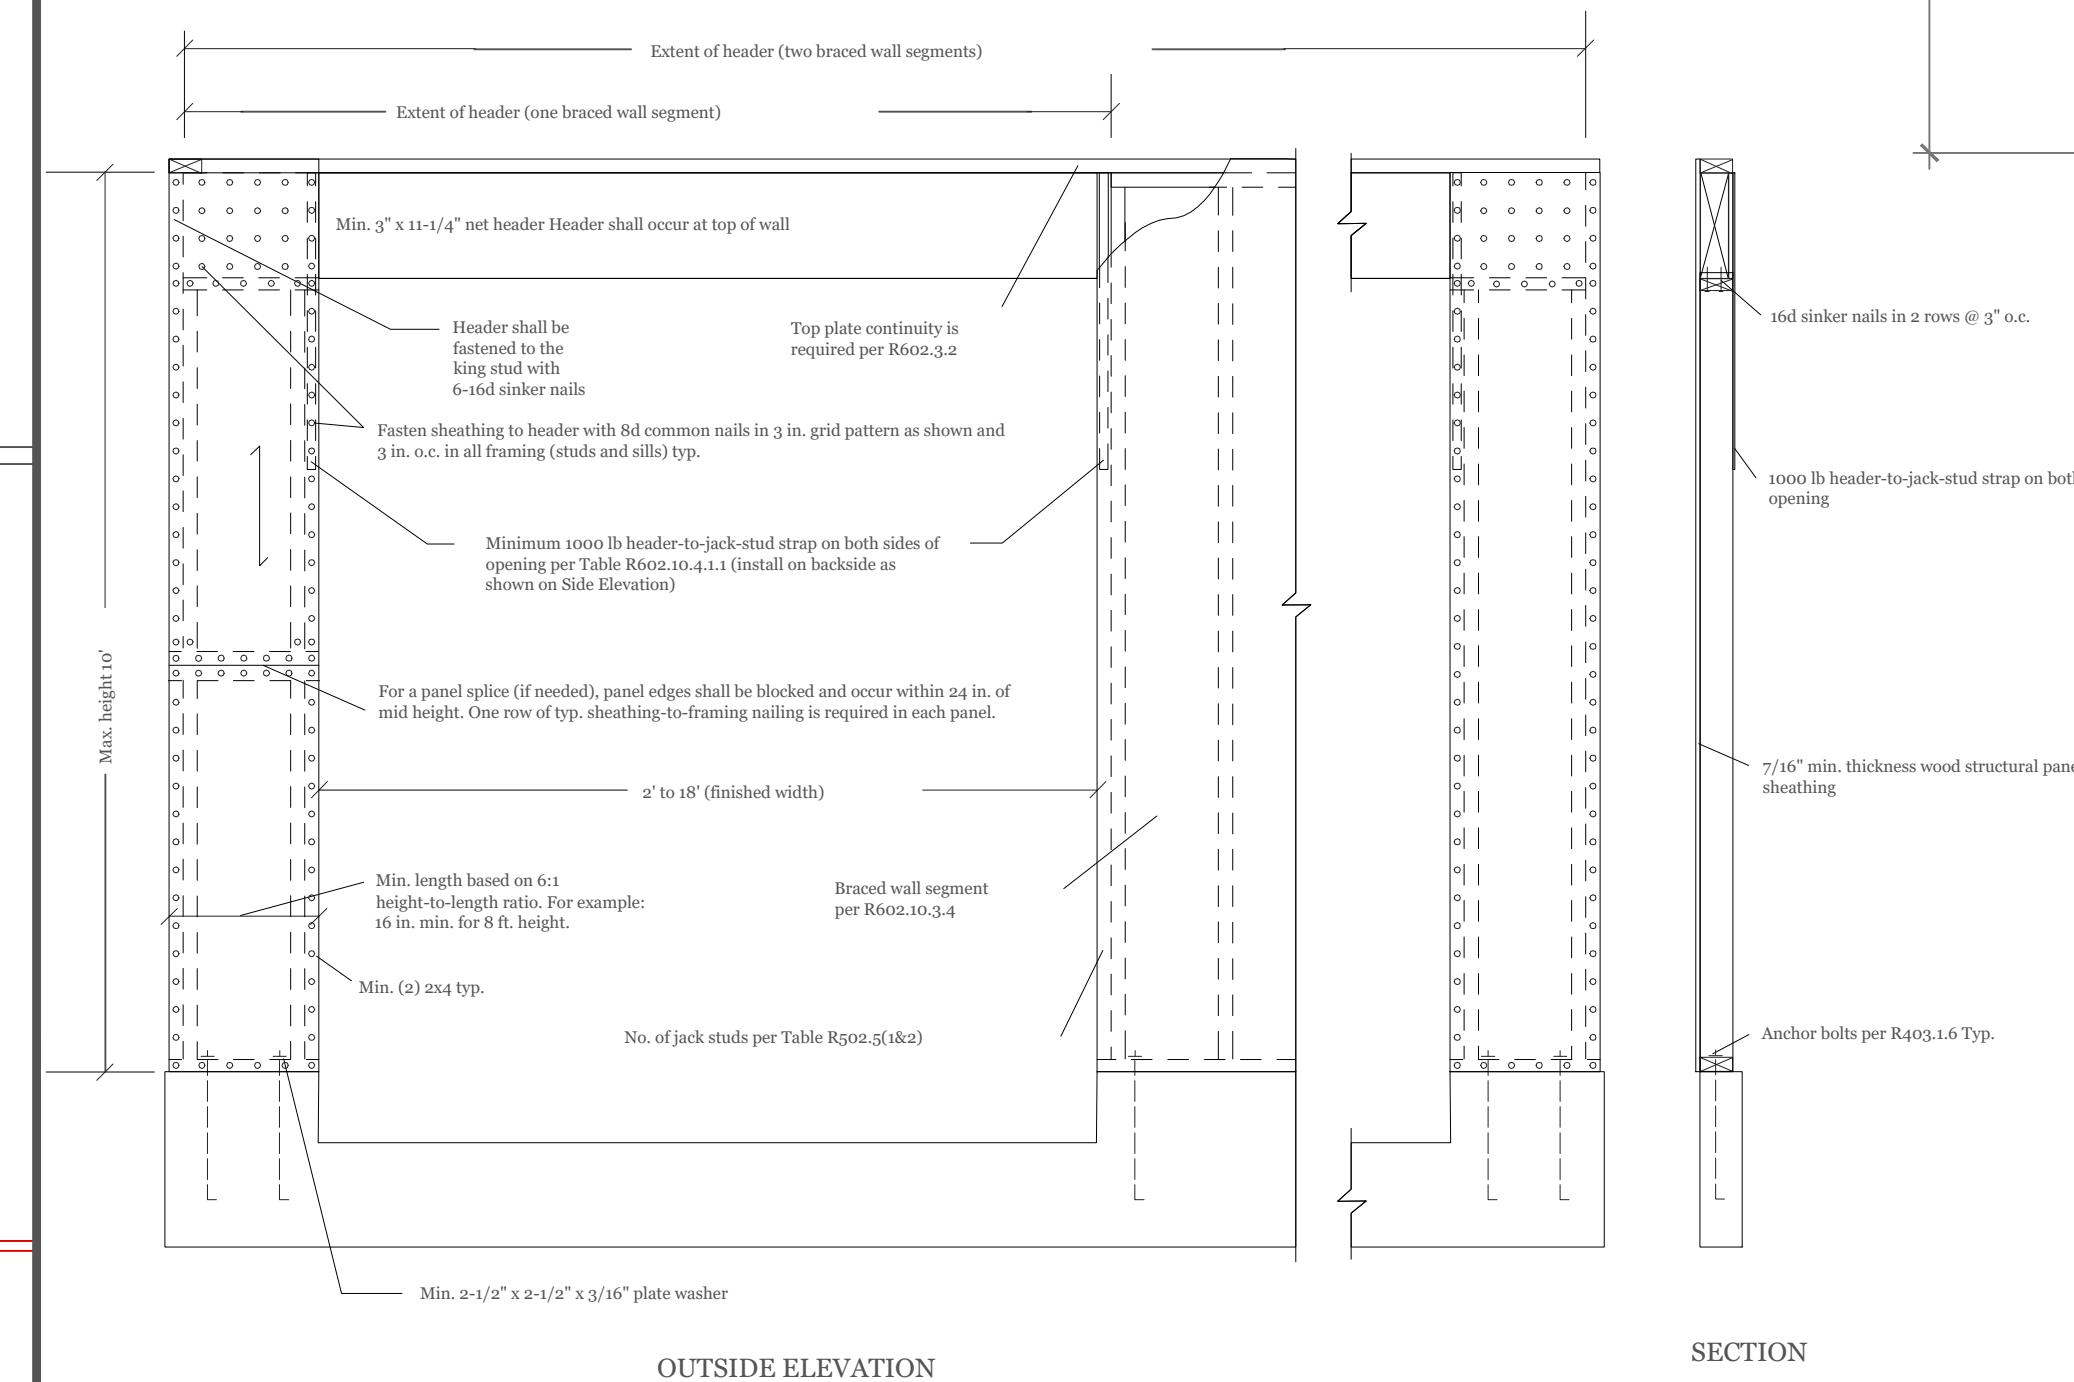

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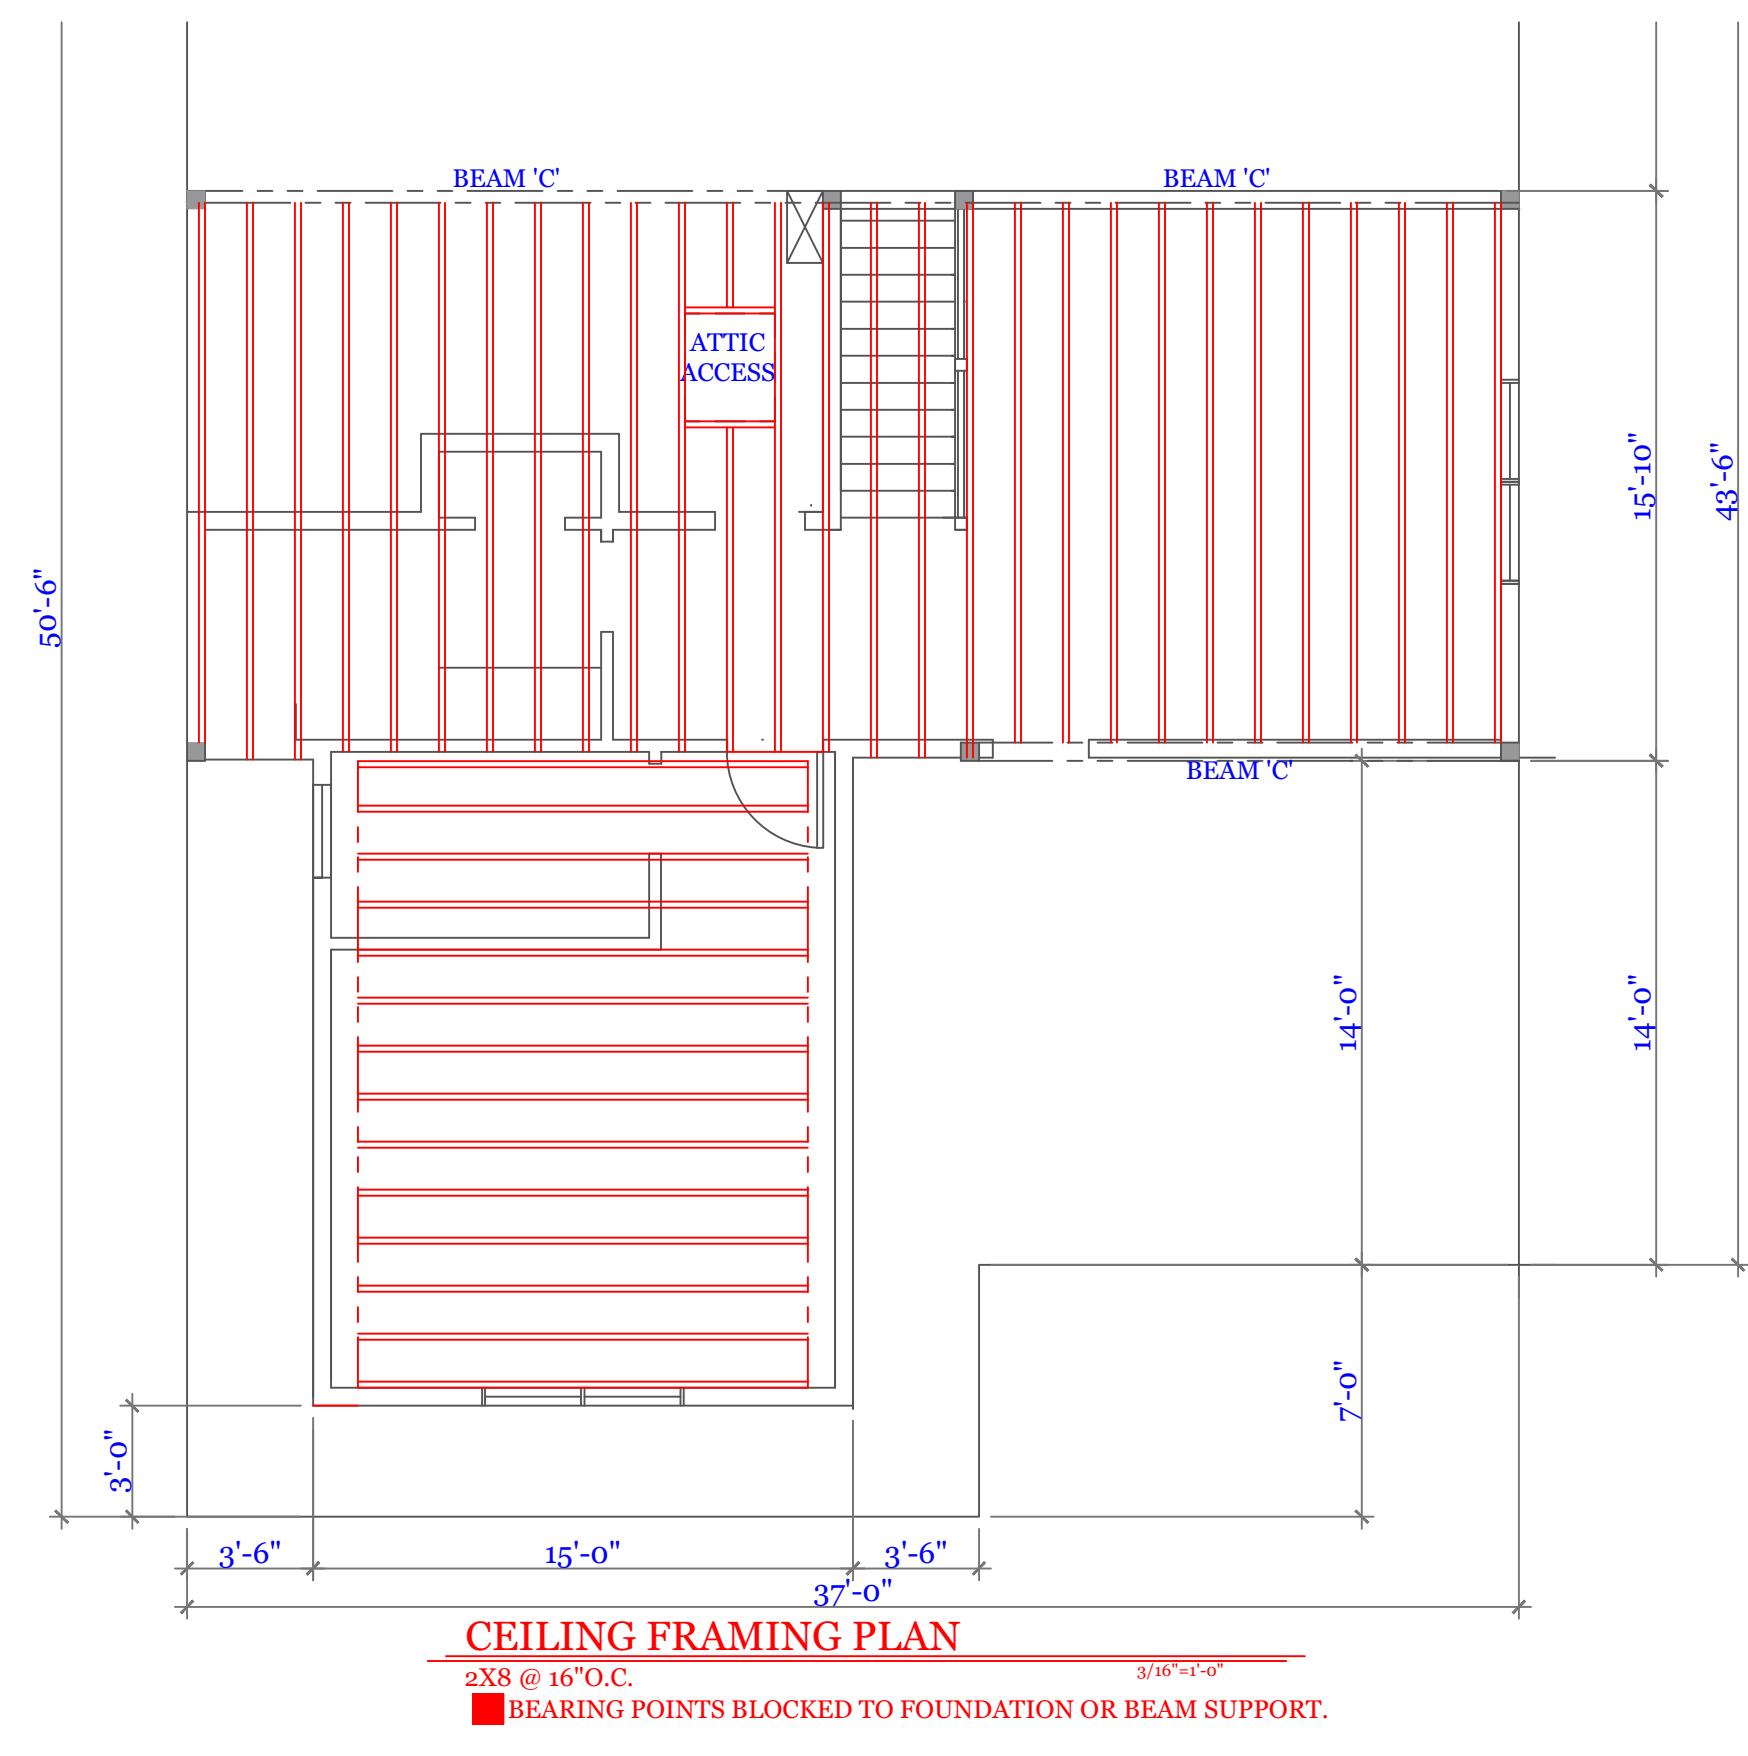
UNIT 'B'
HIGGINS FARM AT SALISBURY HILL
FOUNDATION PLAN PORTAL FRAME DETAILS

UNIT 'B' GL

DATE: 9/21/2022 R5/5
SCALE: 1/4" = 1'-0"
DRAWN BY: RCS
CHECKED BY: MJB

Sheet 2 OF 5


2



CEILING FRAMING PLANS


2X8 @ 16" O.C. 3/16"=1'-0"
■ BEARING POINTS BLOCKED TO FOUNDATION OR BEAM SUPPORT

BEAM CALCULATIONS						
BEAM	SIZE	SPAN	LIVE LOAD	TOTAL LOAD	MAX LIVE (PLF)	MAX TOTAL (PLF)
A	5 1/4" X 16" LVL	22'-0"	315	440	710	1021
B	3 1/2"X 11 7/8" LVL	15'-0"	390	520	442	647
C	5 1/4"X 14" LVL ROOF	18'-0"	160	790	610	896

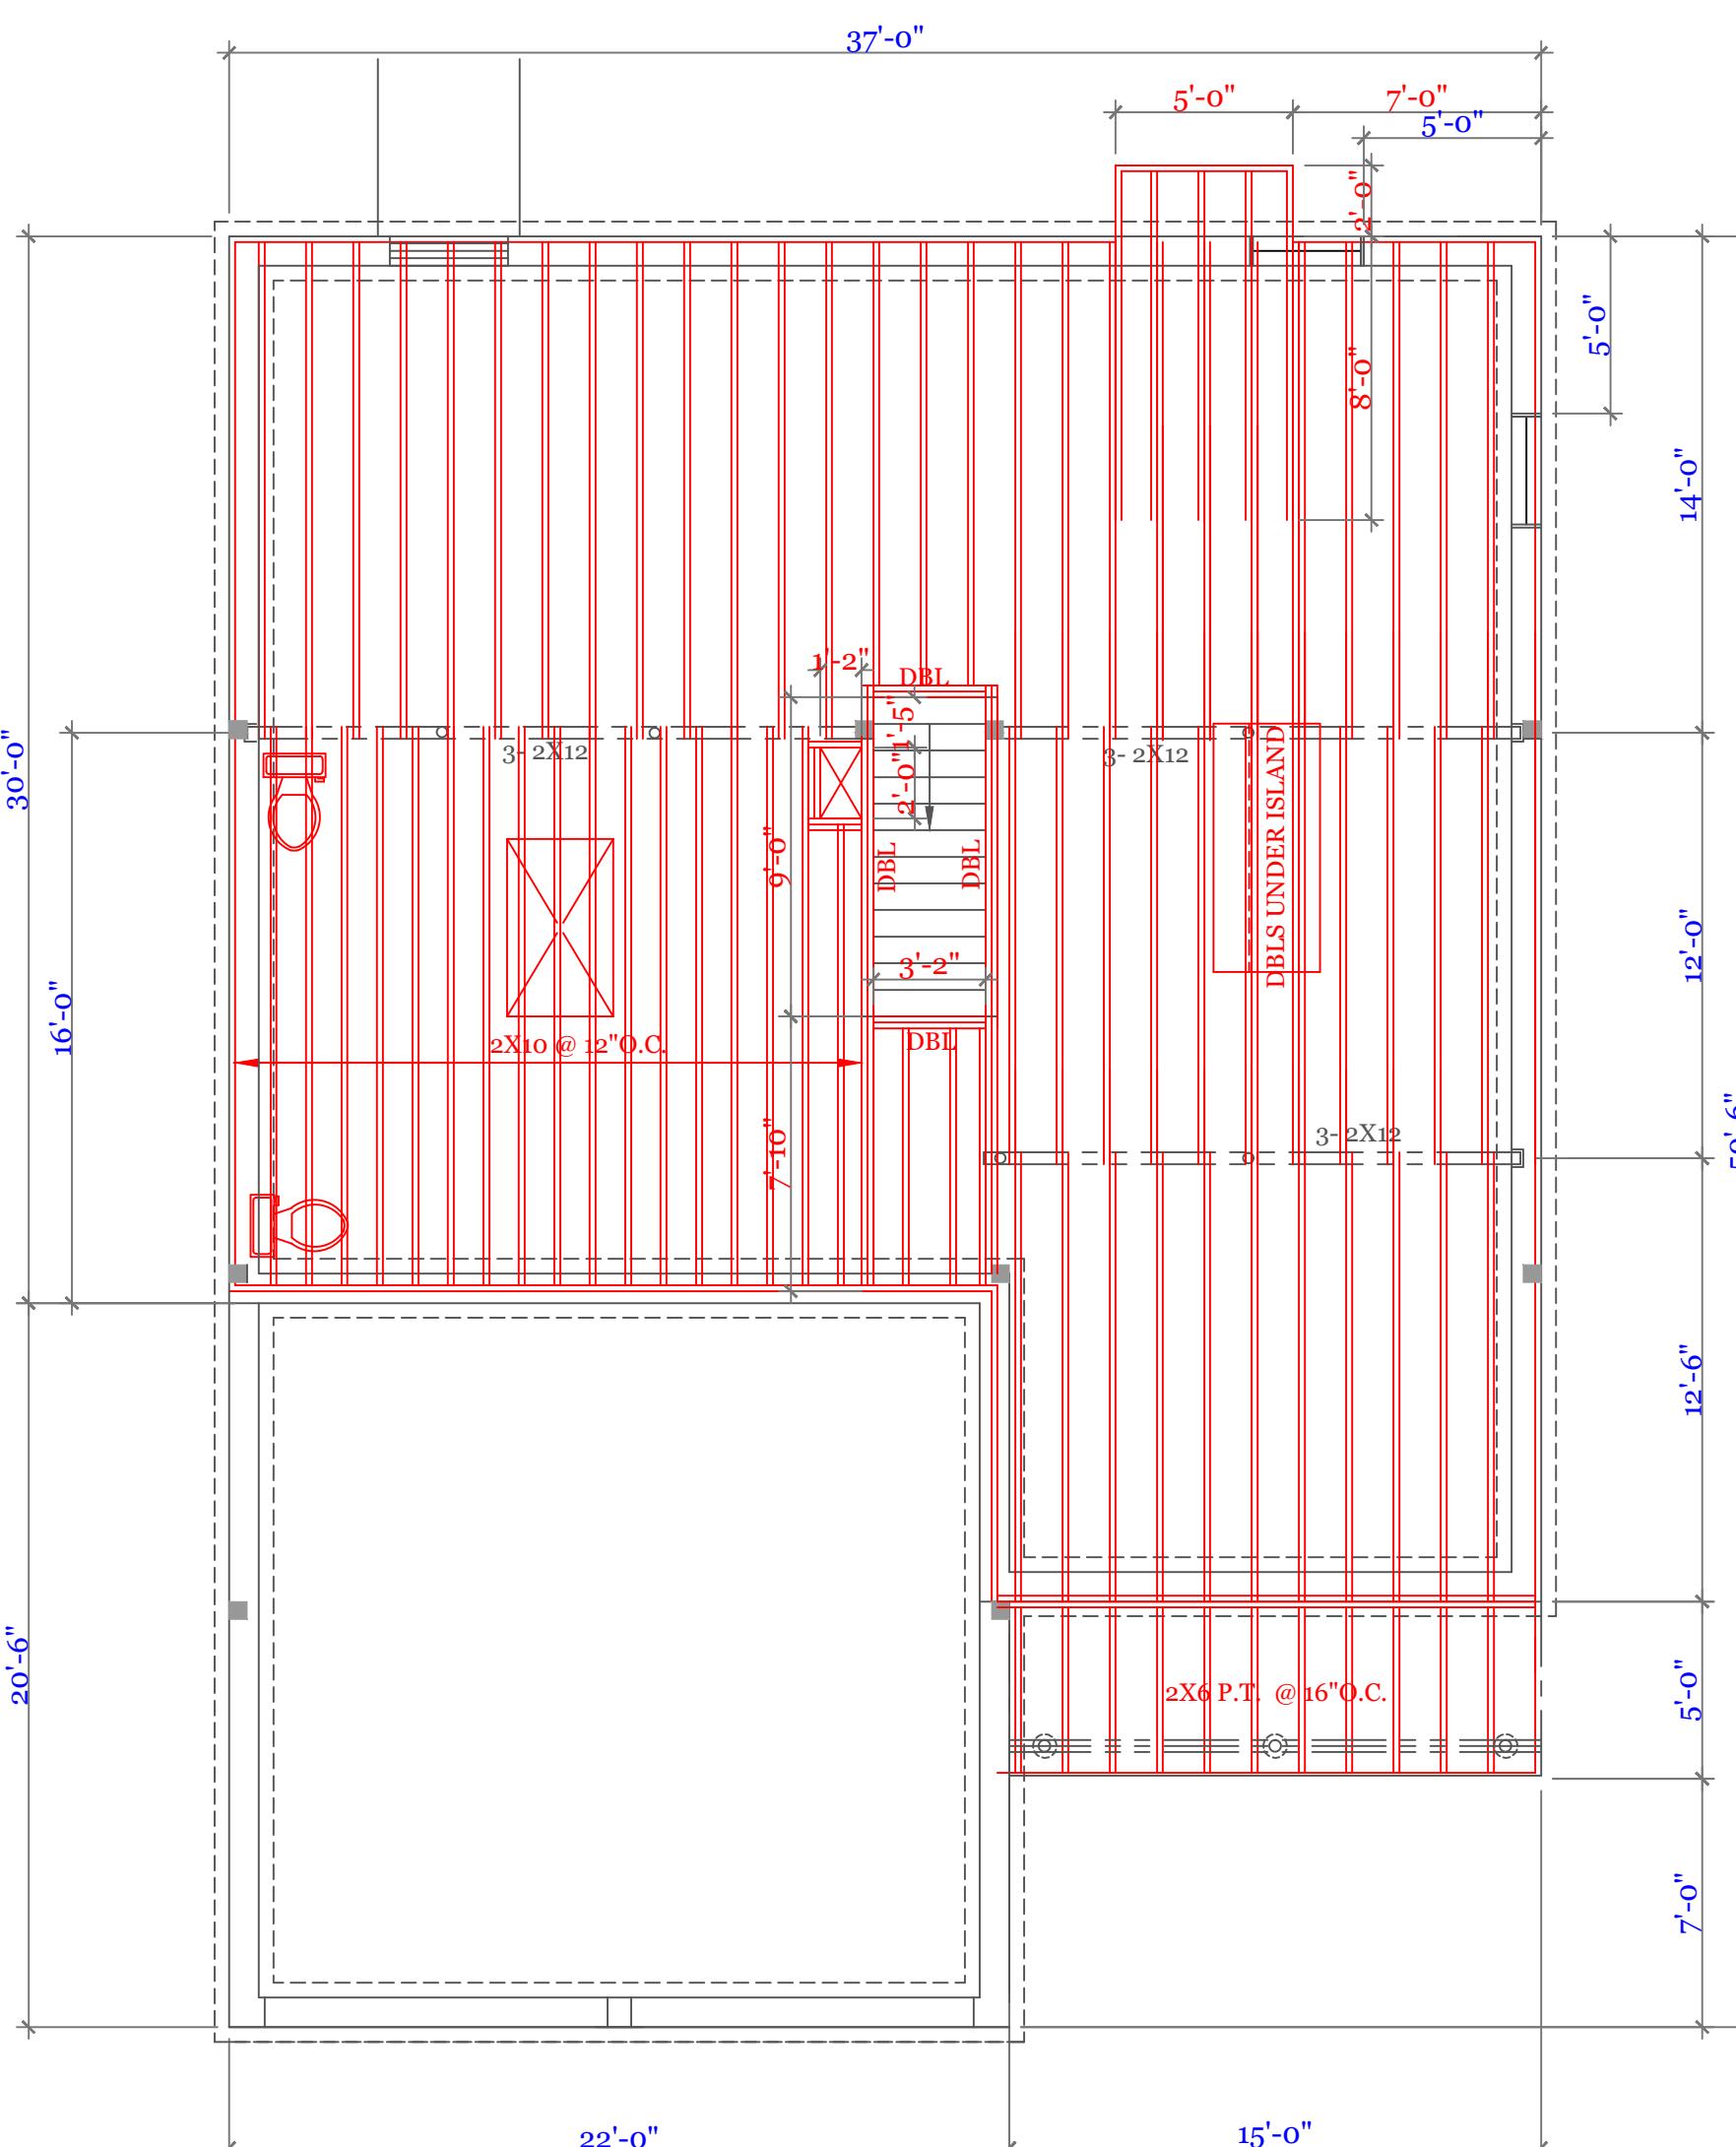


FIRST FLOOR FRAMING PLAN

2X10 @ 16"O.C. UNLESS NOTED **3/16"=1'-0"**
■ BEARING POINTS BLOCKED TO FOUNDATION OR BEAM SUPPORT.

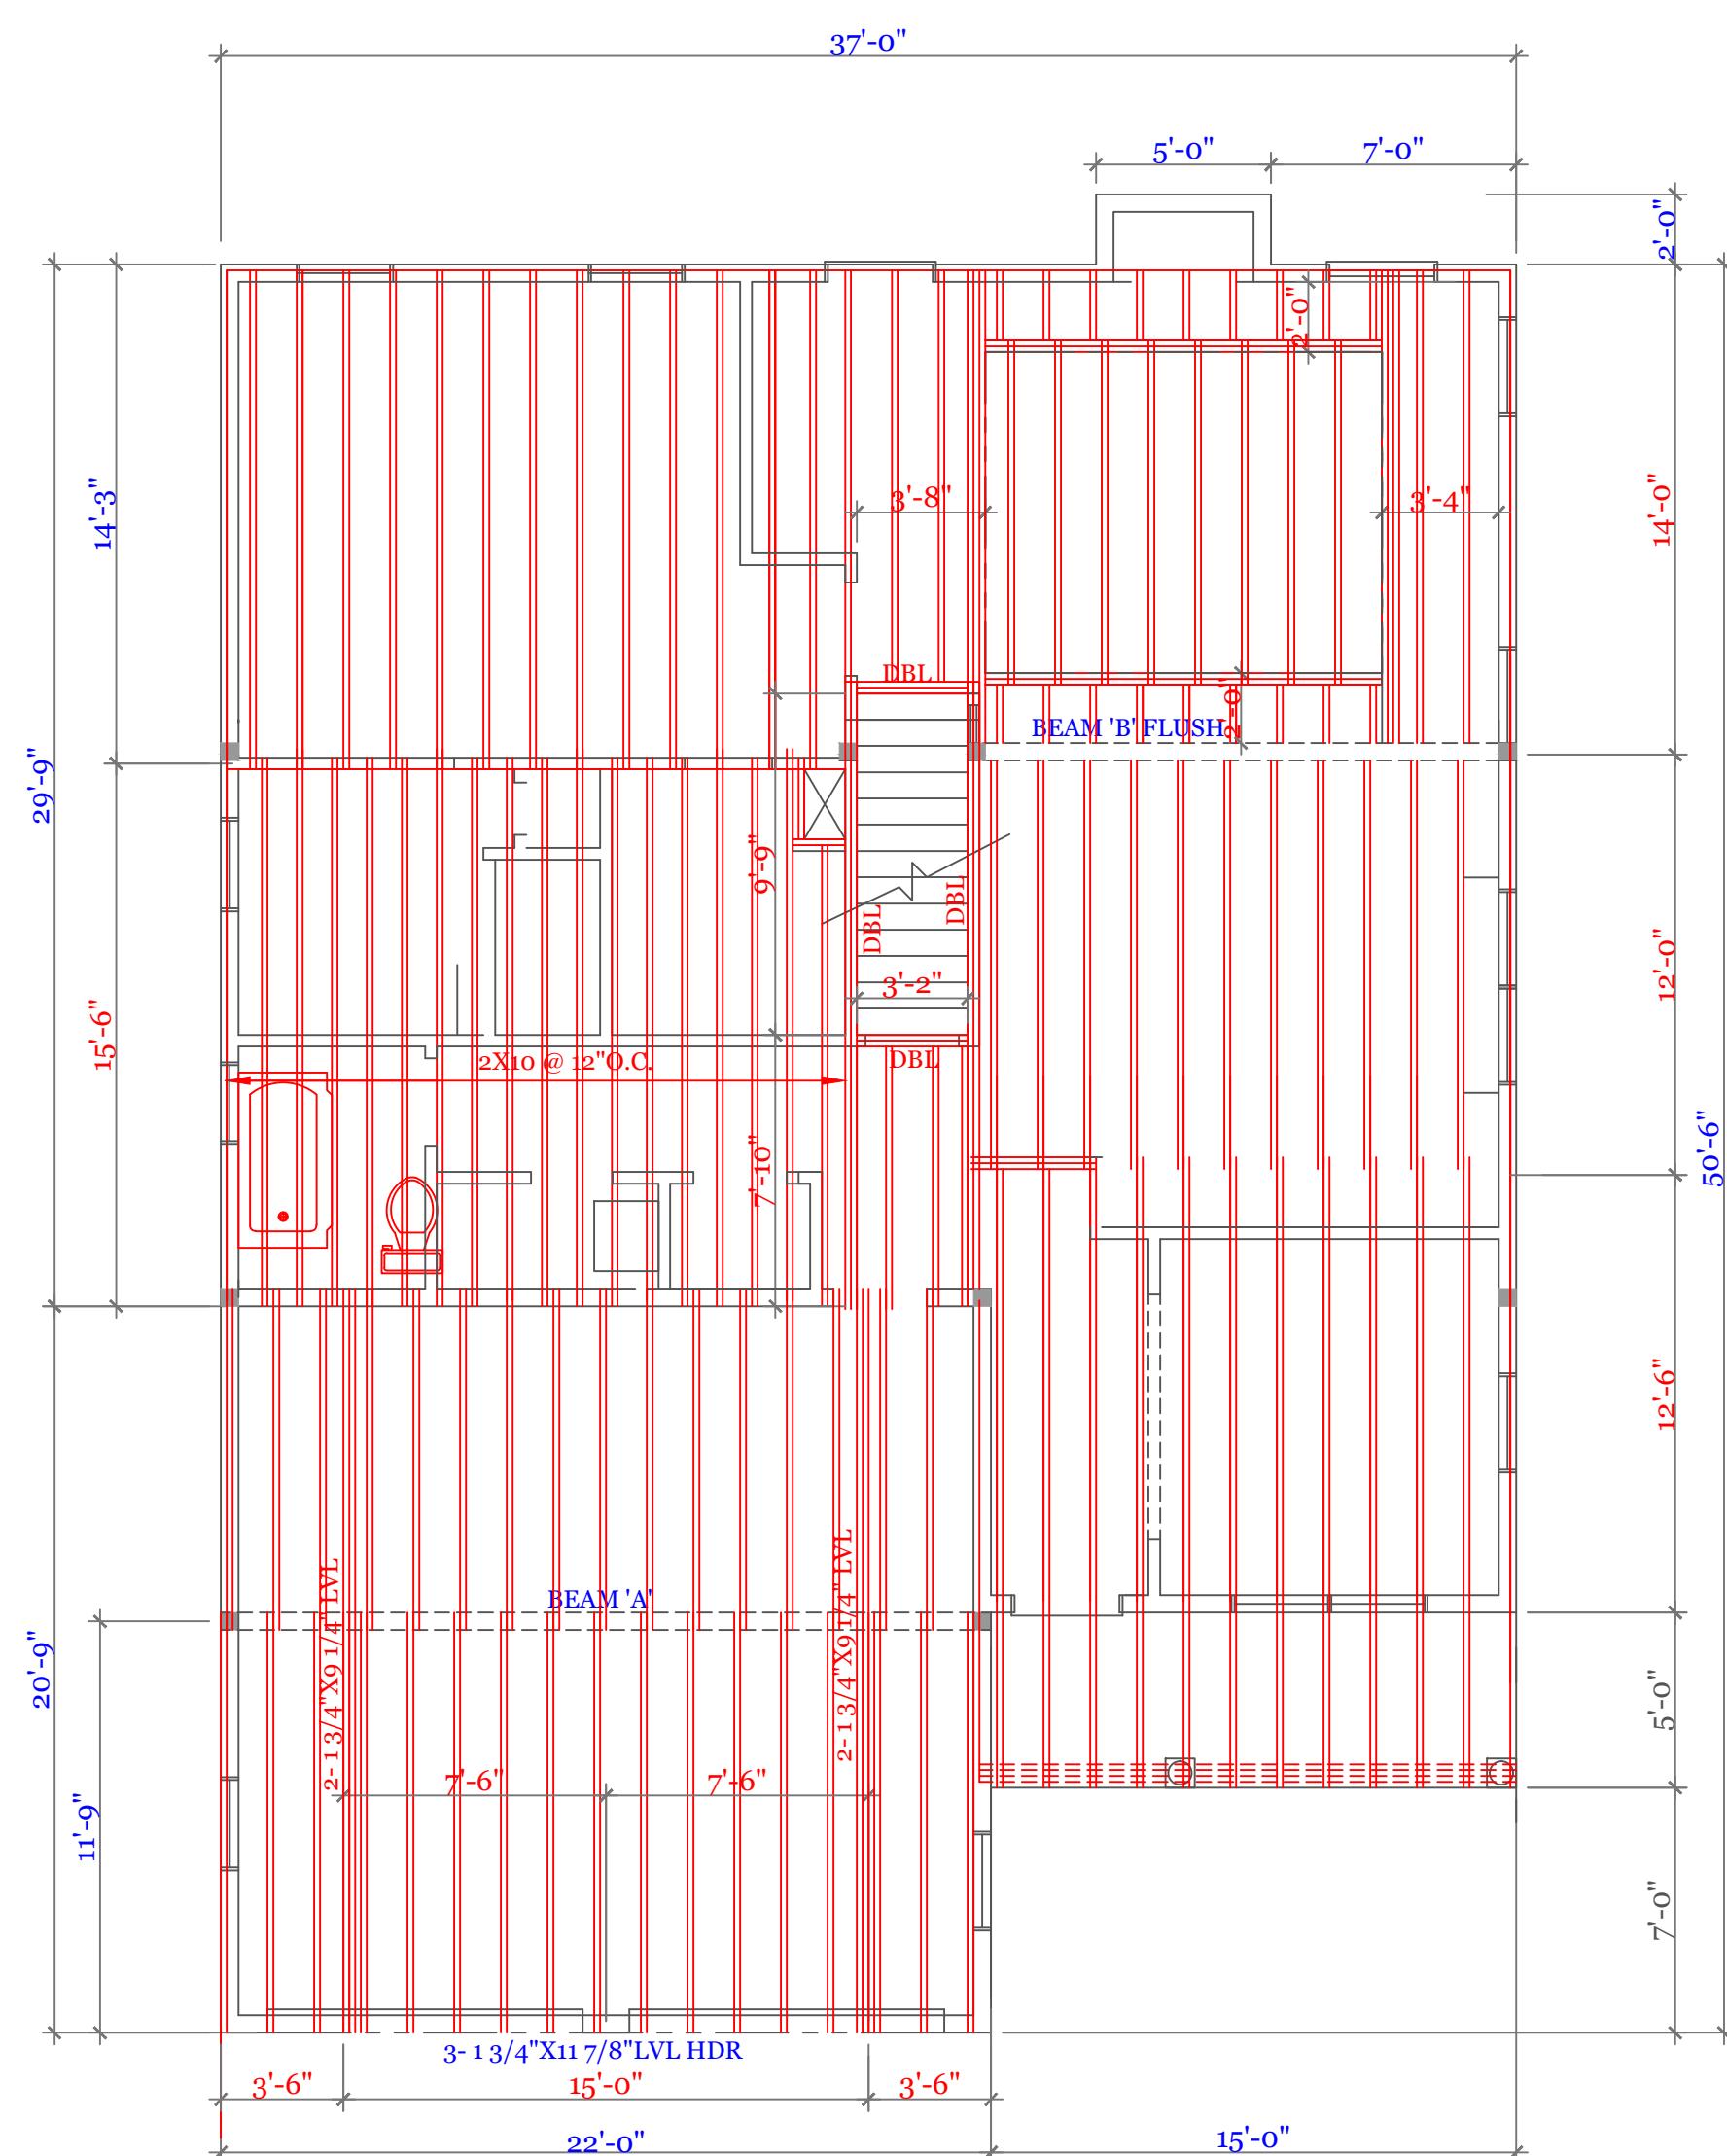

SECOND FLOOR FRAMING PL.

2X10 @ 16"O.C. UNLESS NOTED **3/16"=1'-0"**
████████ BEARING POINTS BLOCKED TO FOUNDATION OR BEAM SUPPORT

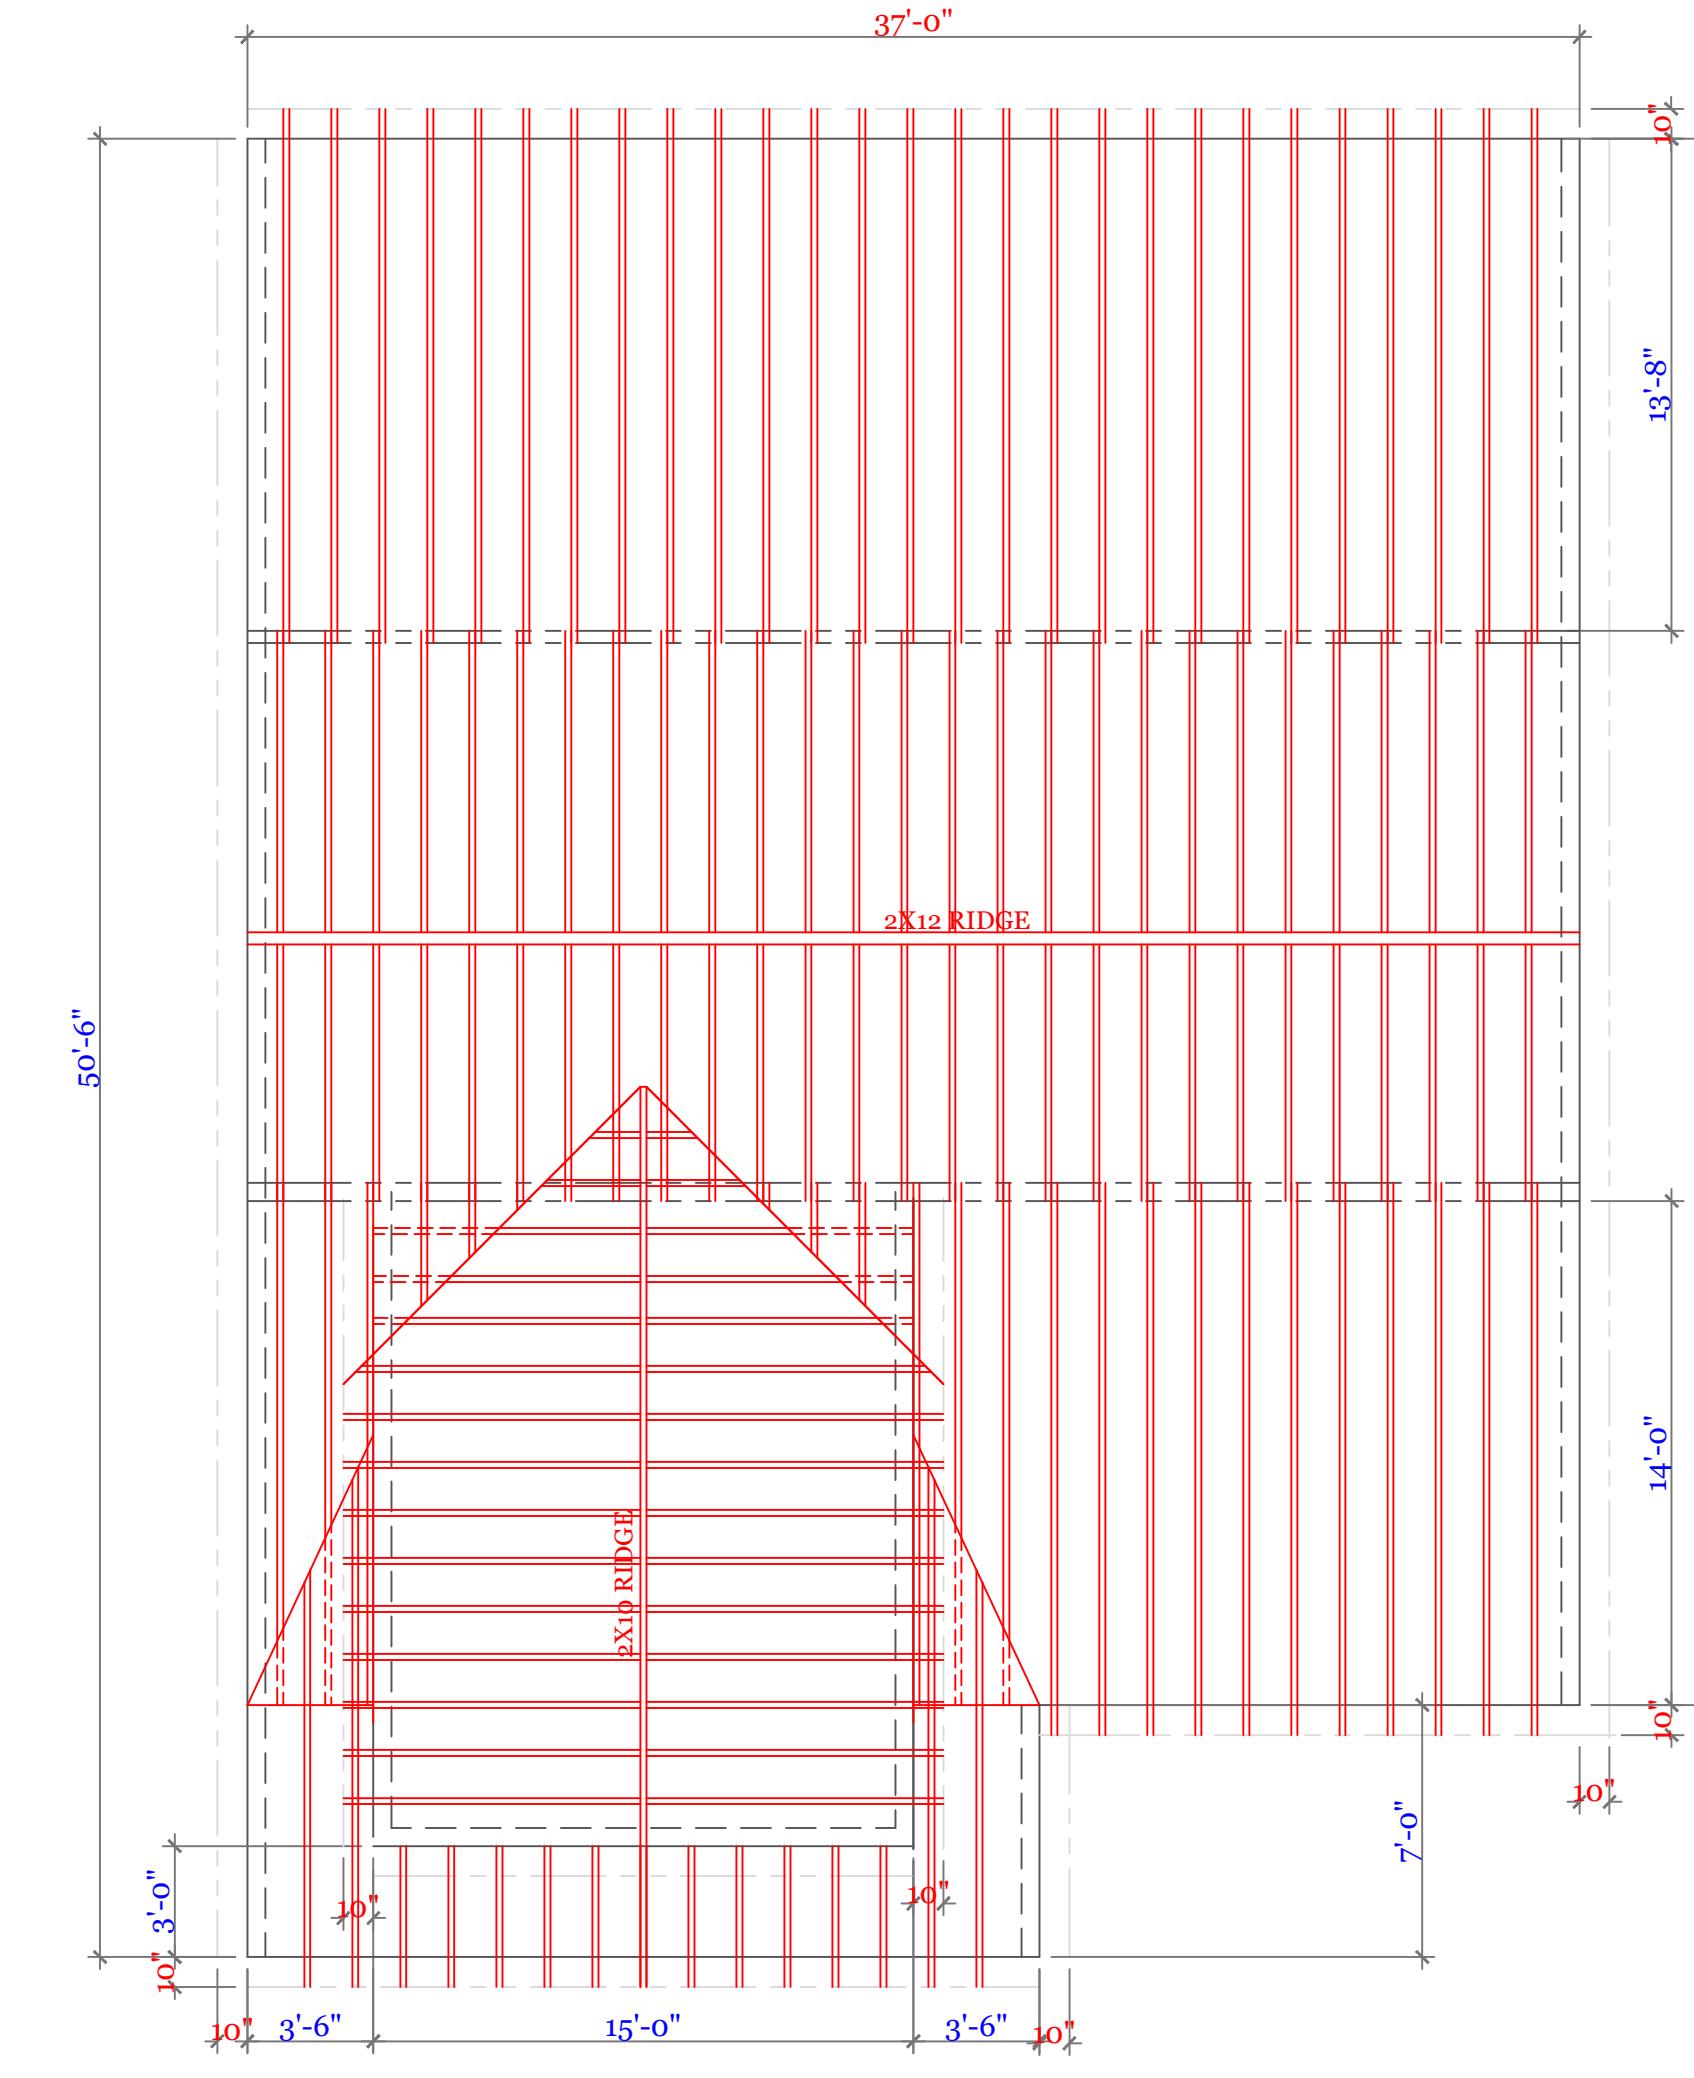

ROOF FRAMING PLAN

2X8 @ 16" O.C DORMER & GARAGE

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UNIT 'B' HIGGINS FARM AT SALISBURY HILL

FRAMING PLANS BEAM SCHEDULE

DATE: 0/21/2023 RE/8

SCALE: 3/16" = 1'

DRAWN BY:

CHECKED BY:

Sheet 5 OF 5

5

5





3

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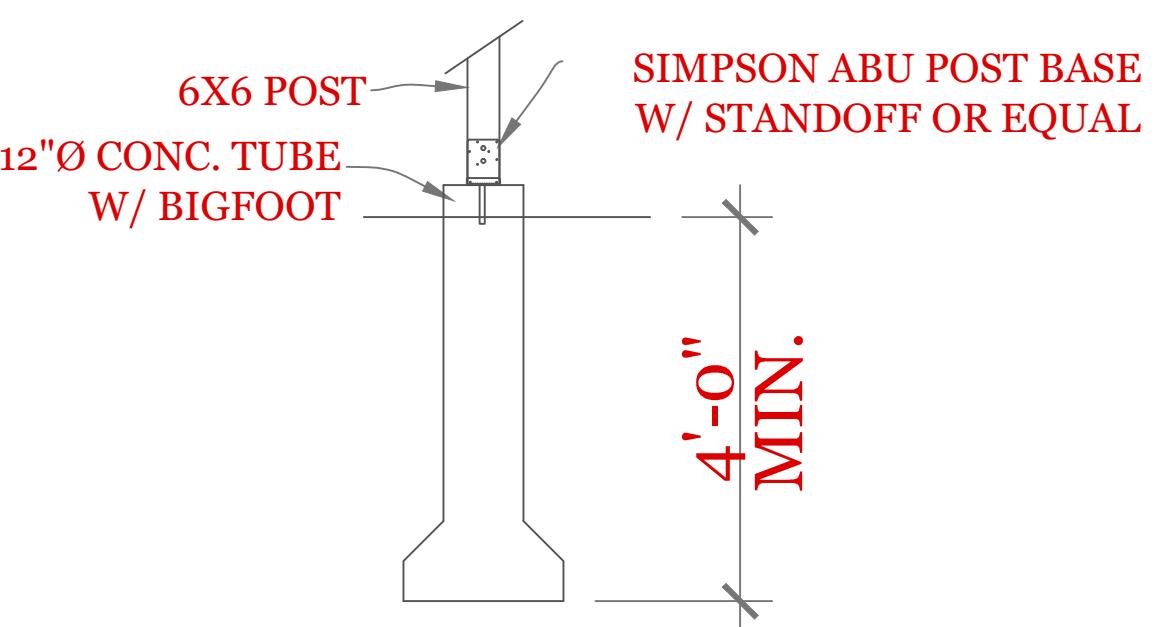
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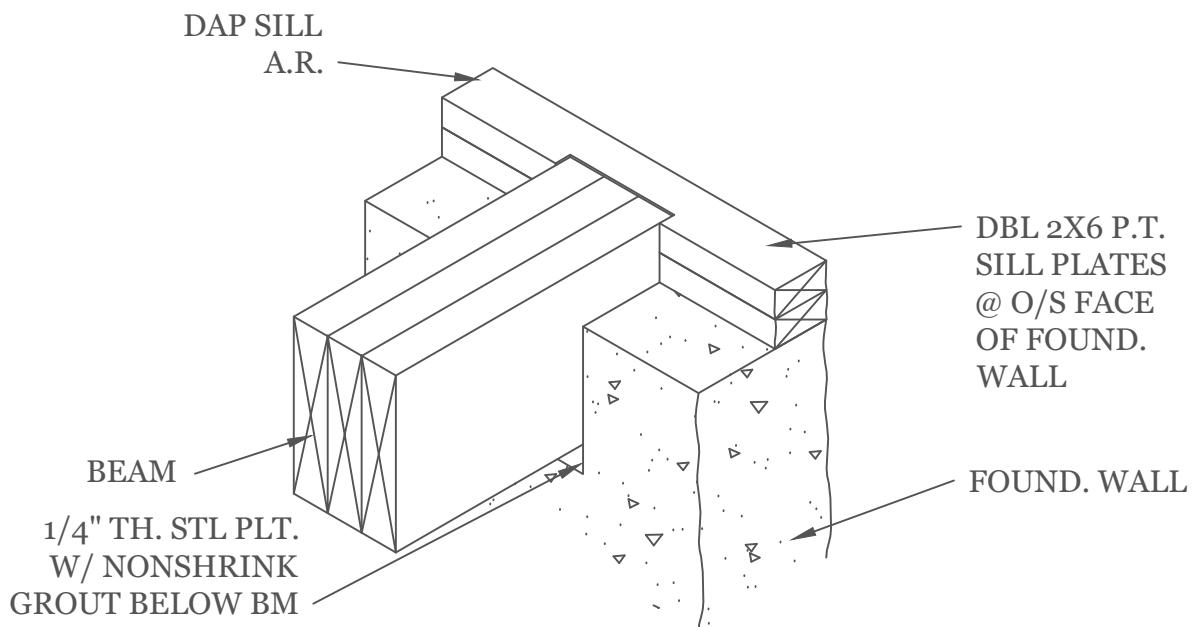
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CONSULTING ENGINEER MICHAEL J. BURKE P.E. 299 SALISBURY STR. WORCESTER, MA (508)450-3461	UNIT 'B' 1936 S.F. HIGGINS FARM AT SALISBURY HILL	ELEVATIONS
UNIT 'B' GR		
DATE: 9/21/2022 R5/5	SCALE: 1/4"=1'-0"	DRAWN BY: RCS
CHECKED BY: MJB		
Sheet 1 OF 5		
1		


TYPICAL FOUNDATION DETAILS



CONCRETE TUBE DETAIL

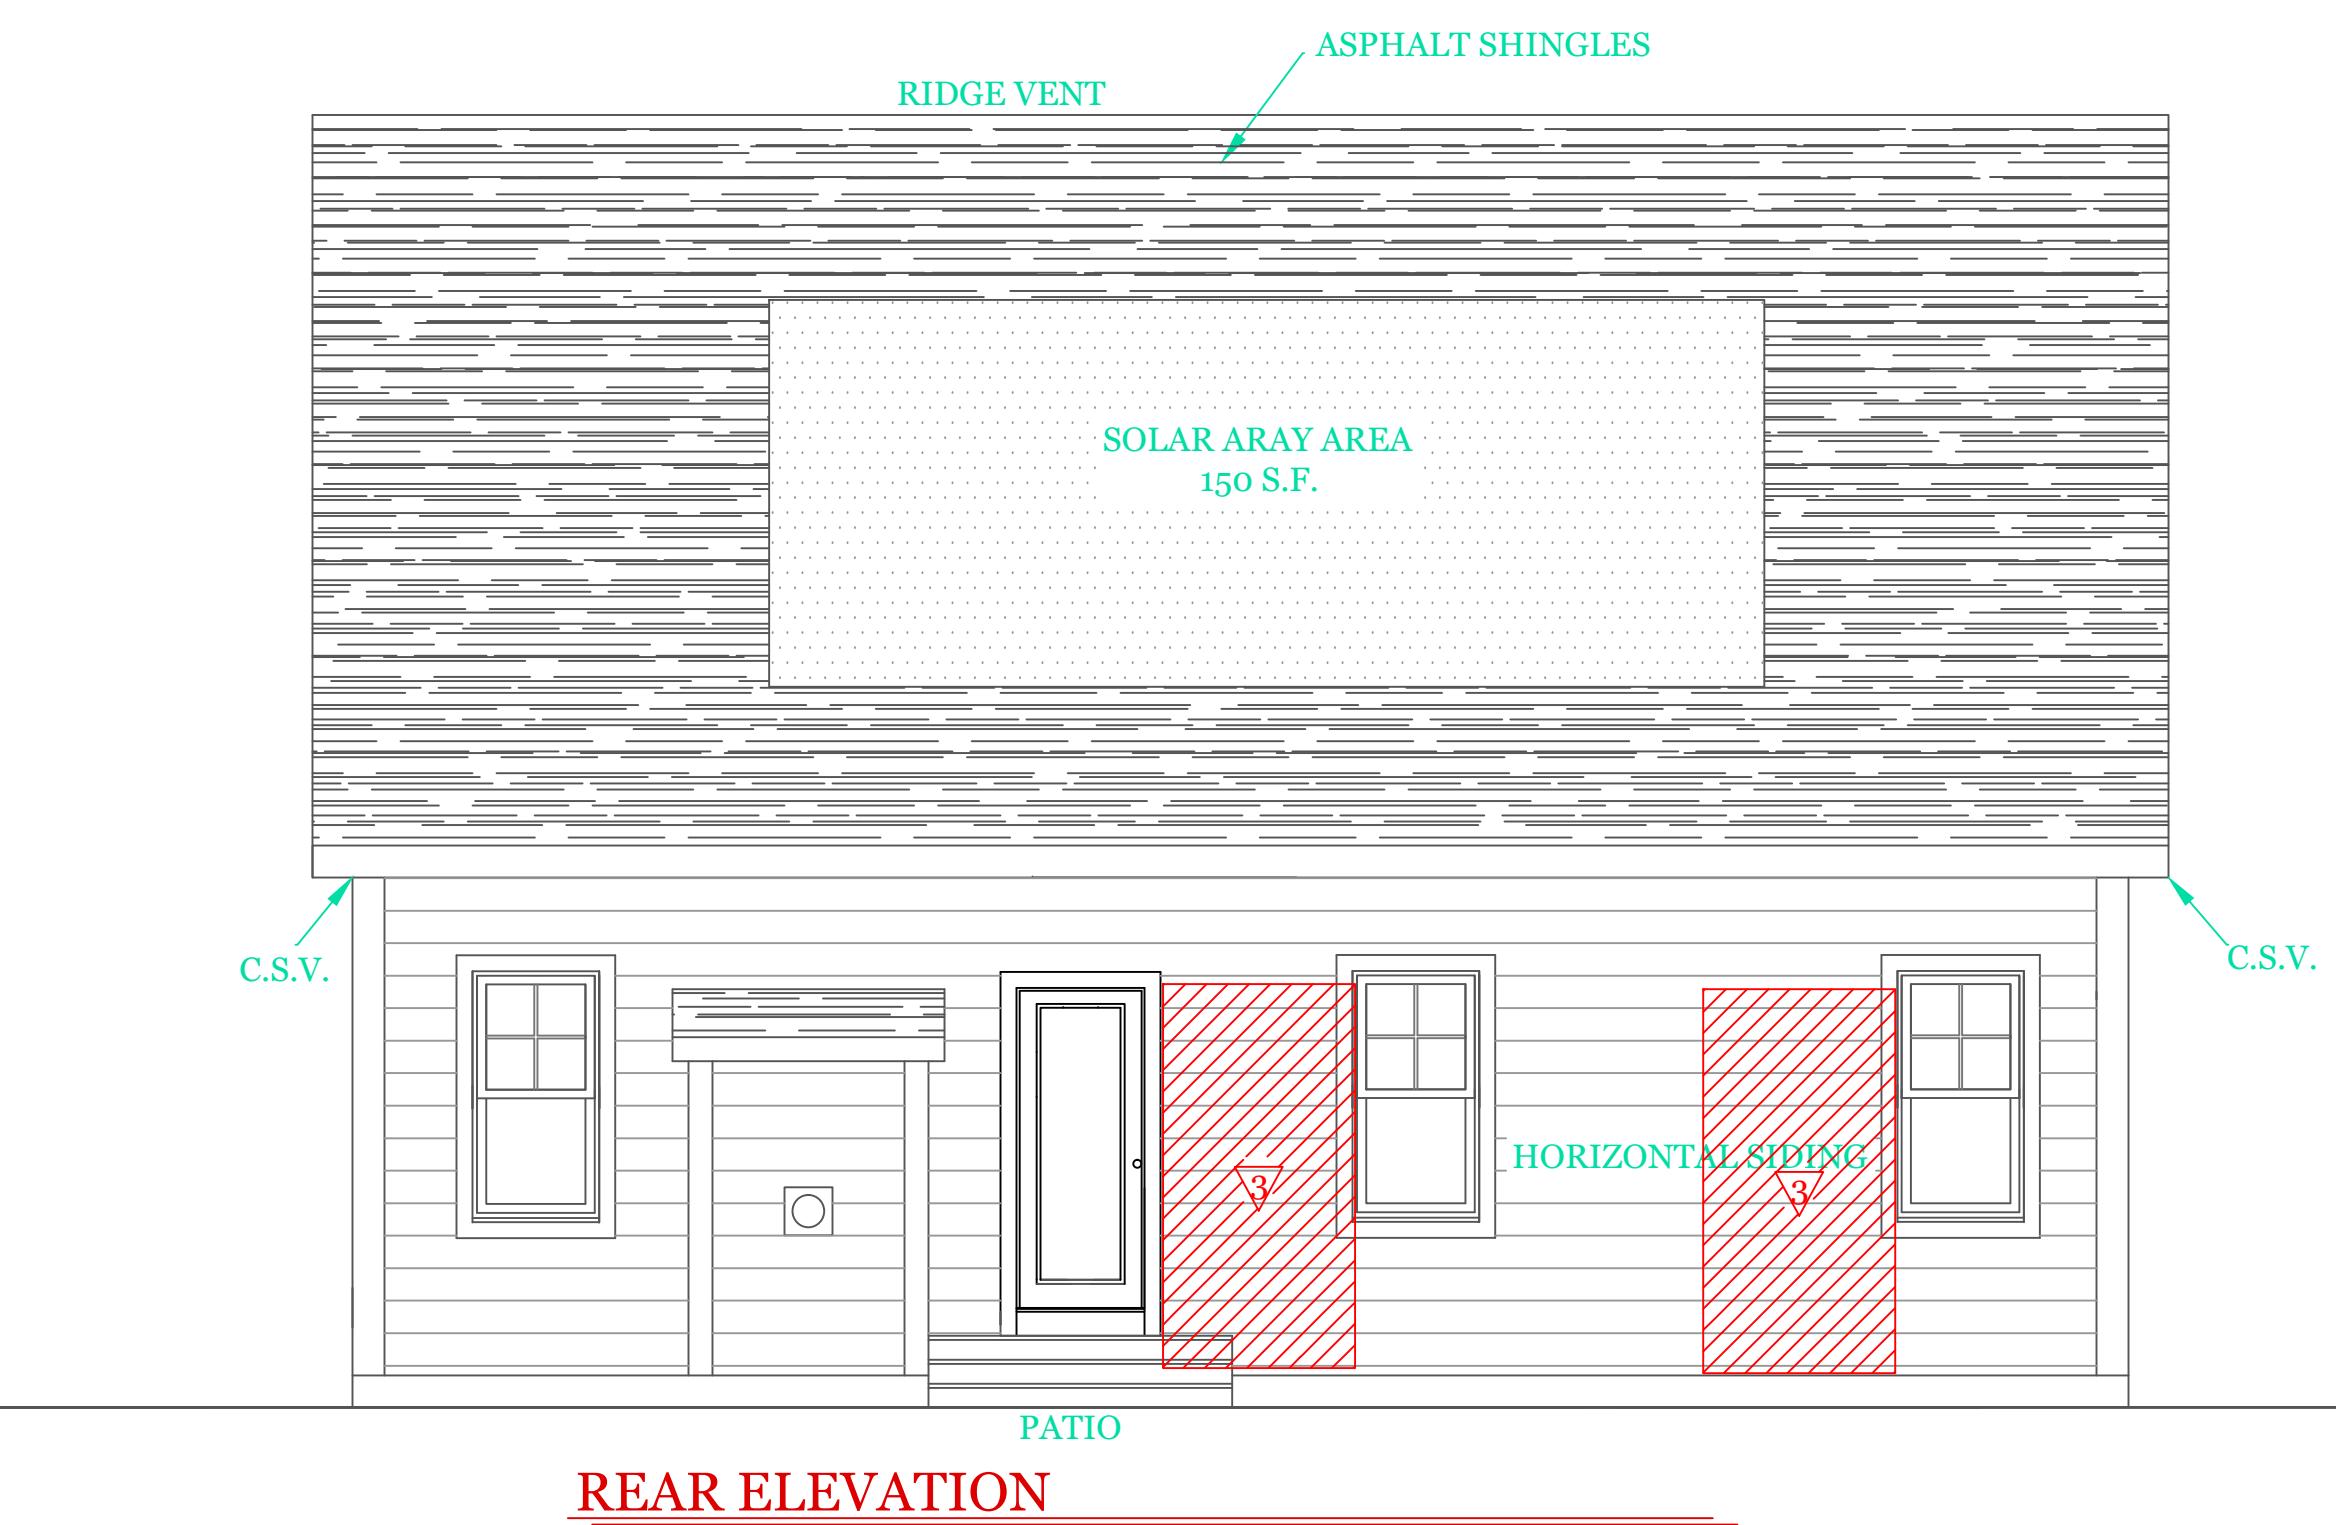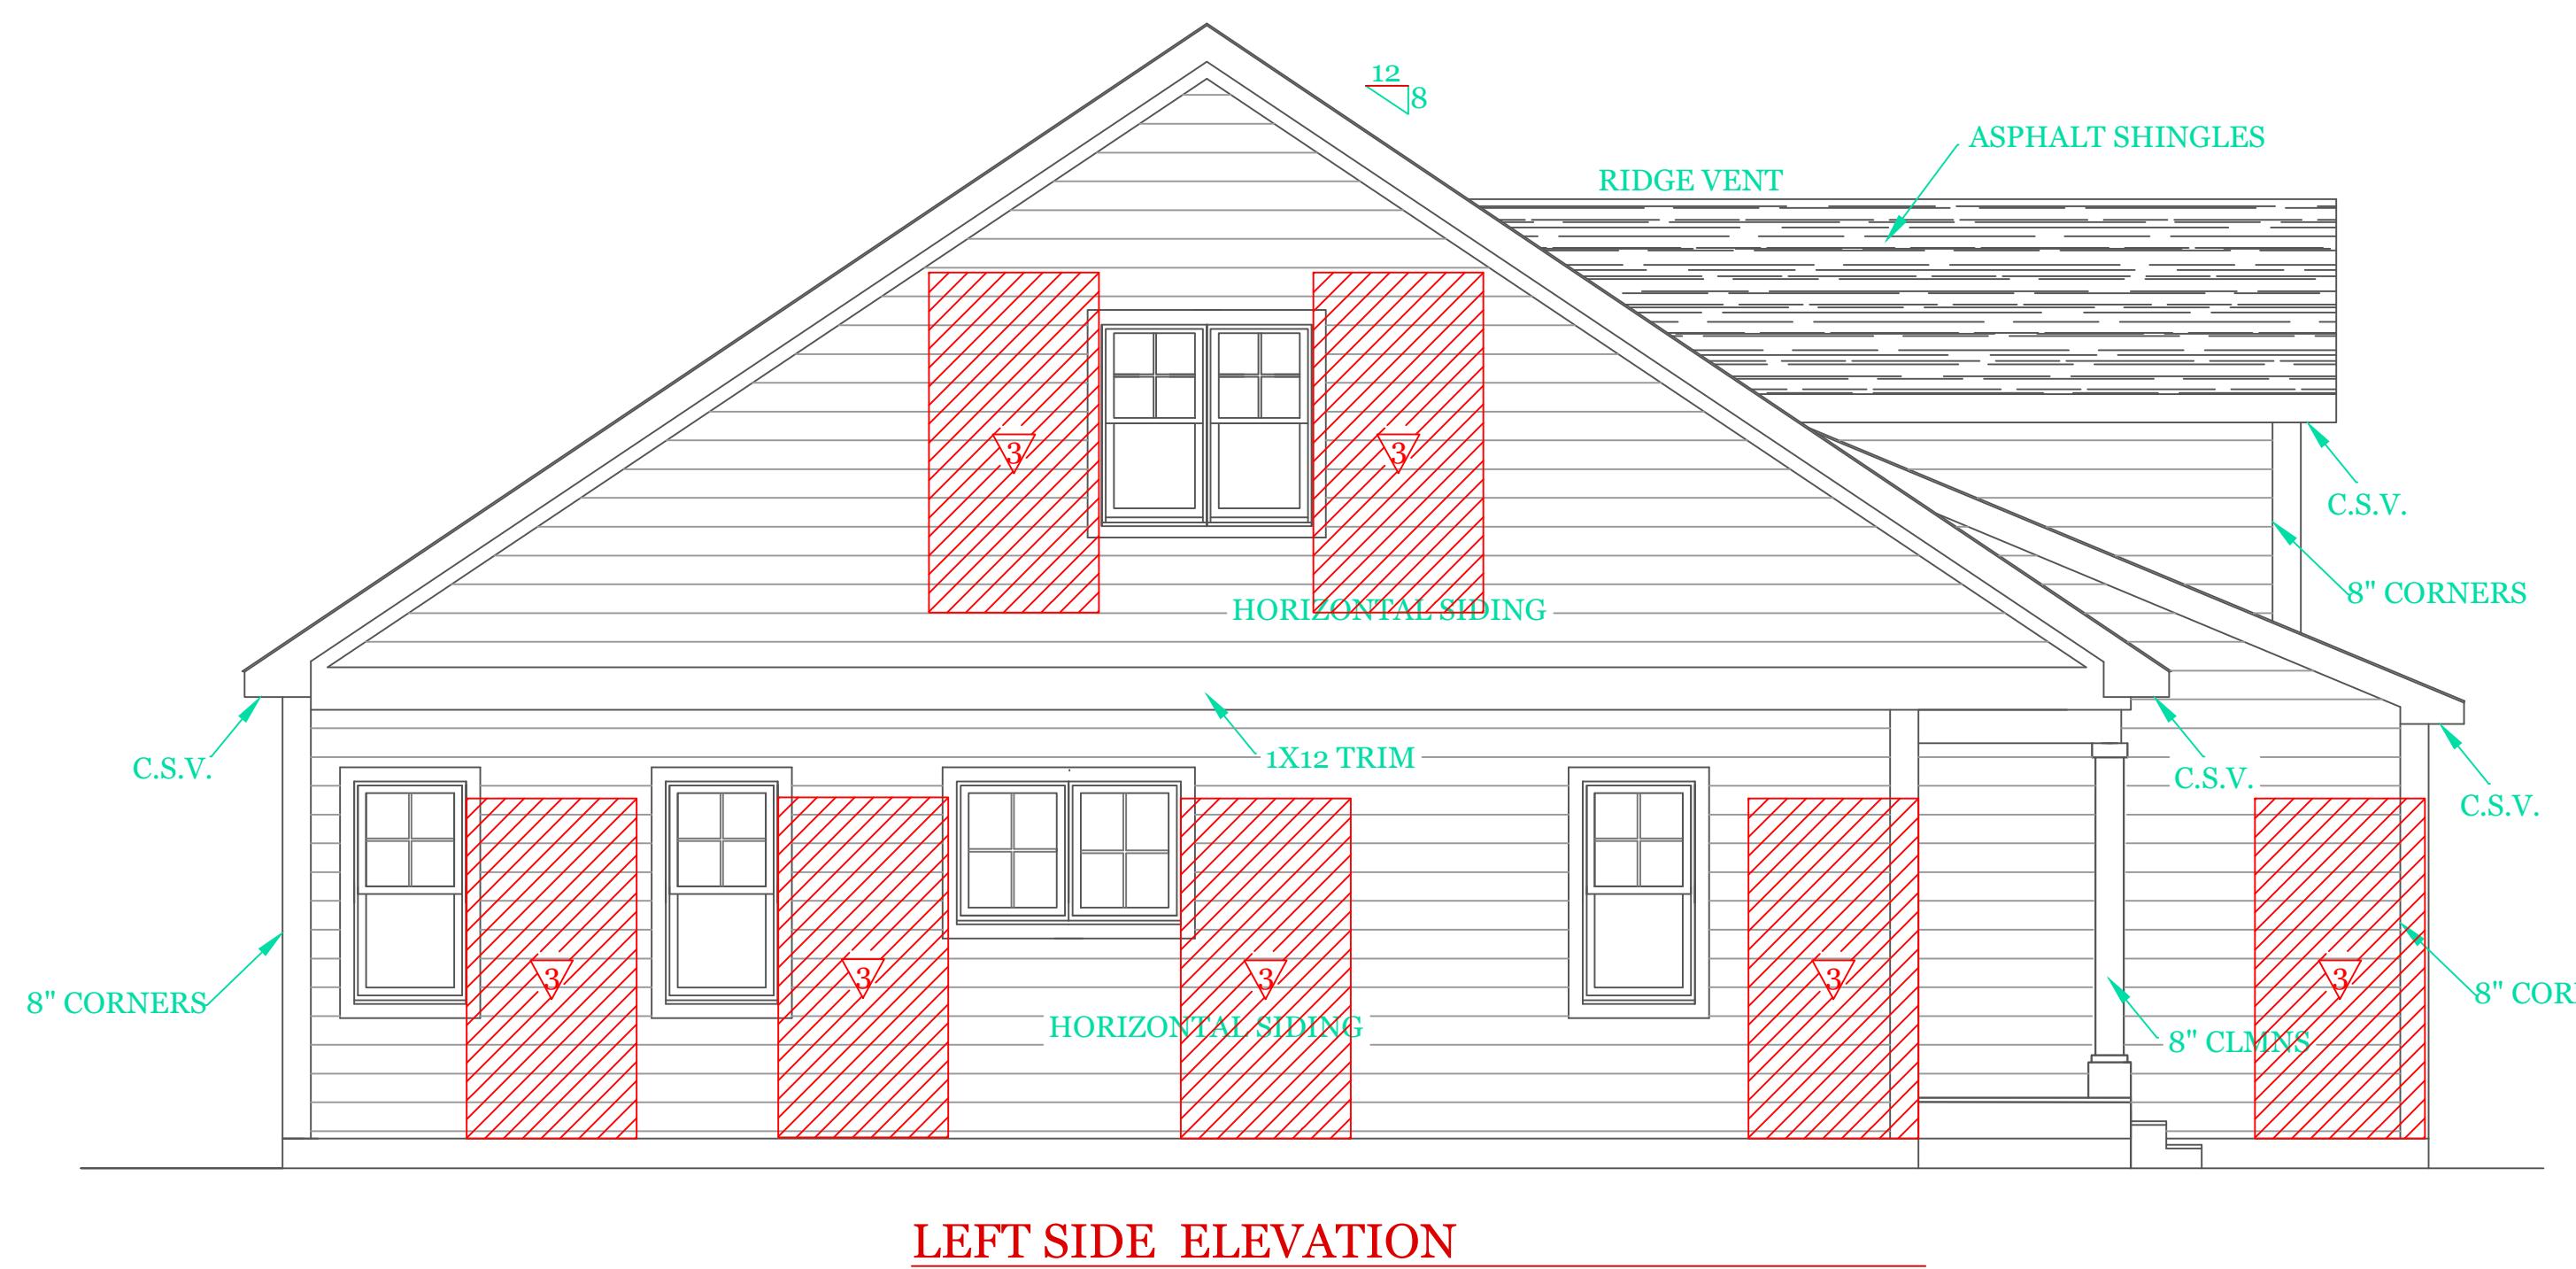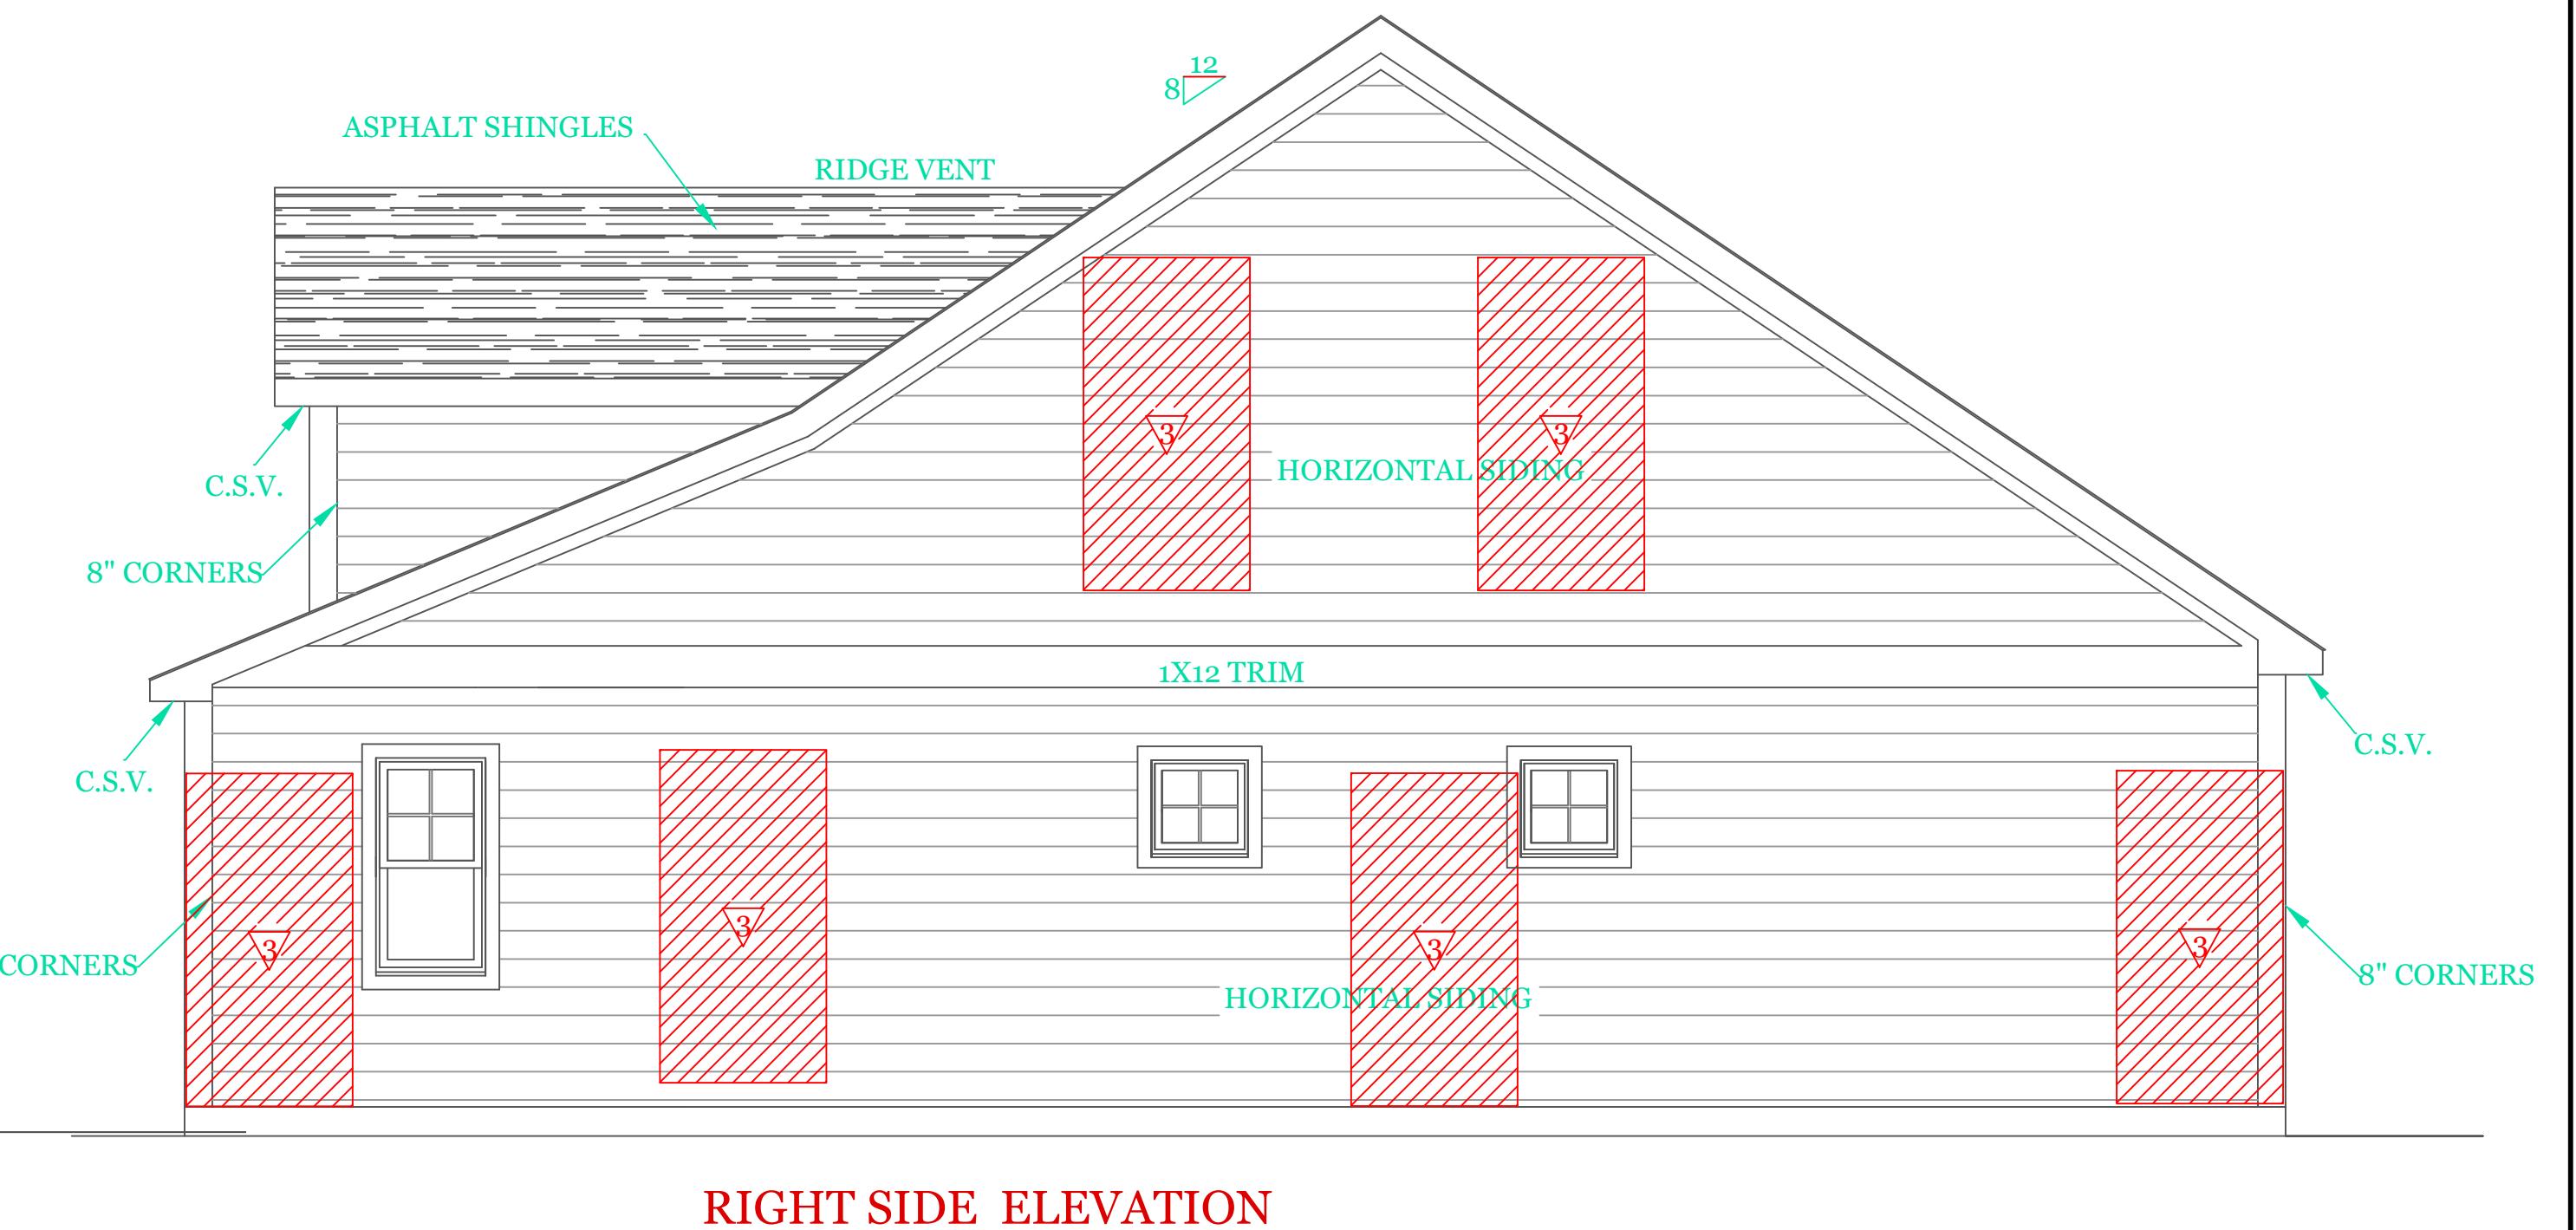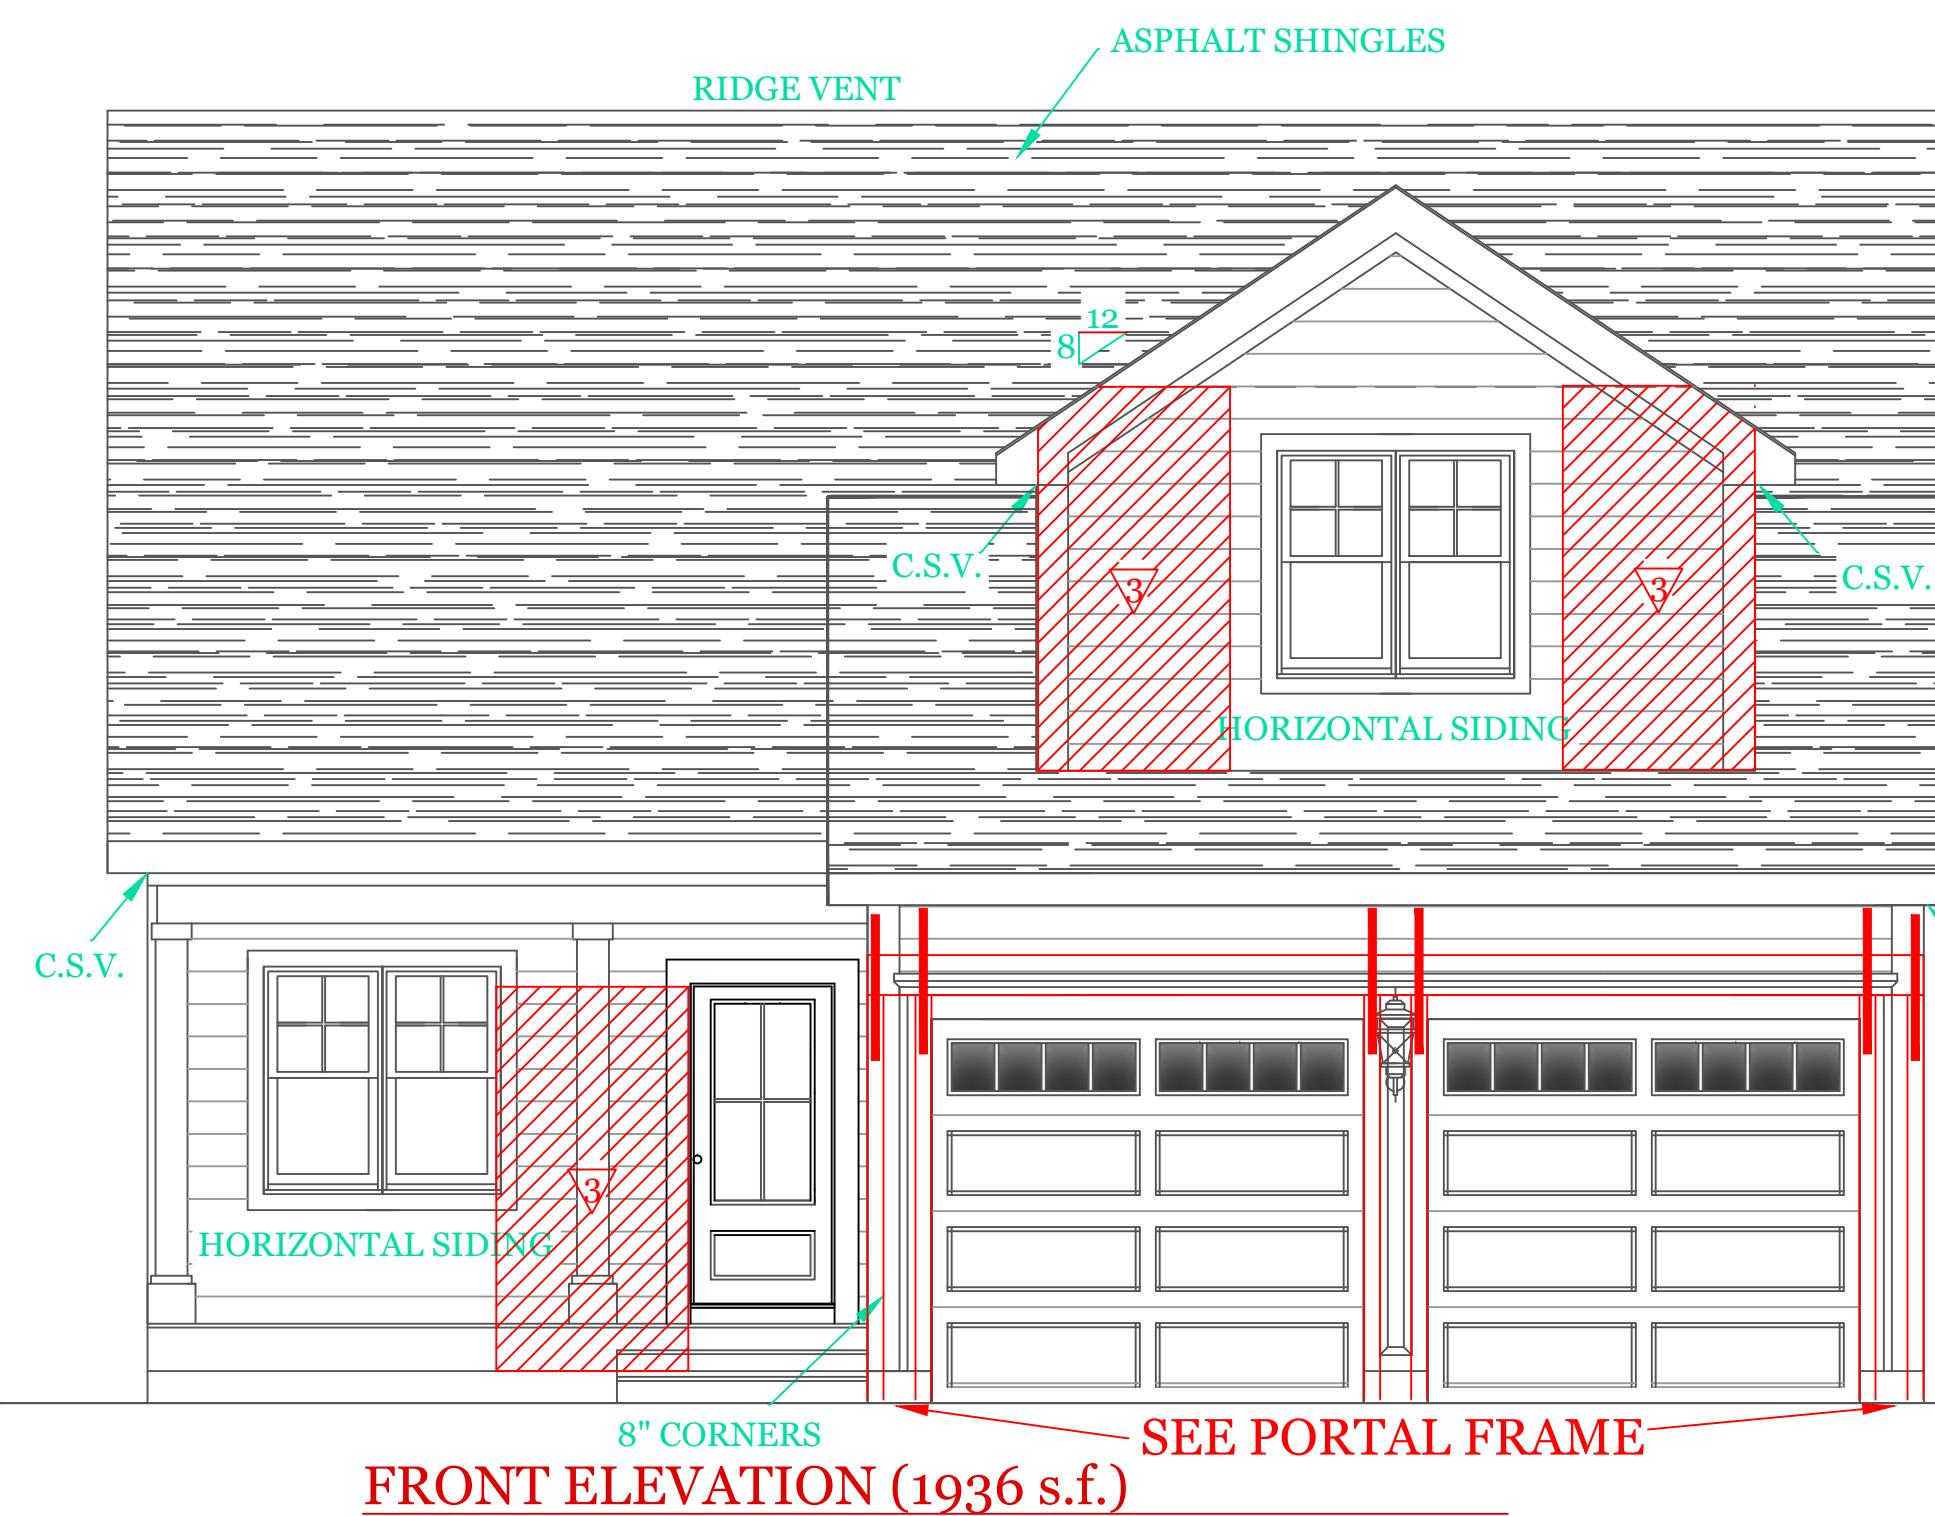


BEAM POCKET DETAIL

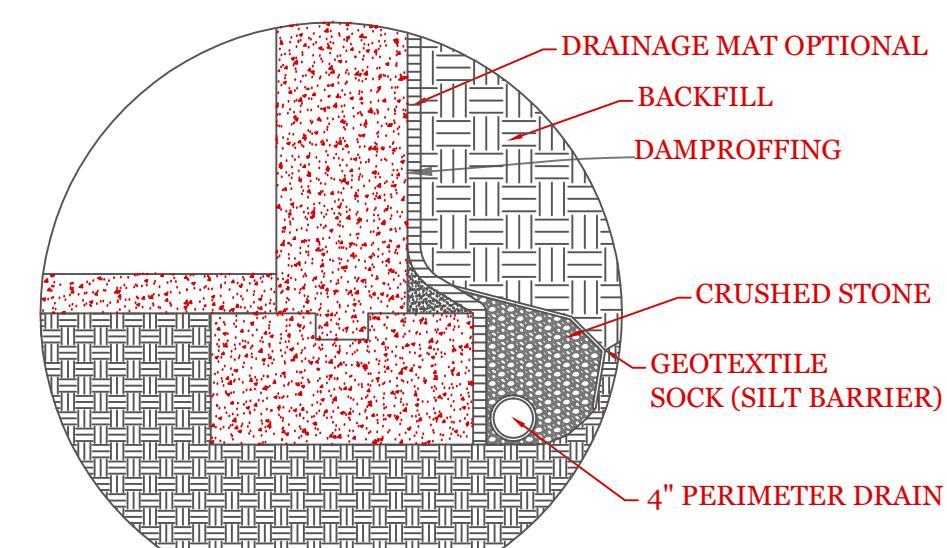

TYP. PERIMETER DRAIN DETAIL

NOTE: SLOPE DRAIN TO SUMP OR OUTFALL

NTS

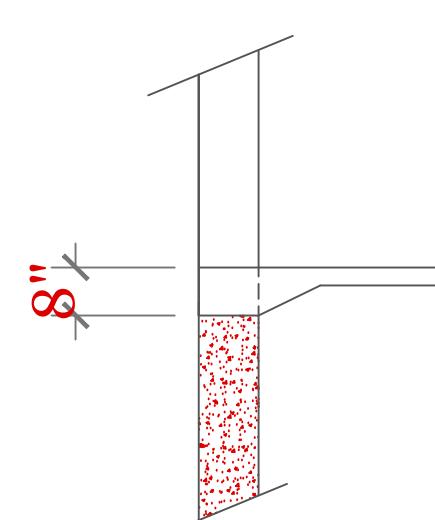


GARAGE FLOOR @ O.H.D.

3/8" = 1'-0"

SYMBOL SCHEDULE:


- [V] VENT
- [SC] SMOKE AND CARBON DETECTOR
- (S) SMOKE DETECTOR
- [H] HEAT DETECTOR
- BEARING POINT
W/ SQUASH BLOCK

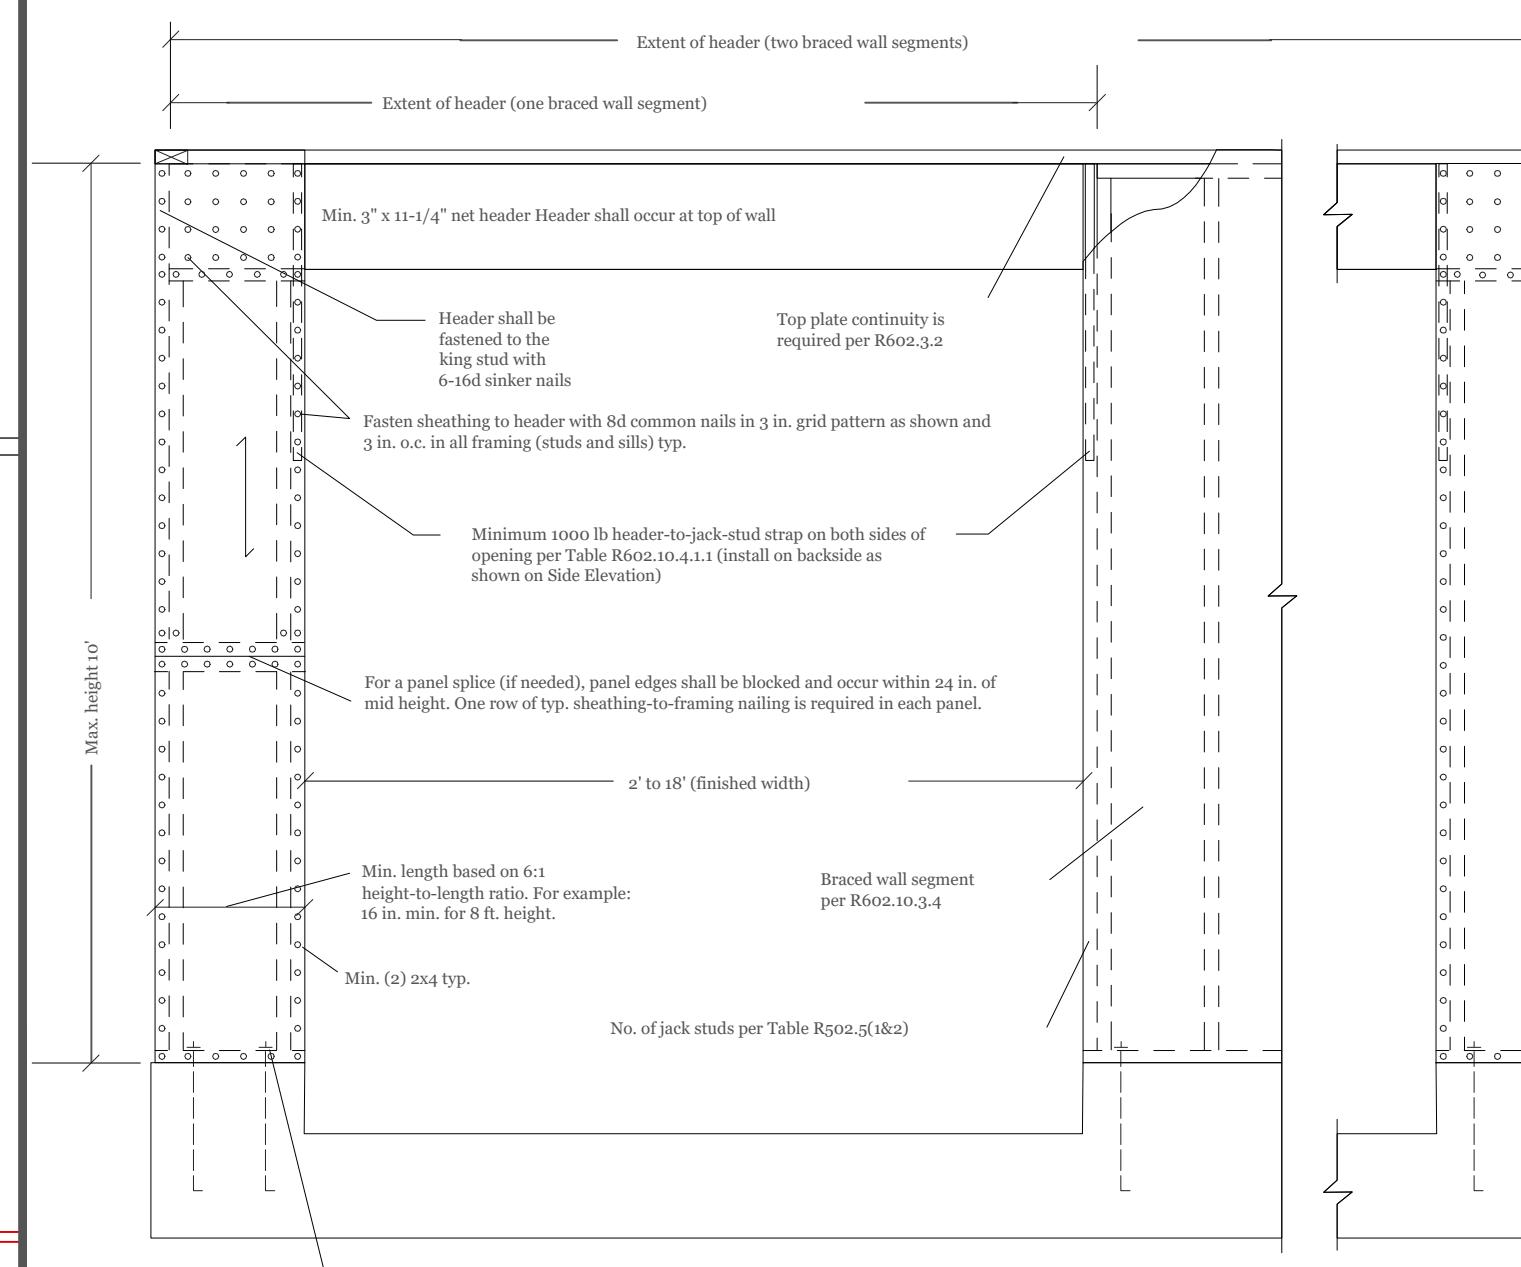

PORTAL FRAME


NTS

SECTION

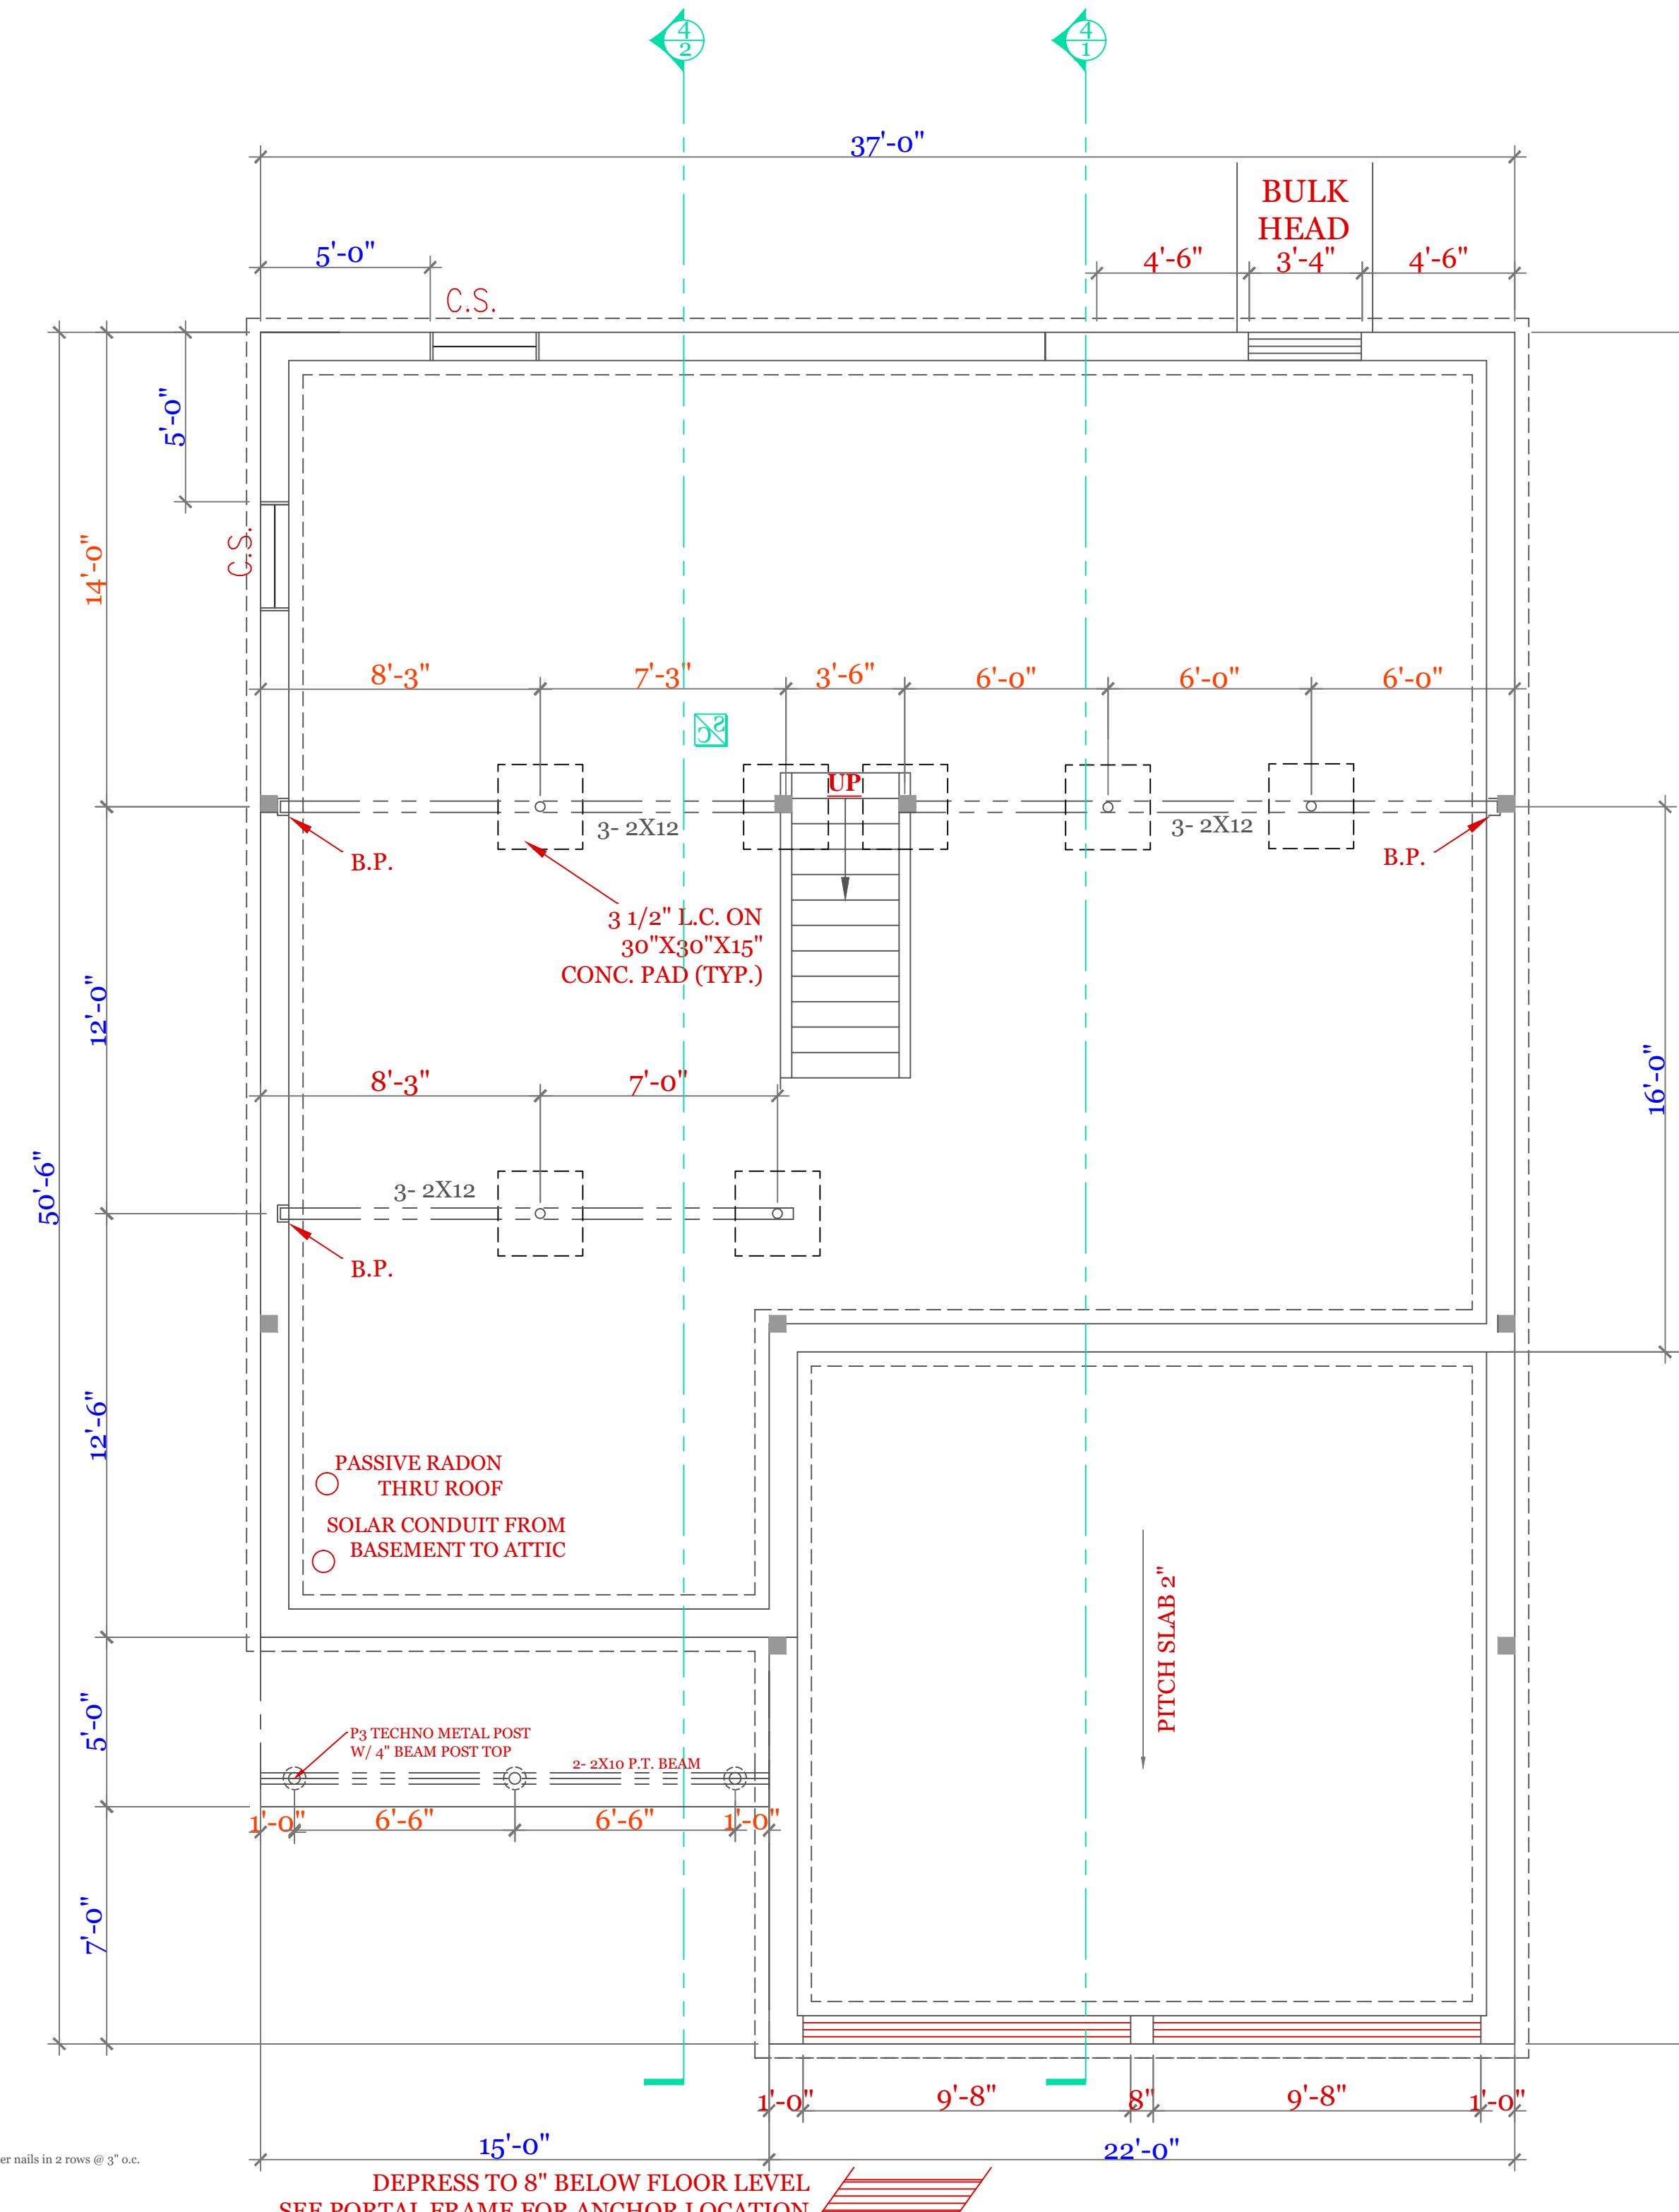

FOUNDATION PLAN

■ BEARING POINTS BLOCKED TO FOUNDATION OR BEAM SUPPORT.

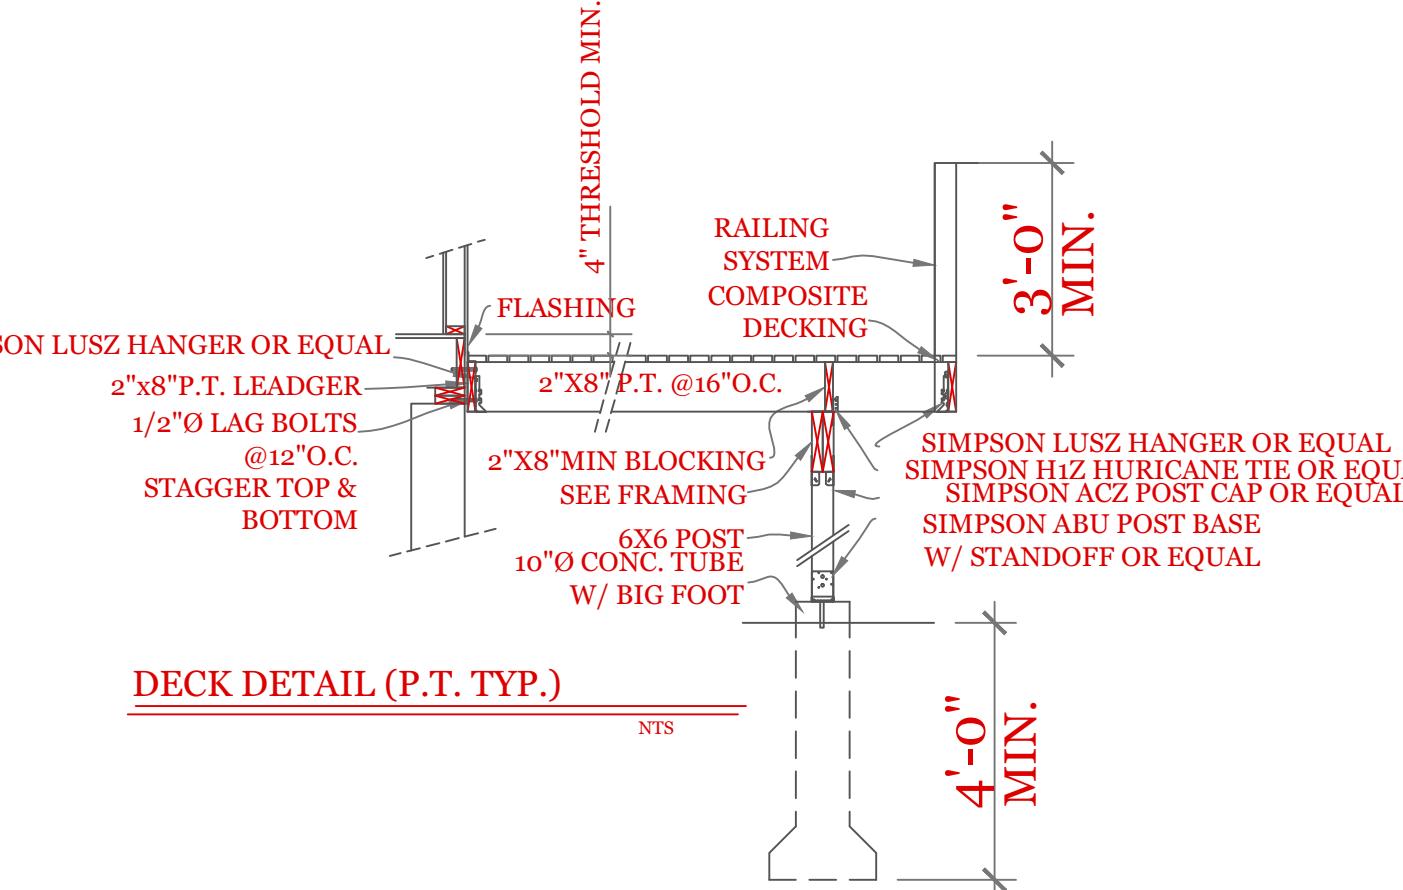

DECK DETAIL (P.T. TYP.)

NTS

NOTES:

- FOUNDATION NOTES:
 - HOUSE FOUNDATION- 10"X7"-10" POUR ON 20"X10" CONTINUOUS KEYED FOOTING. FOOTING TO BE PLACED ON UNDISTurbed SOIL OR 95% COMPACTED GRAVEL FREE OF ORGANIC SOIL AND MATERIAL.
 - GARAGE FOUNDATION- 8"X4"-0" MINIMUM POUR ON 16"X8" CONTINUOUS KEYED FOOTING. BOTTOM OF FOOTING TO BE 4'-0" MINIMUM BELOW GRADE. SOIL CONDITION SEE NOTE 1.
 - BASEMENT FLOOR-MINIMUM 4" CONCRETE (3,500 PSI)
 - GARAGE FLOOR- MINIMUM 4" CONCRETE (3,500PSI) WITH WELDED WIRE FABRIC REINFORCEMENT. FLOOR TO PITCH 2" TOWARD OVERHEAD GARAGE DOOR'
 - ANCHOR BOLTS 12" FROM CORNERS AND 6'-0" ON CENTER.
 - ONE #4 REBAR WITHIN 12" OF THE TOP OF THE WALL STORY AND ONE #4 BAR NEAR MID-HEIGHT OF THE WALL STORY (TABLE R404.1.2(O) 2015 INTERNATIONAL RESIDENTIAL BUILDING CODE)

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MICHAEL J. BURKE P.E.
299 SALISBURY ST.
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UNIT 'B'
HIGGINS FARM AT
SALISBURY HILL

FOUNDATION PLAN
PORTAL FRAME
DETAILS




UNIT 'B' GR

DATE: 9/21/2022 R5/5
SCALE: 1/4" = 1'-0"
DRAWN BY: RCS
CHECKED BY: MJB

Sheet 2 OF 5

2


TYPICAL BUILDING SECTION

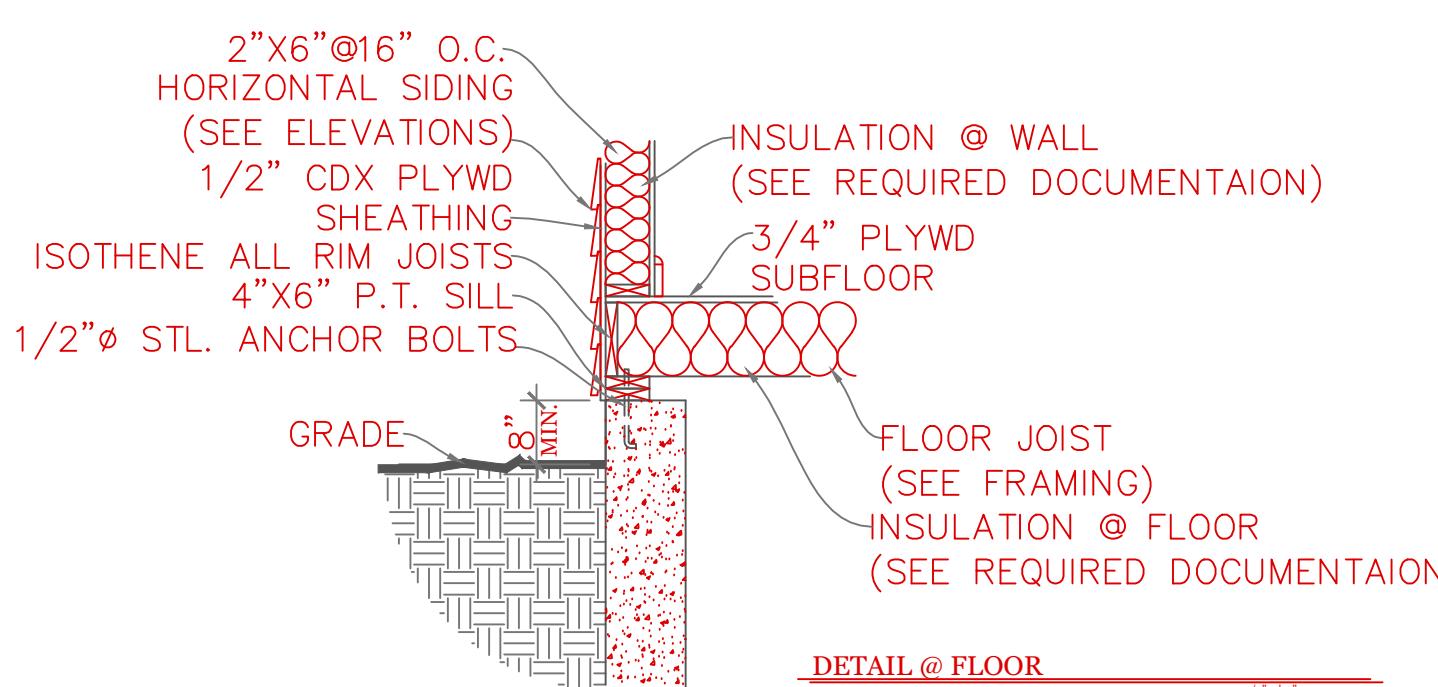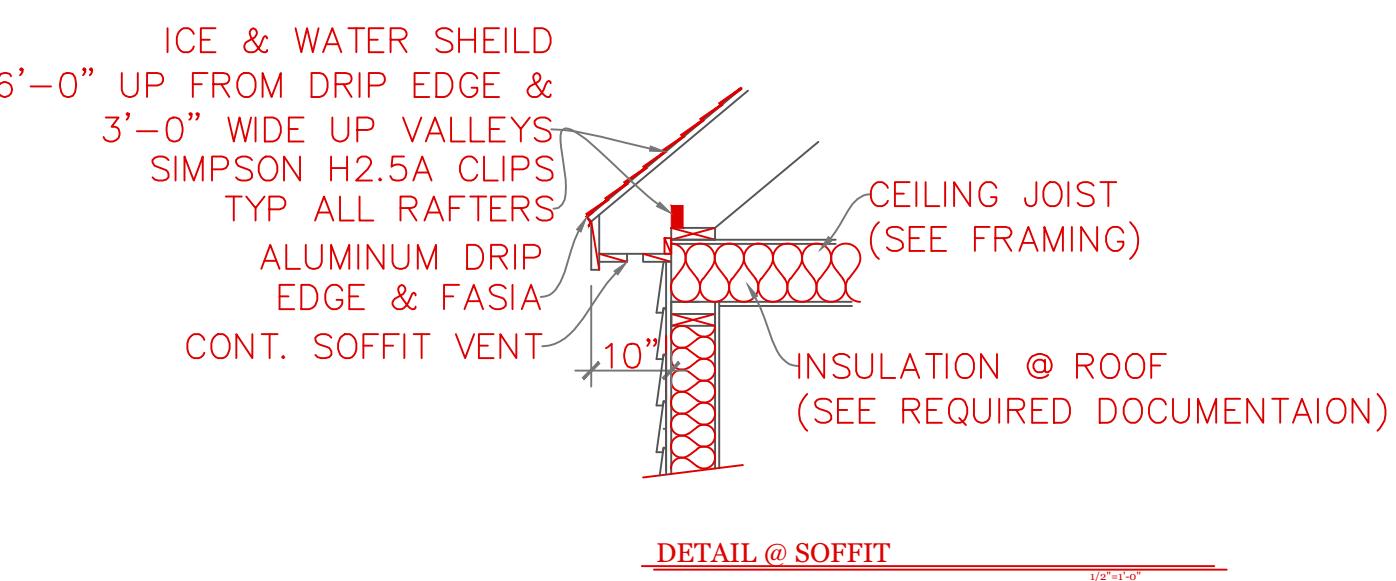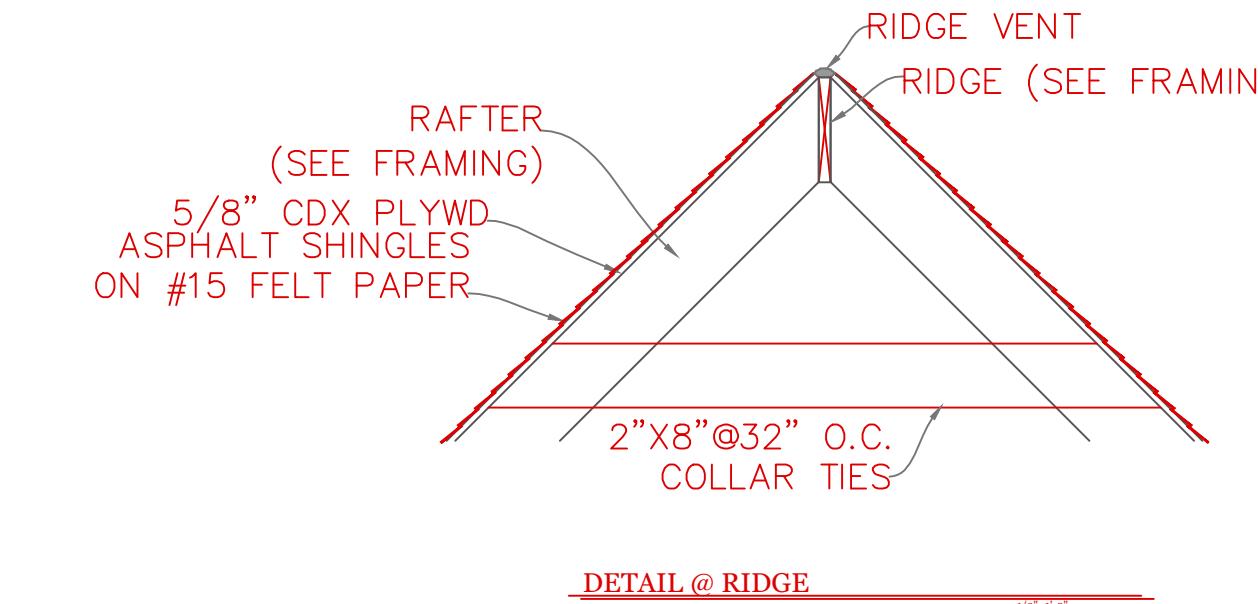

CONSTRUCTION SCHEDULE:		(UNLESS NOTED OTHERWISE ON PLAN)
1	RIDGE BOARD:	SEE FRAMING W/ RIDGE VENT
2	ROOF MATERIAL:	ASPHALT SHINGLES ON 15# ROOF FELT
3	ROOF SHEATHING	1/2" O.S.B. w/ 15# ROOF FELT
4	ROOF RAFTER:	SEE FRAMING
5	COLLAR TIES:	1X8 @ 32" O.C.
6	DRIP EDGE	ALUMINUM DRIP EDGE
7	SOFFIT:	CONT. SOFFIT VENT
8	CEILING JOIST	SEE FRAMING
9	ATTIC INSULATION	R-38
10	EXT WALL:	2"X6" @ 16" O.C.
11	EXT. SHEATHING	1/2" O.S.B. w/ HOUSE WRAP
12	EXT. FINISH	SEE ELEVATIONS
13	INSULATION@WALL	R-21
14	INTERIOR WALL	2"X4" @16"O.C.
15	SUB FLOOR:	3/4" ADVANTEK GLUED & NAILED
16	JOIST:	SEE FRAMING.
17	SILL:	2"X6" P.T. SILL W/ 2X6 KD TOP PLATE
18	INSULATION @ FLOOR	R-30
19	ANCHOR:	1/2" Ø STL ANCHOR BOLTS
20	BEAM:	SEE FRAMING PLAN
21	COLUMN:	3 1/2" L.C.
22	FND. WALL:	10"X7'-10" CONC. WALL
23	SLAB:	SEE FOUNDATION NOTES
24	FOOTING:	20"X10" CONT. KEYED FTNG
25	CONC. PAD:	30"X30"X15" CONC. PAD

NOTES: -ISOTHEENE ALL RIM JOISTS (OPTIONAL)
-ICE & WATER SHEILD 6'-0" UP FROM DRIP EDGE & 3'-0" WIDE UP VALLEYS

DUPLEX BUILDING ONLY

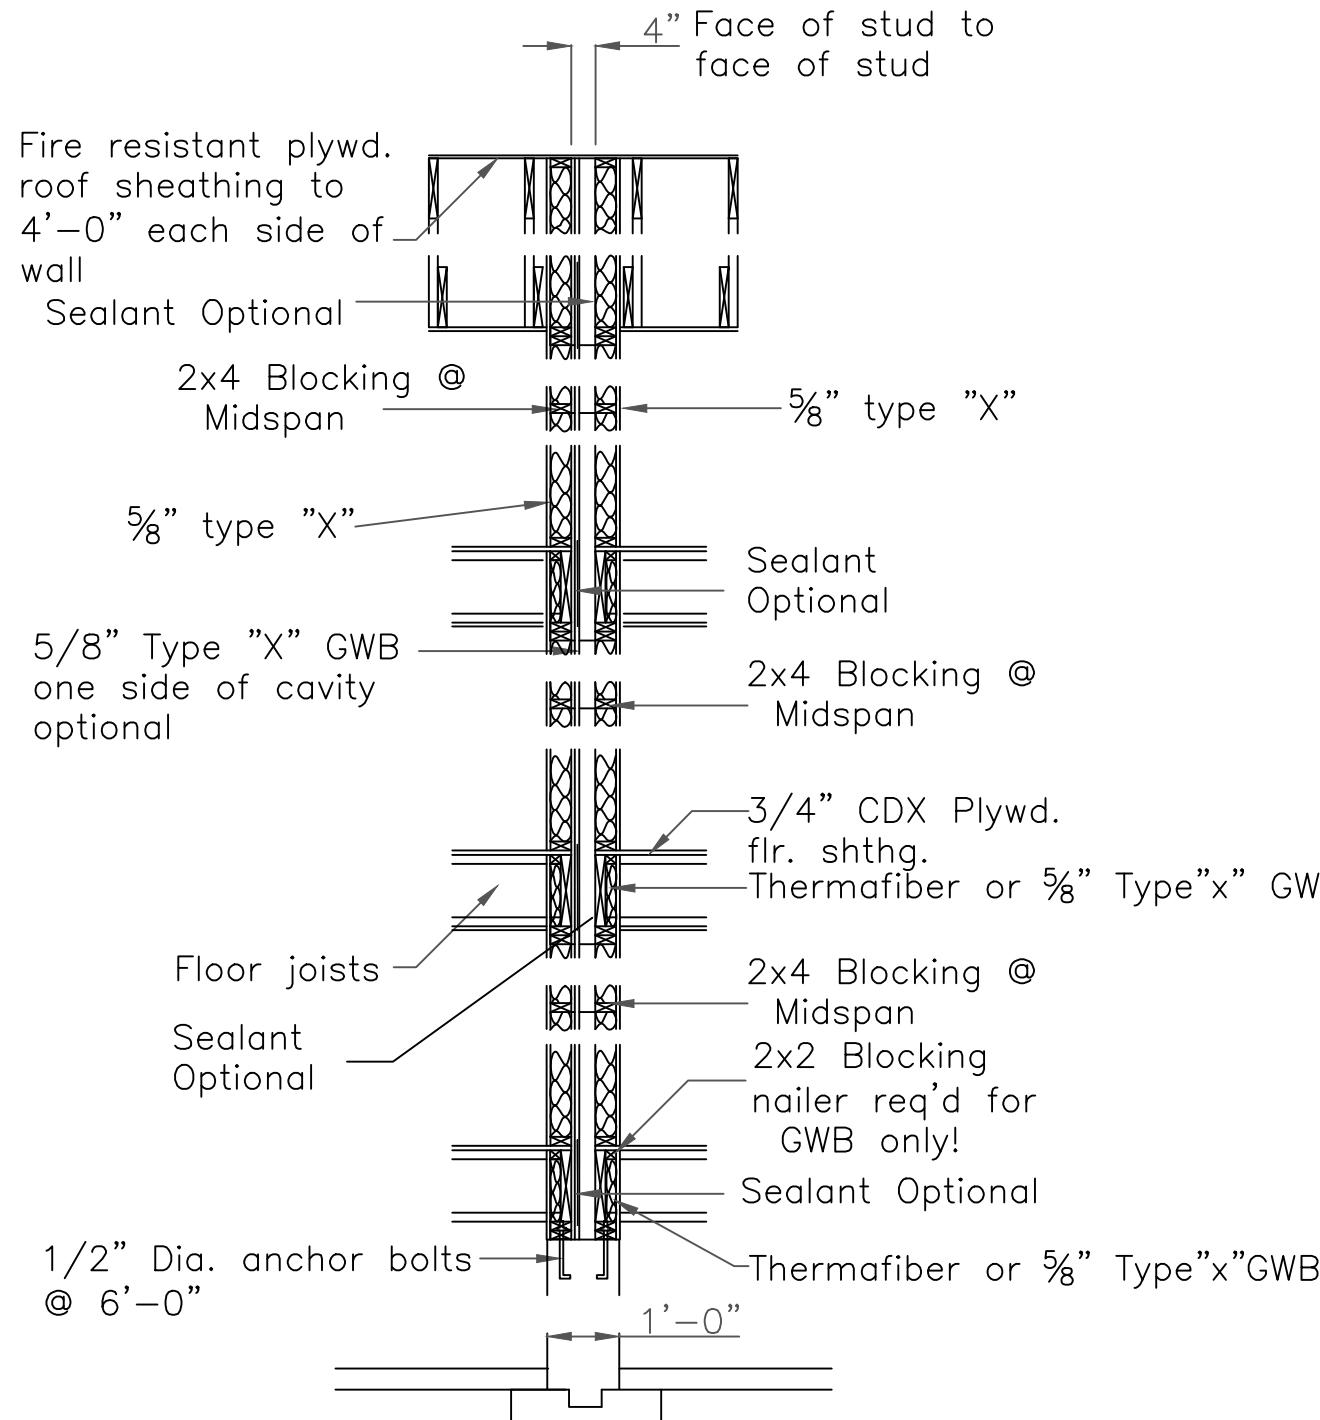

A Fire Resistance Rated Wall Section



For more information see U.L. LISTING --- U-305
STC Rating = 56
Bearing wall Rating = 1 HR.
3/8"-1'-0"

TABLE 402.1.2
INSULATION AND FENESTRATION REQUIREMENTS BY COMPONENT^a

CLIMATE ZONE	FENESTRATION U-FACTOR ^b	SKYLIGHT ^b U-FACTOR	GLAZED FENESTRATION SHGC ^{c,e}	CEILING R-VALUE	WOOD FRAME WALL R-VALUE	MASS WALL R-VALUE	FLOOR R-VALUE	BASEMENT ^c WALL R-VALUE	SLAB ^d R-VALUE & DEPTH	CRAWL SPACE ^c WALL R-VALUE
5 and Marine 4	0.30	0.55	NR	49	20 or 13+5 ^h	13/17	30g	15/19	10, 2 ft	15/19


2018 INTERNATIONAL ENERGY CONSERVATION CODE® AND MASSACHUSETTES 780 CMR 9TH EDITION

- For SI: 1 foot = 304.8 mm.
a. R-values are minimums. U-factors and SHGC are maximums. R-19 batts compressed into a nominal 2 x 6 framing cavity such that the R-value is reduced by R-1 or more shall be marked with the compressed batt R-value in addition to the full thickness R-value.
b. The fenestration U-factor column excludes skylights. The SHGC column applies to all glazed fenestration.
c. "15/19" means R-15 continuous insulated sheathing on the interior or exterior of the home or R-19 cavity insulation at the interior of the basement wall. "15/19" shall be permitted to be met with R-13 cavity insulation on the interior of the basement wall plus R-5 continuous insulated sheathing on the interior or exterior of the home. "10/15" means R-10 continuous insulated sheathing on the interior or exterior of the home or R-13 cavity insulation at the interior of the basement wall.
d. R-5 shall be added to the required slab edge R-values for heated slabs. Insulation depth shall be the depth of the footing or 2 feet, whichever is less in Zones 1 through 3 for heated slabs.
e. There are no SHGC requirements in the Marine Zone.
f. Basement wall insulation is not required in warm-humid locations as defined by Figure 301.1 and Table 301.1.
g. Insulation sufficient to fill the framing cavity, R-19 minimum.
h. "13+5" means R-13 cavity insulation plus R-5 insulated sheathing. If structural sheathing covers 25 percent or less of the exterior insulating sheathing is not required where structural sheathing is used. If structural sheathing covers more than 25 percent of exterior, structural sheathing shall be supplemented with insulated sheathing at least R-2.
i. The second R-value applies when more than half the insulation is on the interior of the mass wall.
j. For impact rated fenestration complying with Section R301.21.2 of the International Residential Code or Section 1608.1.2 of the International Building Code, the maximum U-factor shall be 0.75 in Zone 2 and 0.65 in Zone 3.

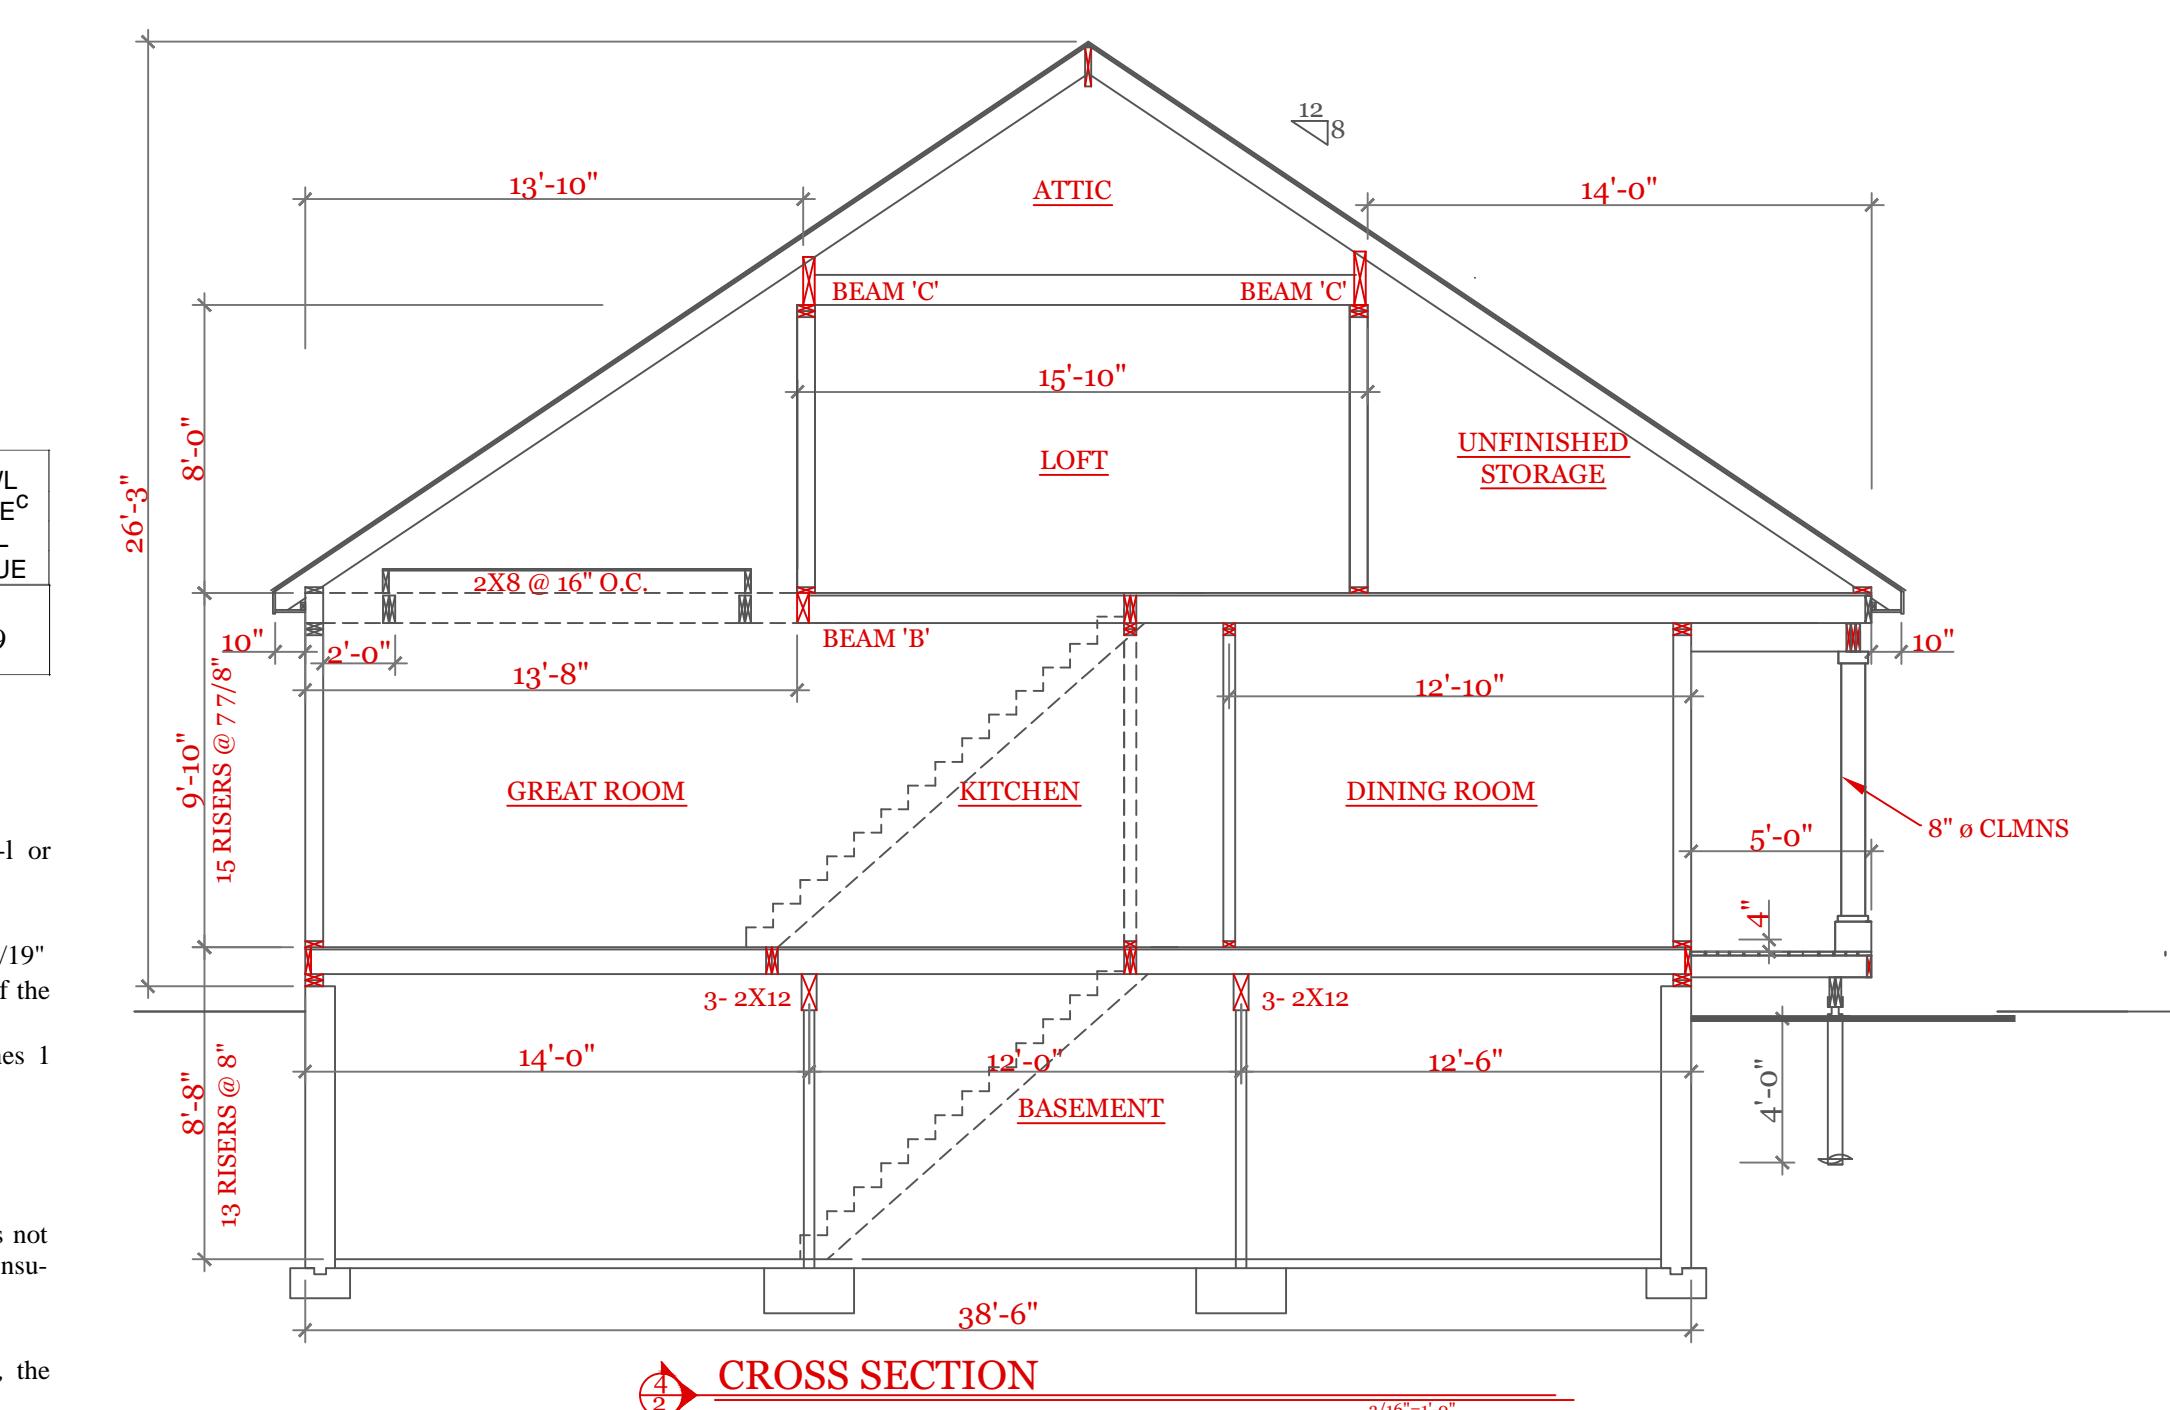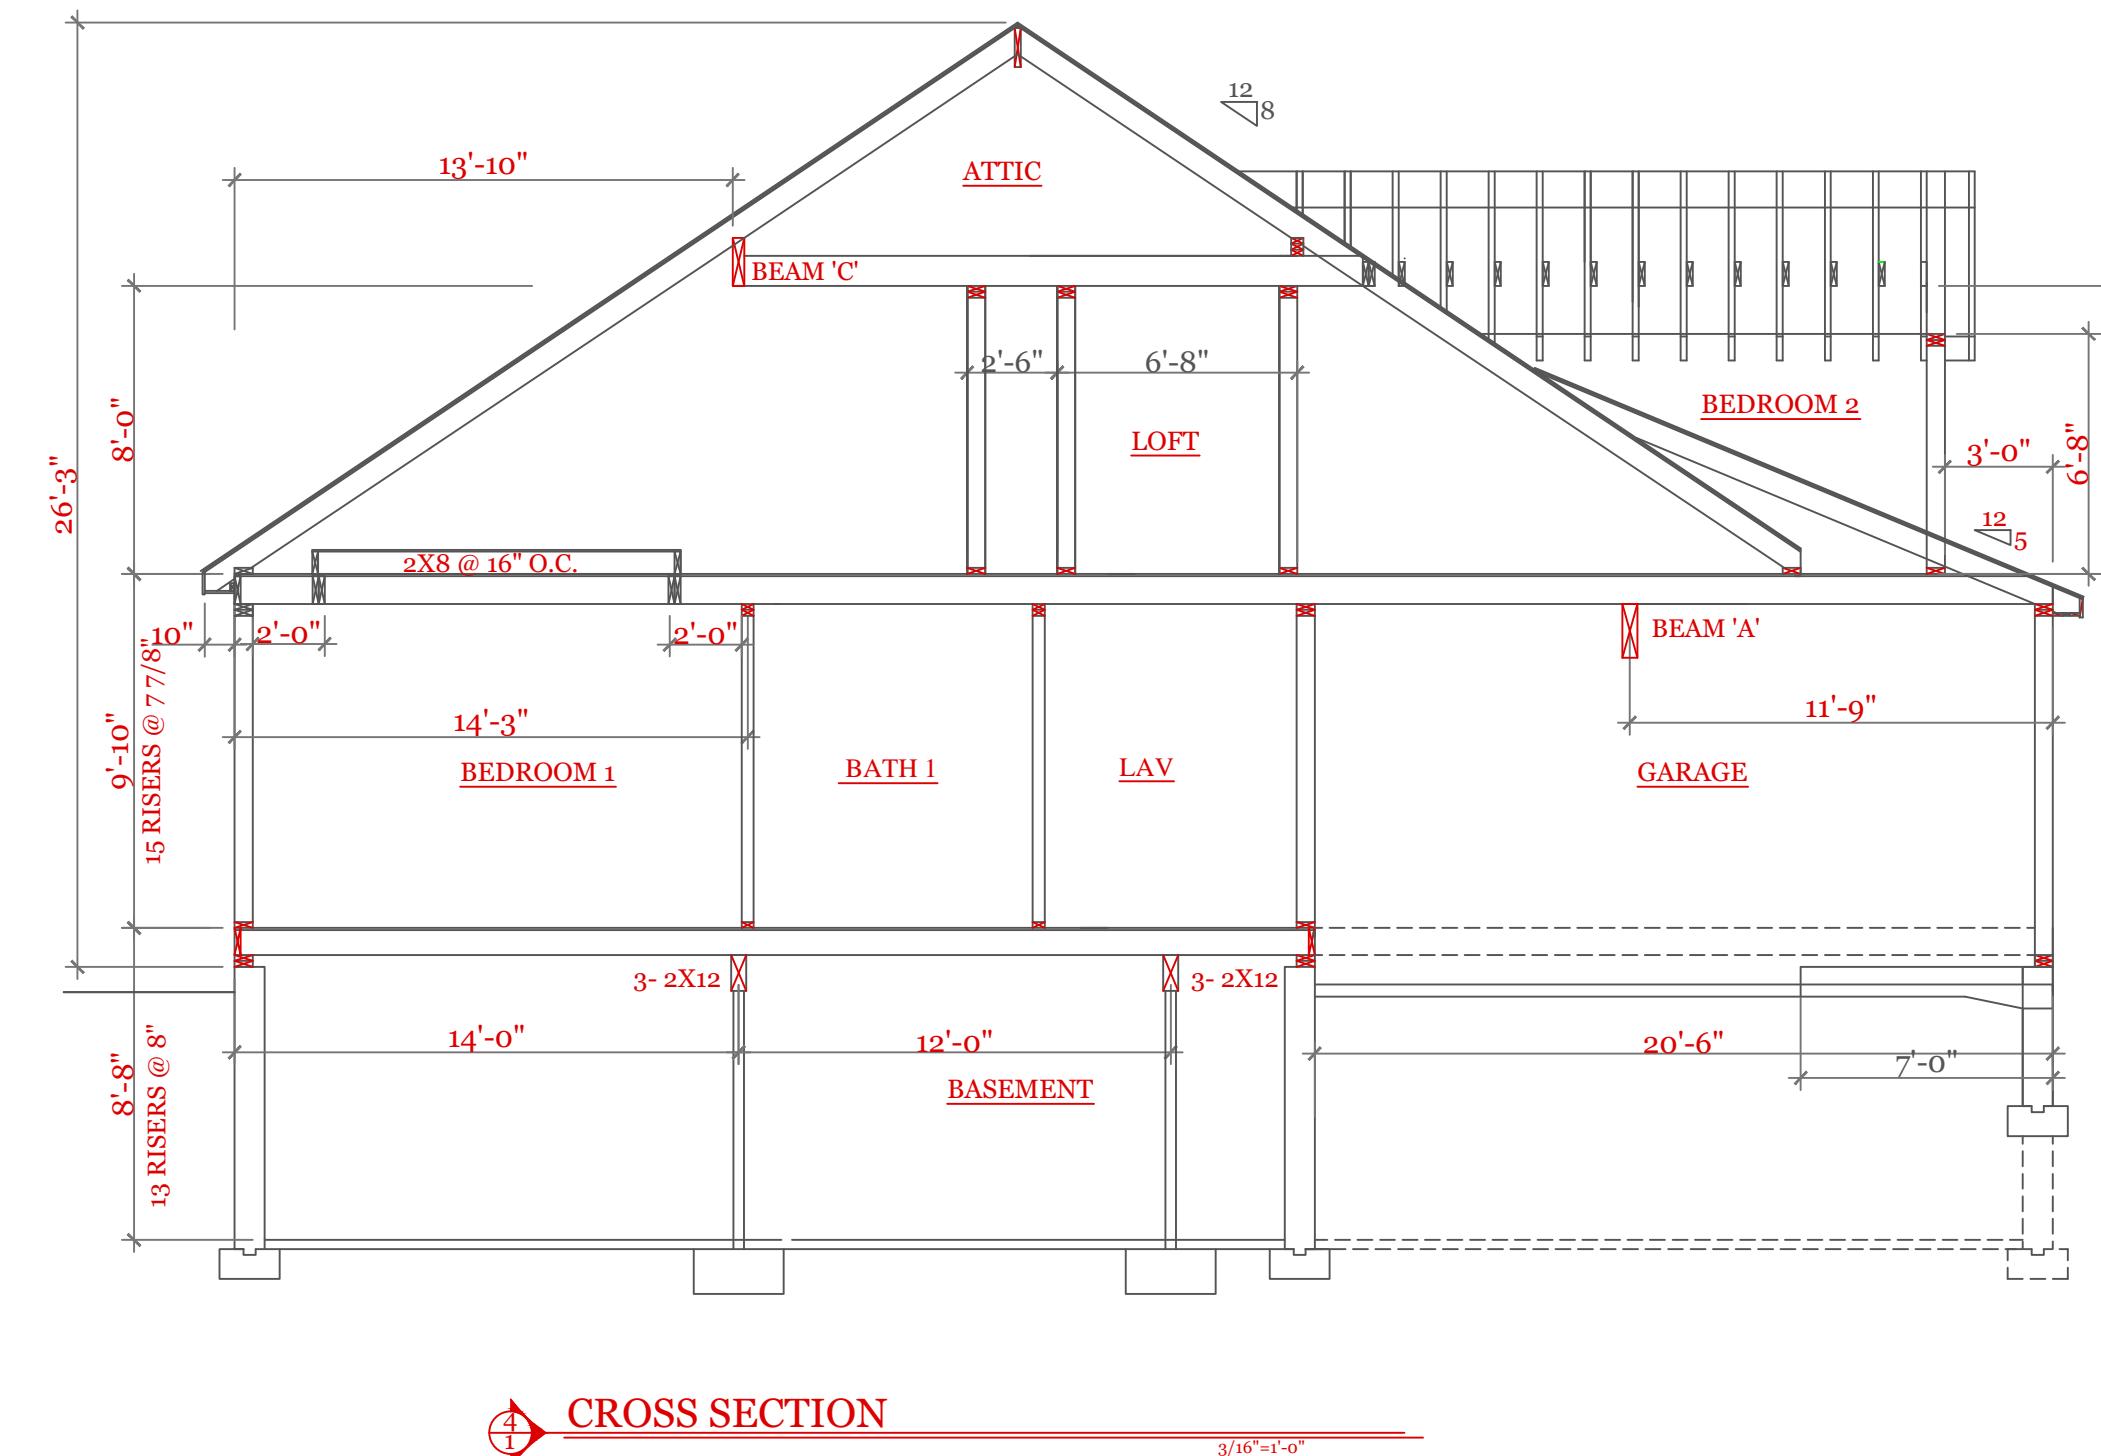

DESIGN CRITERIA											
GROUND SNOW LOAD	WIND SPEED (MPH)	SEISMIC DESIGN	WEATHERING	FROST LINE DEPTH	TERMITES	DECAY	WINTER DESIGN TEMP	ICE SHIELD UNDERLAYMENT REQUIRED	FLOOD HAZARD	AIR FREEZING INDEX	MEAN ANNUAL TEMP
TABLE 5301.2(5)	TABLE 5301.2(4)	N/A	FIGURE 5301.2(3)	4 ft. minimum unless engineered data shows otherwise	FIGURE 5301.2(6)	FIGURE 5301.2(7)	APPENDIX 780 CMR 120.J TABLE 120.J.3.2.1	As required by the exterior roof covering manufacturer; roof pitch and local climate must also be considered	Refer to applicable Flood Insurance Rate Map (FIRM)	Only utilized in the design and construction of frost protected shallow foundations	Only utilized in the design and construction of frost protected shallow foundations

50 psf 124 mph N/A SEVERE \$5403.1.4 MODERATE TO HEAVY SLIGHT TO MODERATE N/A \$5905.0 SEE NOTE J FIRM MAPS SEE NOTE K TABLE 5301.2(1) SEE NOTE K TABLE 5301.2(1)

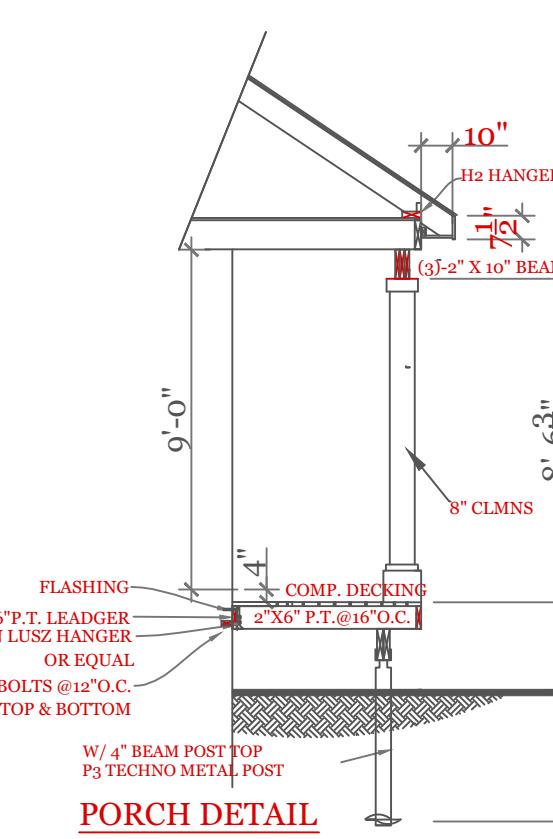

NOTES:


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Exclusive Home Designers
Design / Build
17 Glenwood St.
Holden Ma.

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UNIT 'B'
HIGGINS FARM AT SALISBURY HILL
BUILDING SECTIONS CONSTR. SCHEDULE DESIGN CRITERIA




UNIT 'B' GR
DATE: 9/21/2022 R5/5
SCALE: AS NOTED
DRAWN BY: RCS
CHECKED BY: MJB
Sheet 4 OF 5
4

NOTES:

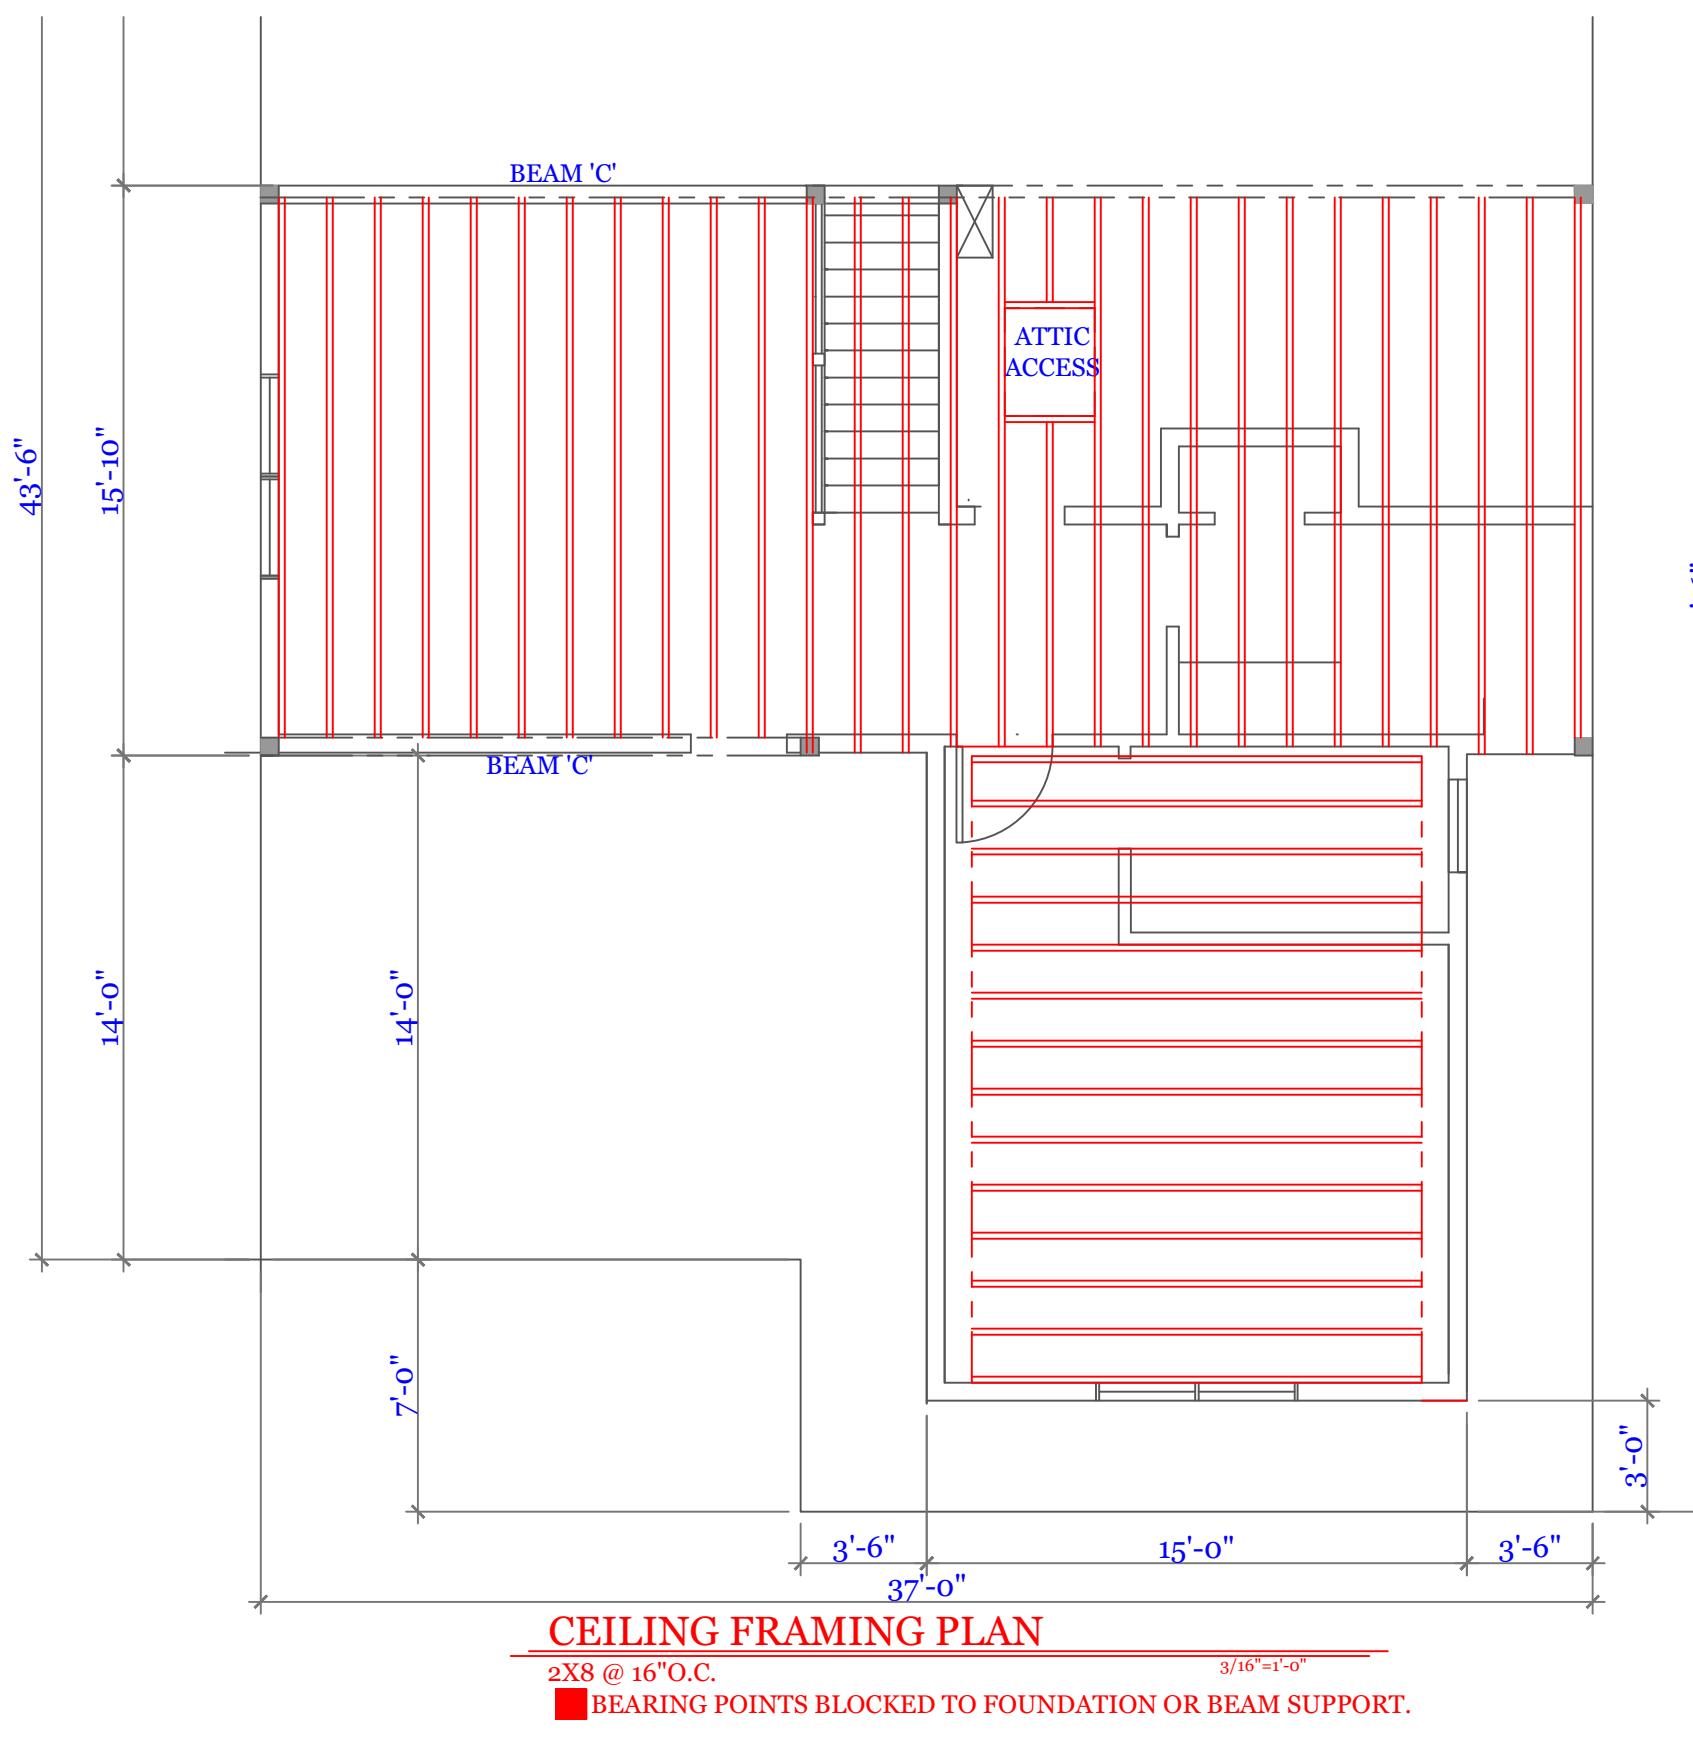

BEAM CALCULATIONS

BEAM	SIZE	SPAN	LIVE LOAD	TOTAL LOAD	MAX LIVE (PLF)	MAX TOTAL (PLF)
A	5 1/4" X 16" LVL	22'-0"	315	420	710	1021
B	3 1/2" X 11 7/8" LVL	15'-0"	390	520	442	647
C	5 1/4" X 14" LVL ROOF	18'-0"	160	790	610	896

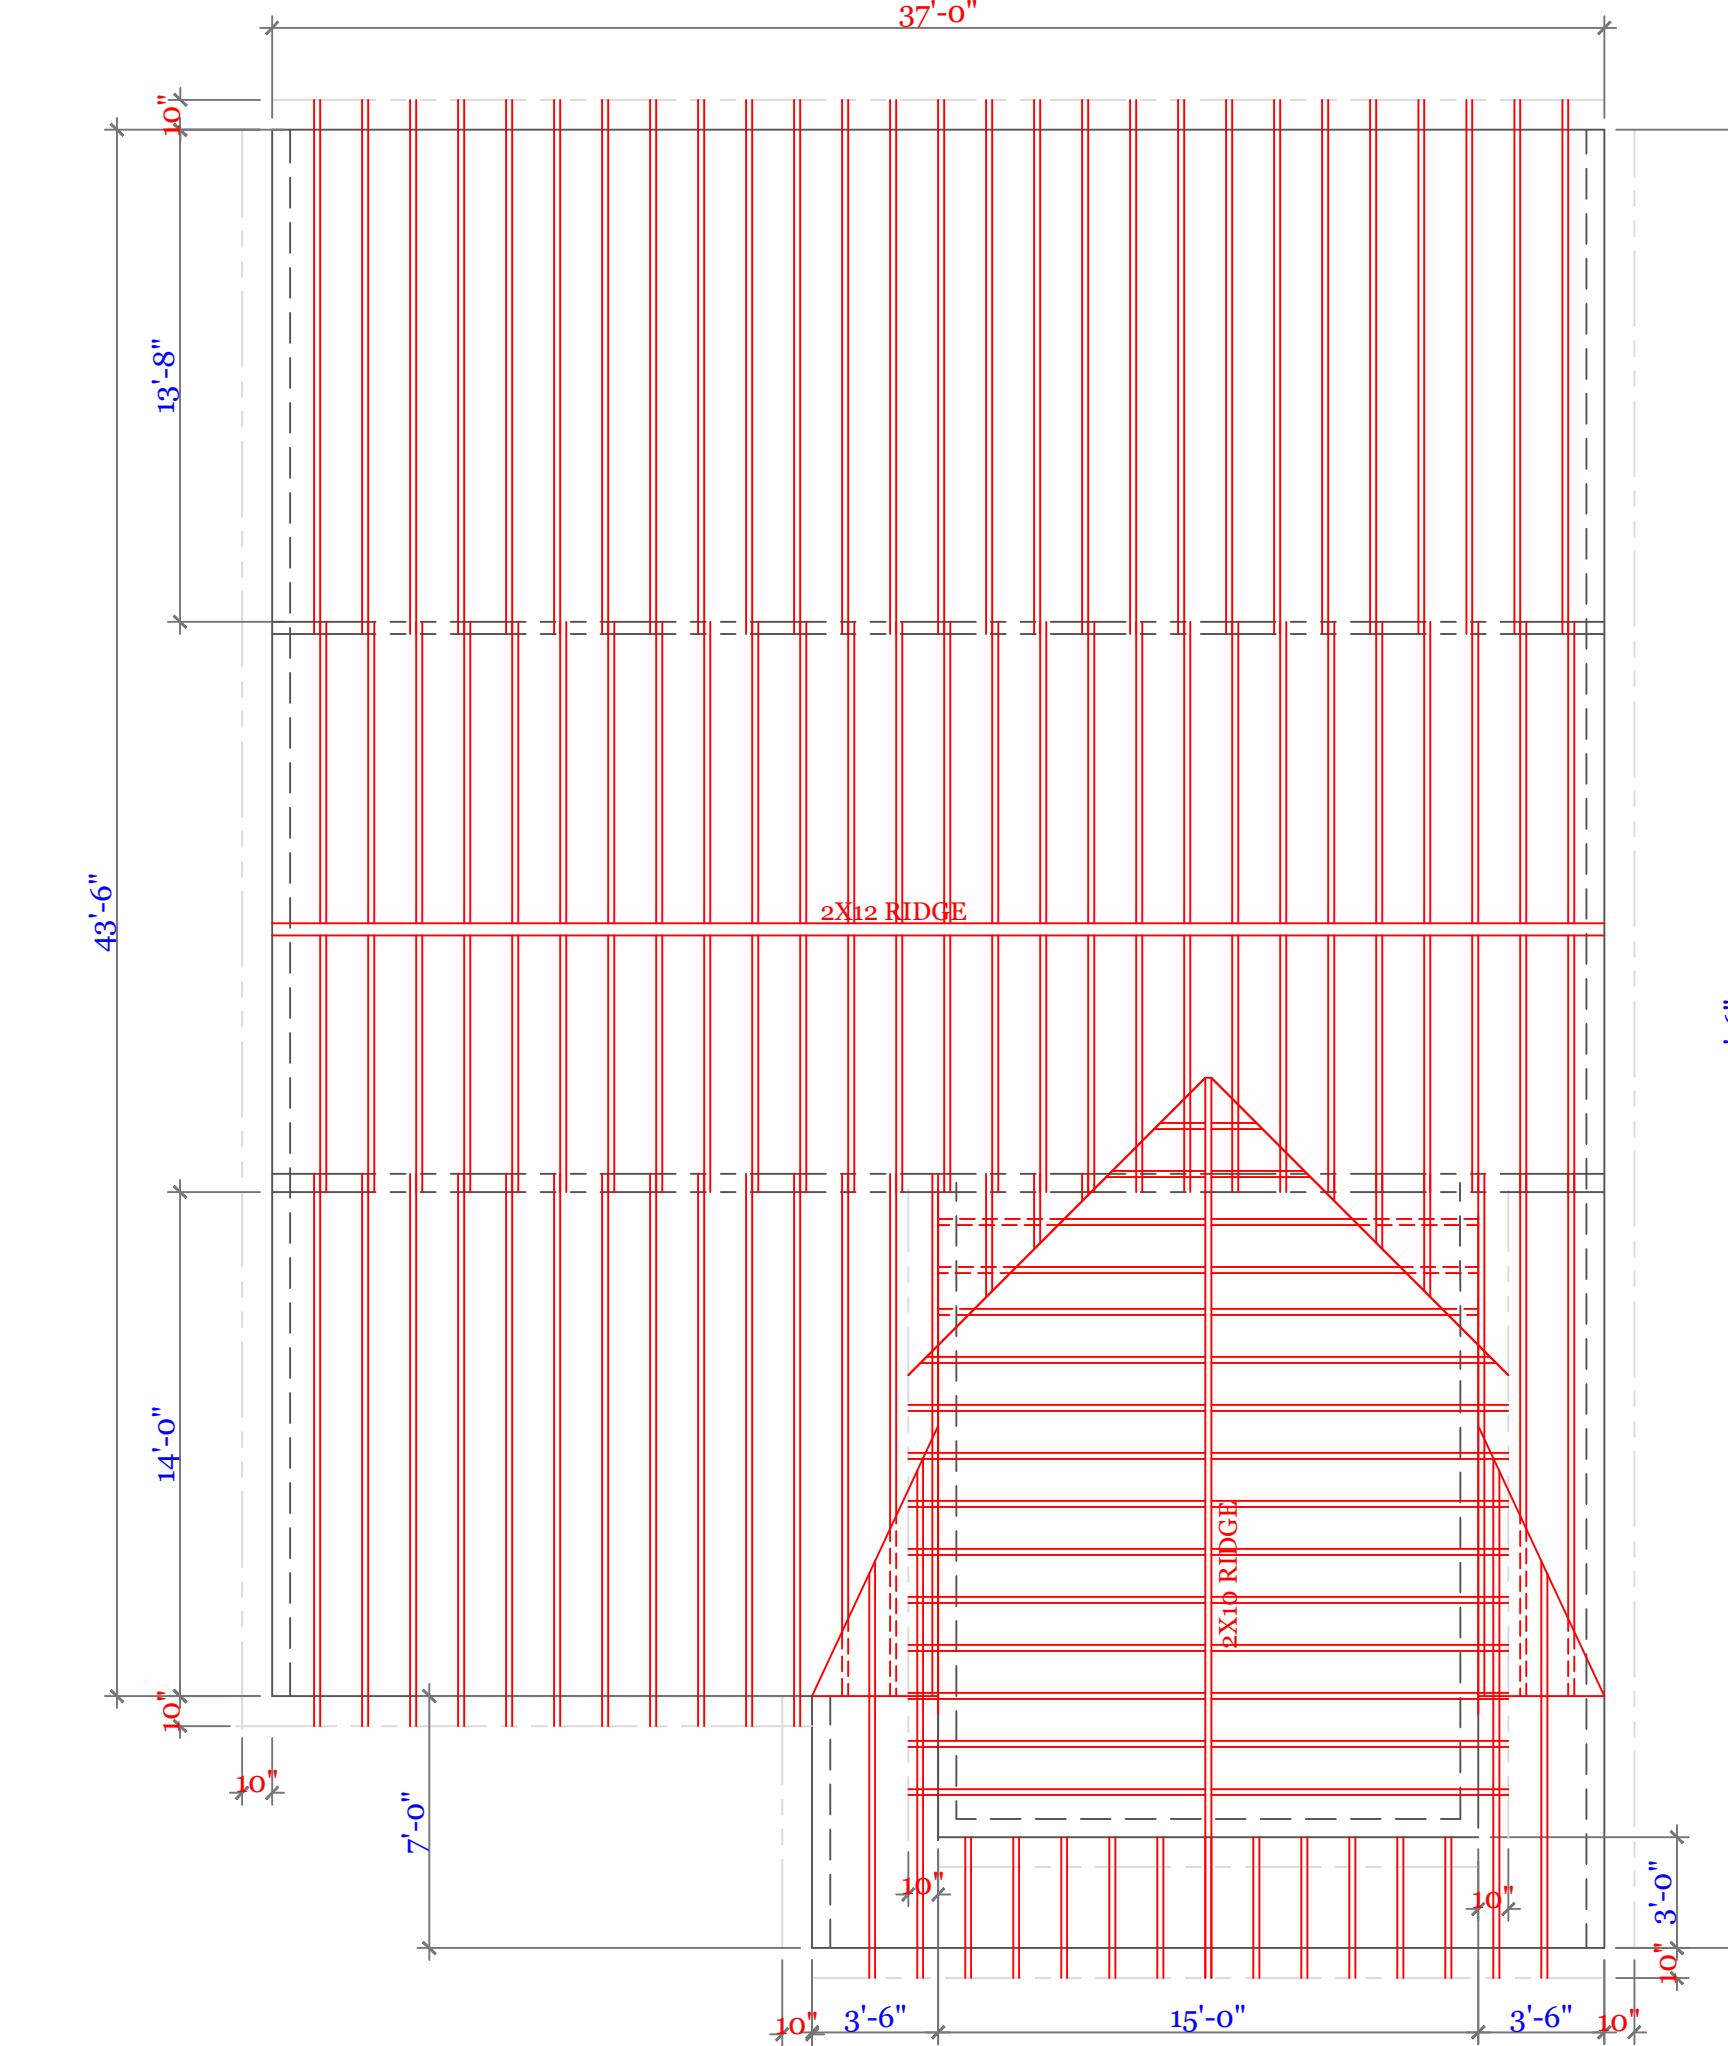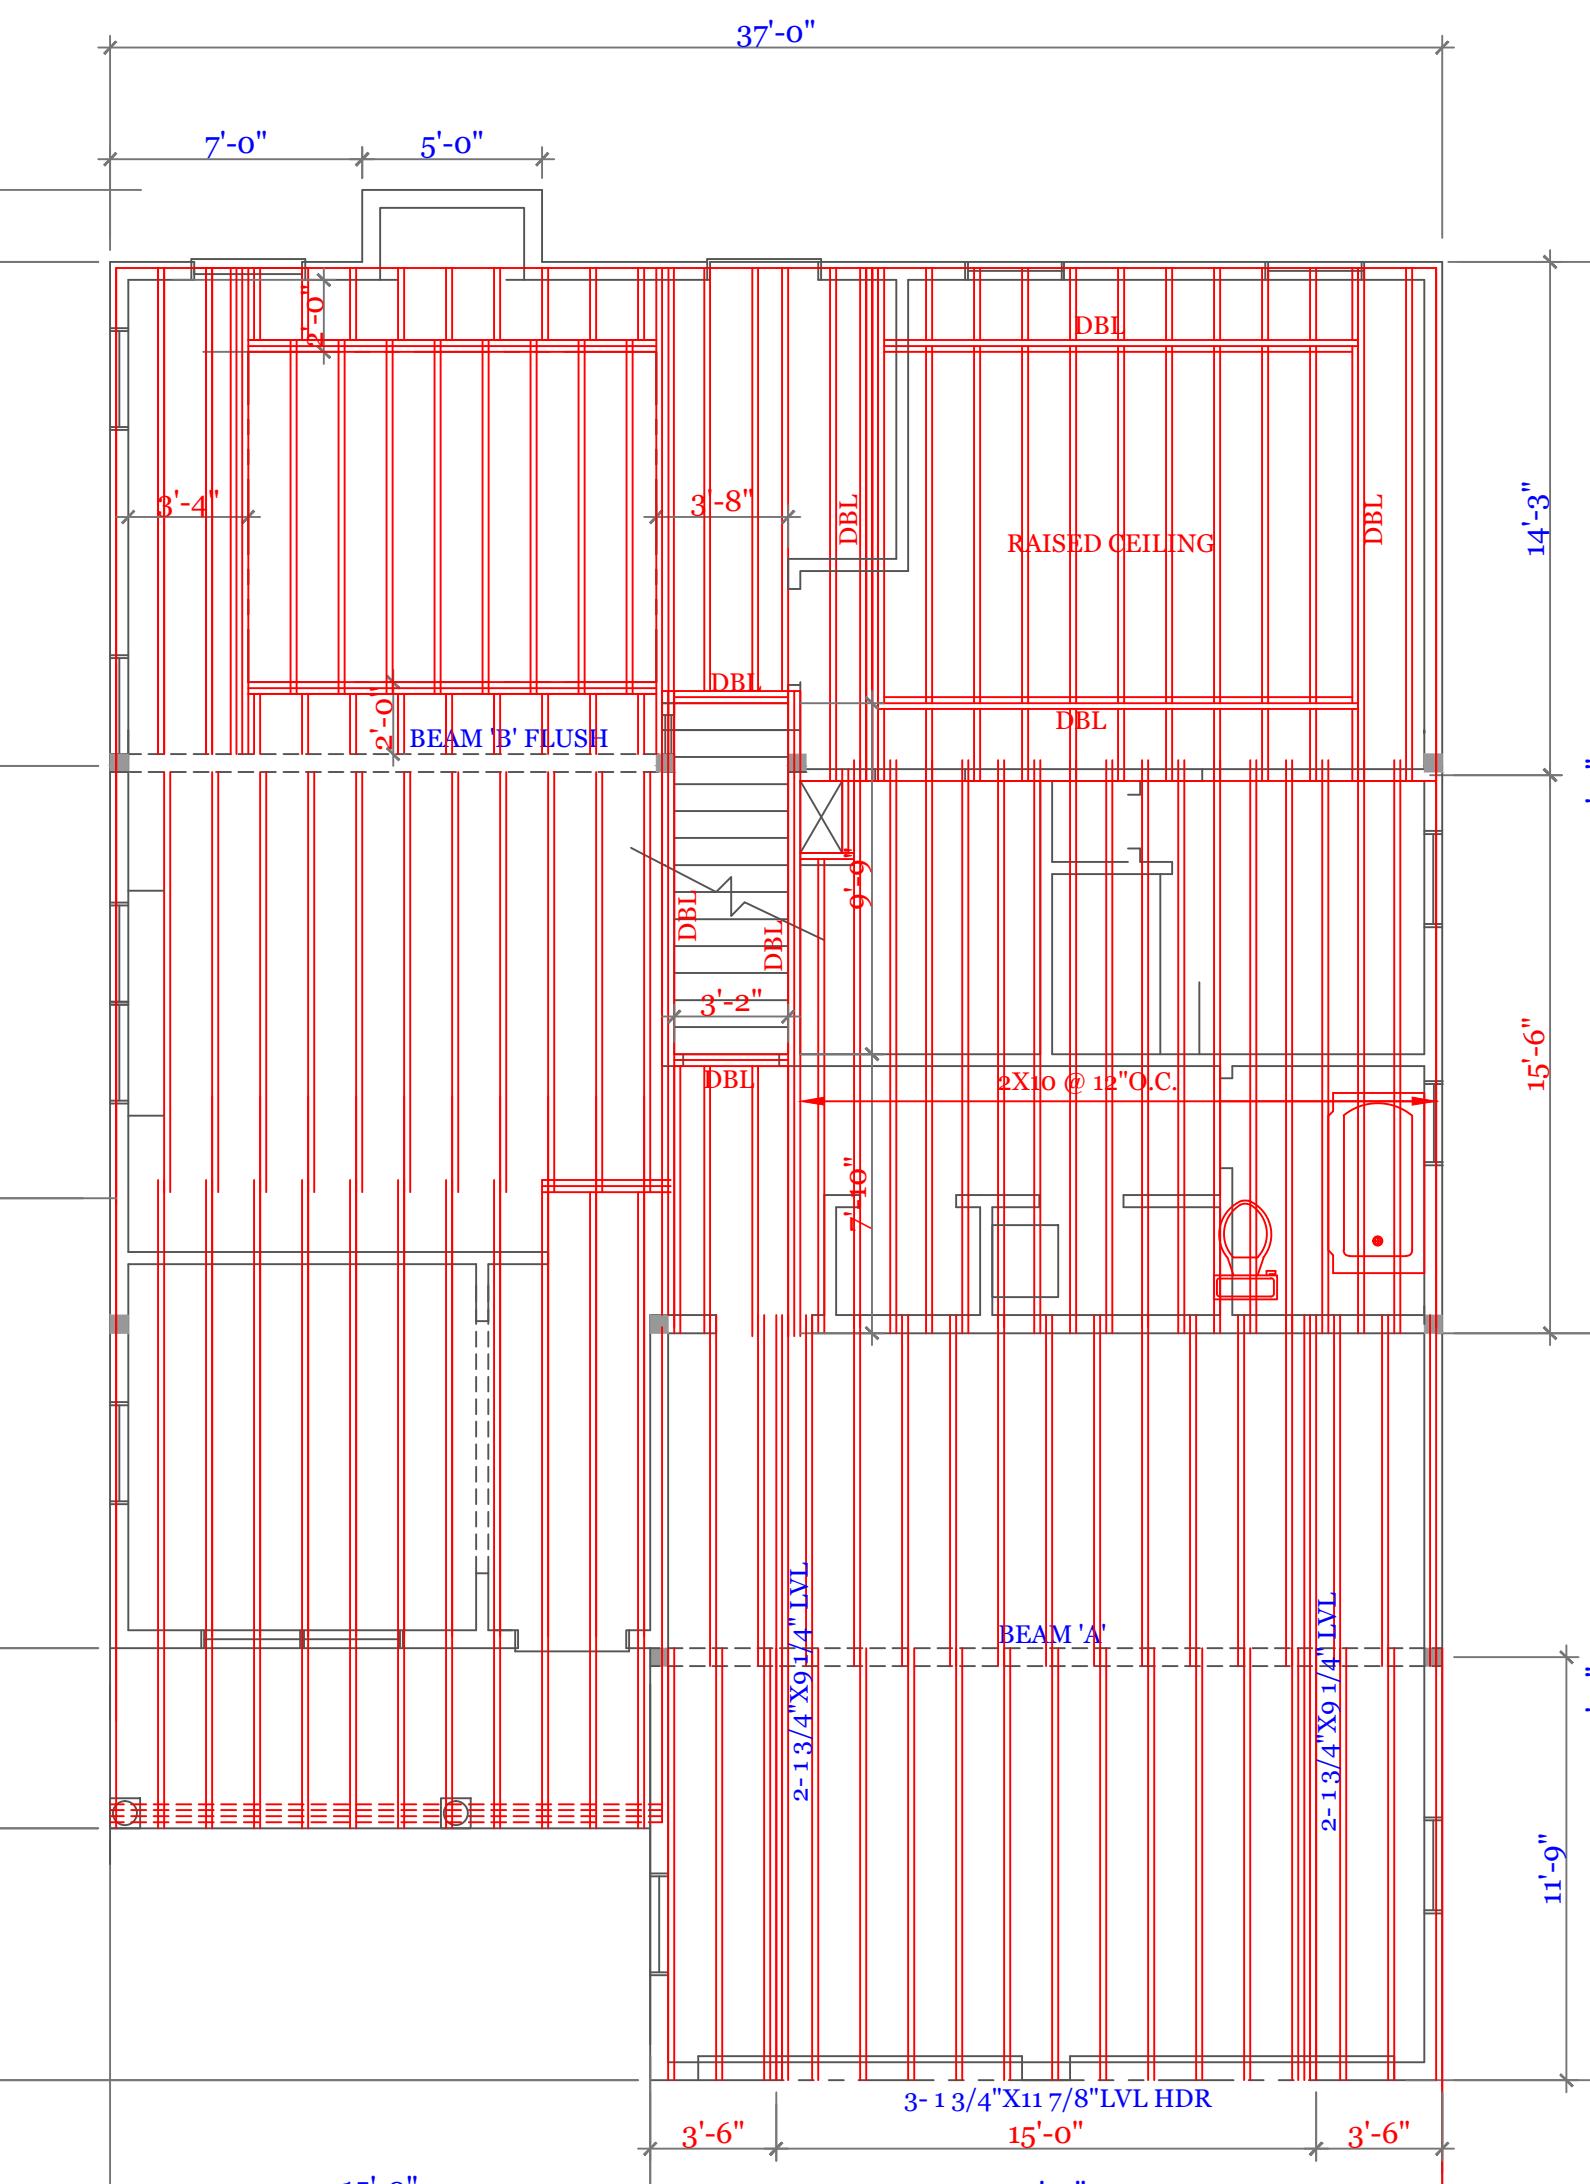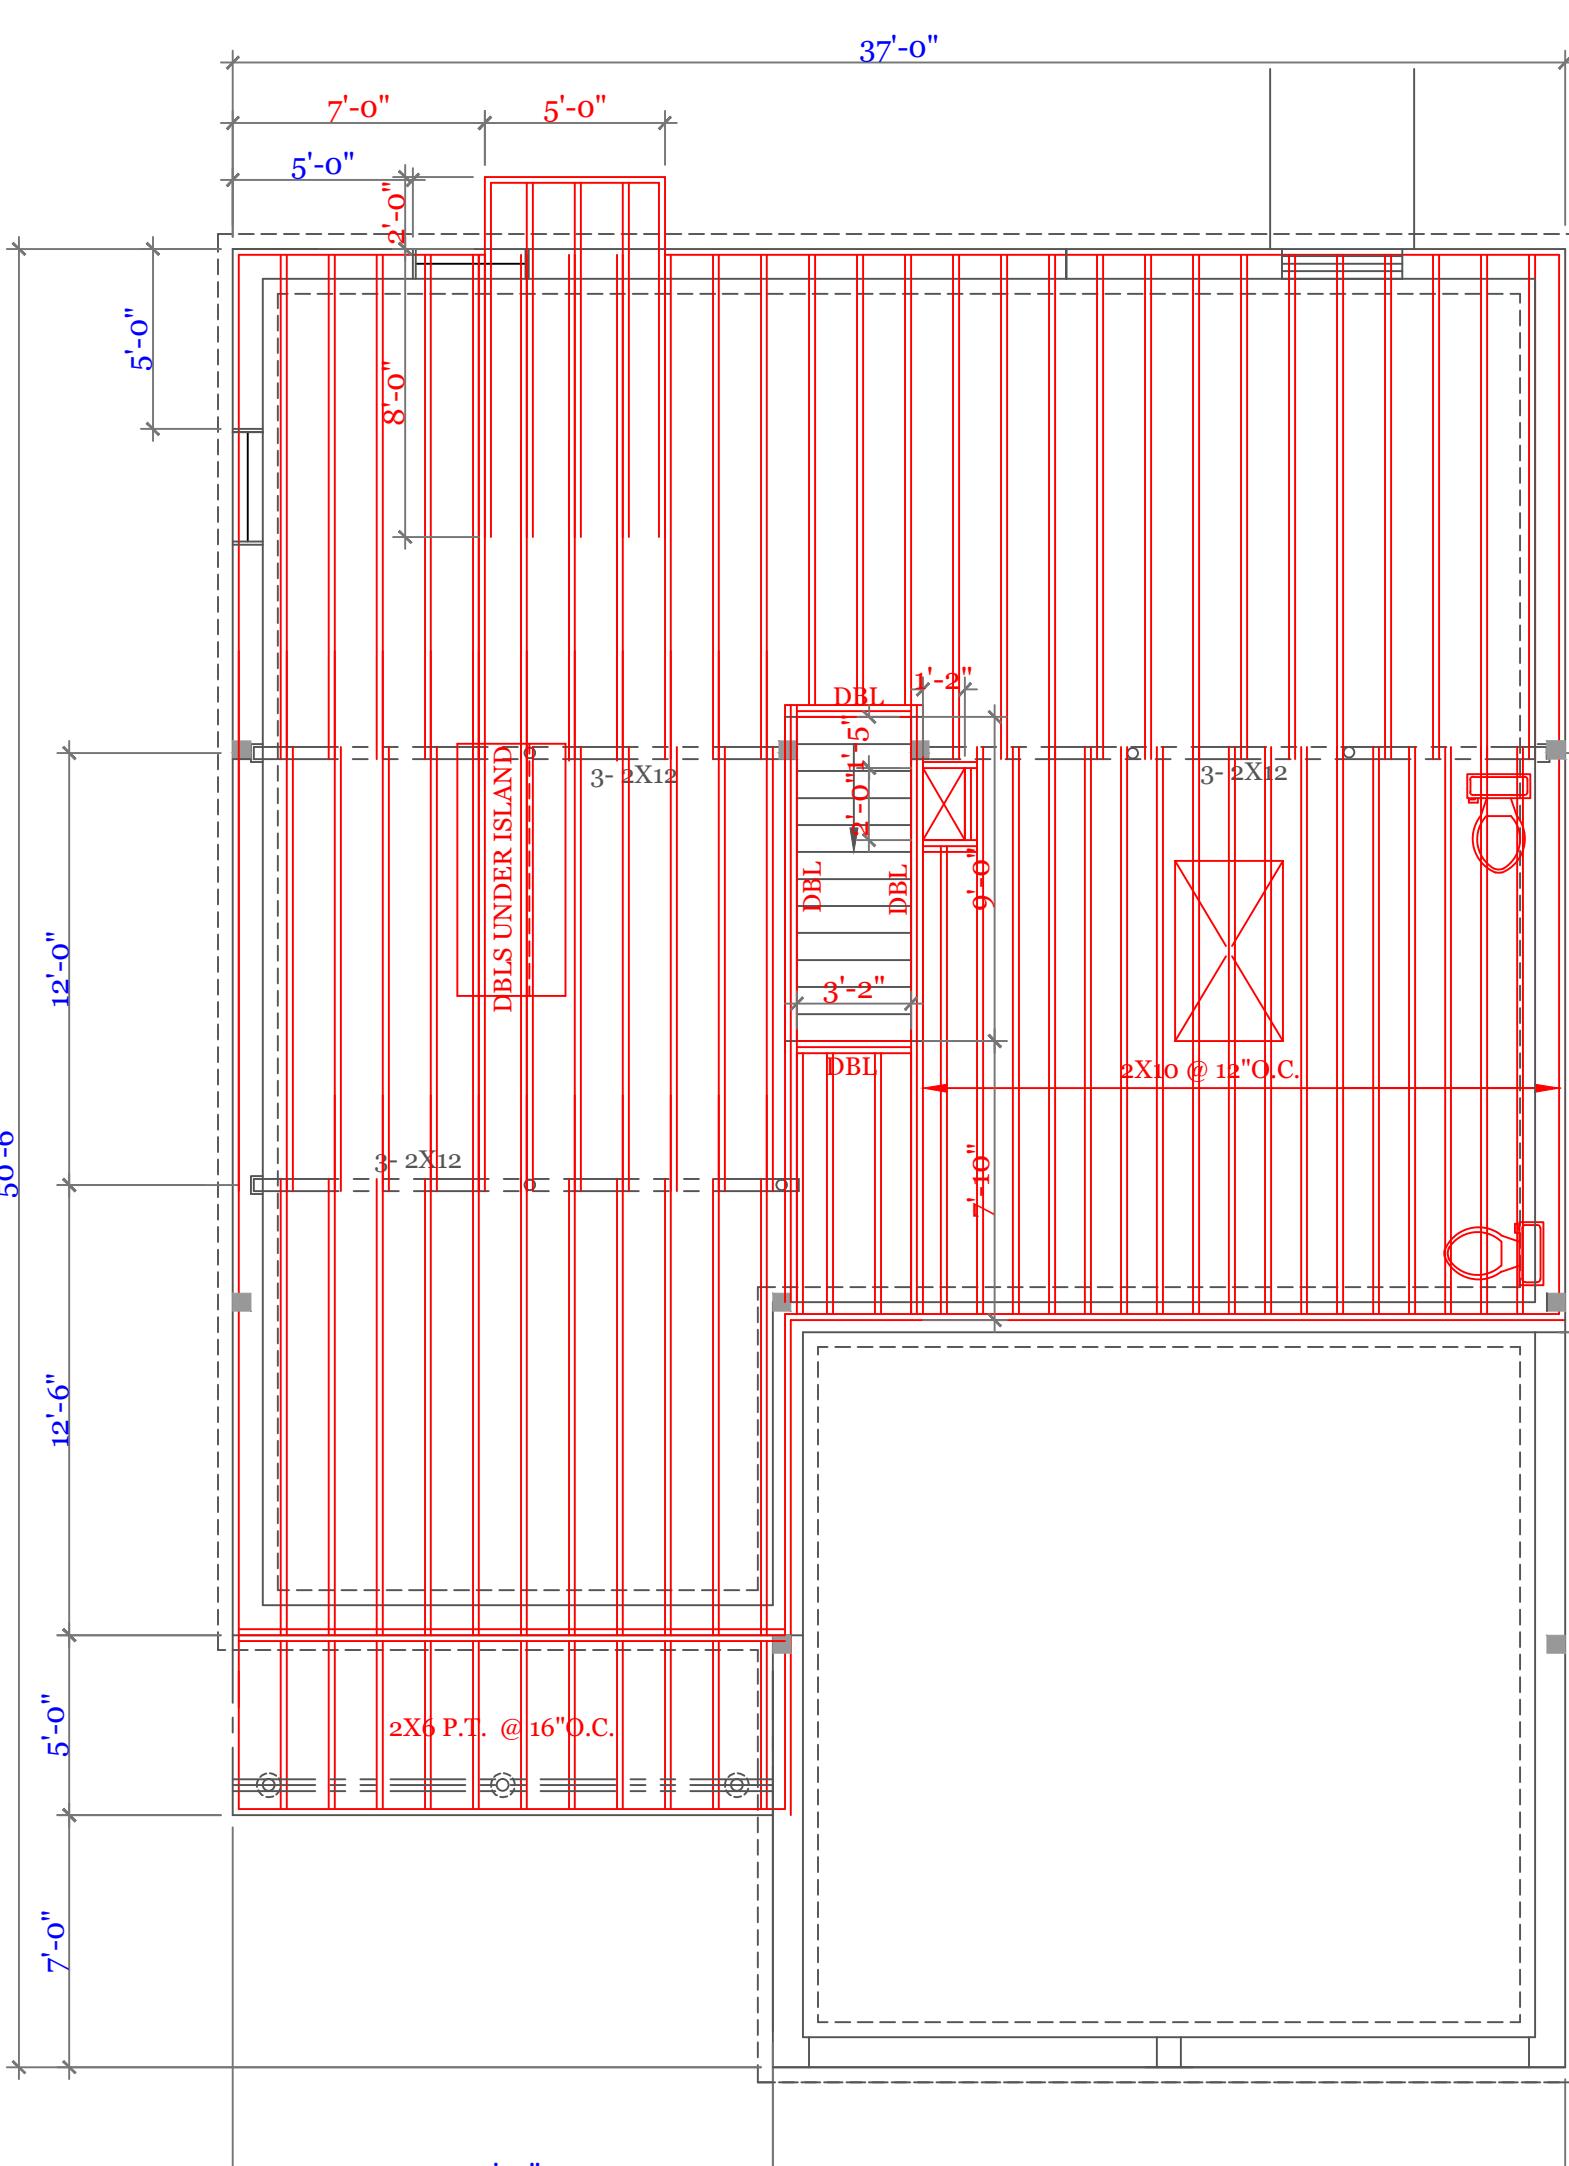

ROOF FRAMING PLAN

2X10 @ 16''O.C. MAIN ROOF
2X8 @ 16''O.C. DORMER & GARAGE
BEARING POINTS BLOCKED TO FOUNDATION OR BEAM SUPPORT.

R.C. Searles Associates

Exclusive Home Designers

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UNIT 'B'
HIGGINS FARM AT
SALISBURY HILL
FRAMING PLANS
BEAM SCHEDULE

UNIT 'B' GR

DATE: 9/21/2022 R5/8

SCALE: 3/16" = 1'-0"

DRAWN BY: RCS

CHECKED BY: MJB

Sheet 5 OF 5

5

NOTES:

GENERAL NOTES:
 1. These plans are drawn as required for construction by an experienced licensed general contractor.
 2. The General contractor shall fully comply with the 9th Edition of the Massachusetts State Building Code, IRC2015 and all additional local requirements.
 3. Written dimensions shall have precedence over scaled dimensions. The general contractor shall verify and is responsible for all dimensions (including rough openings) and conditions on the job and must notify this office of any variations from these drawings. Any defects in the construction documents shall be brought to the attention of this office before proceeding with work. Reasonable time not allowed this office to correct defects shall place the burden of cost and liability from such defects upon the contractor.

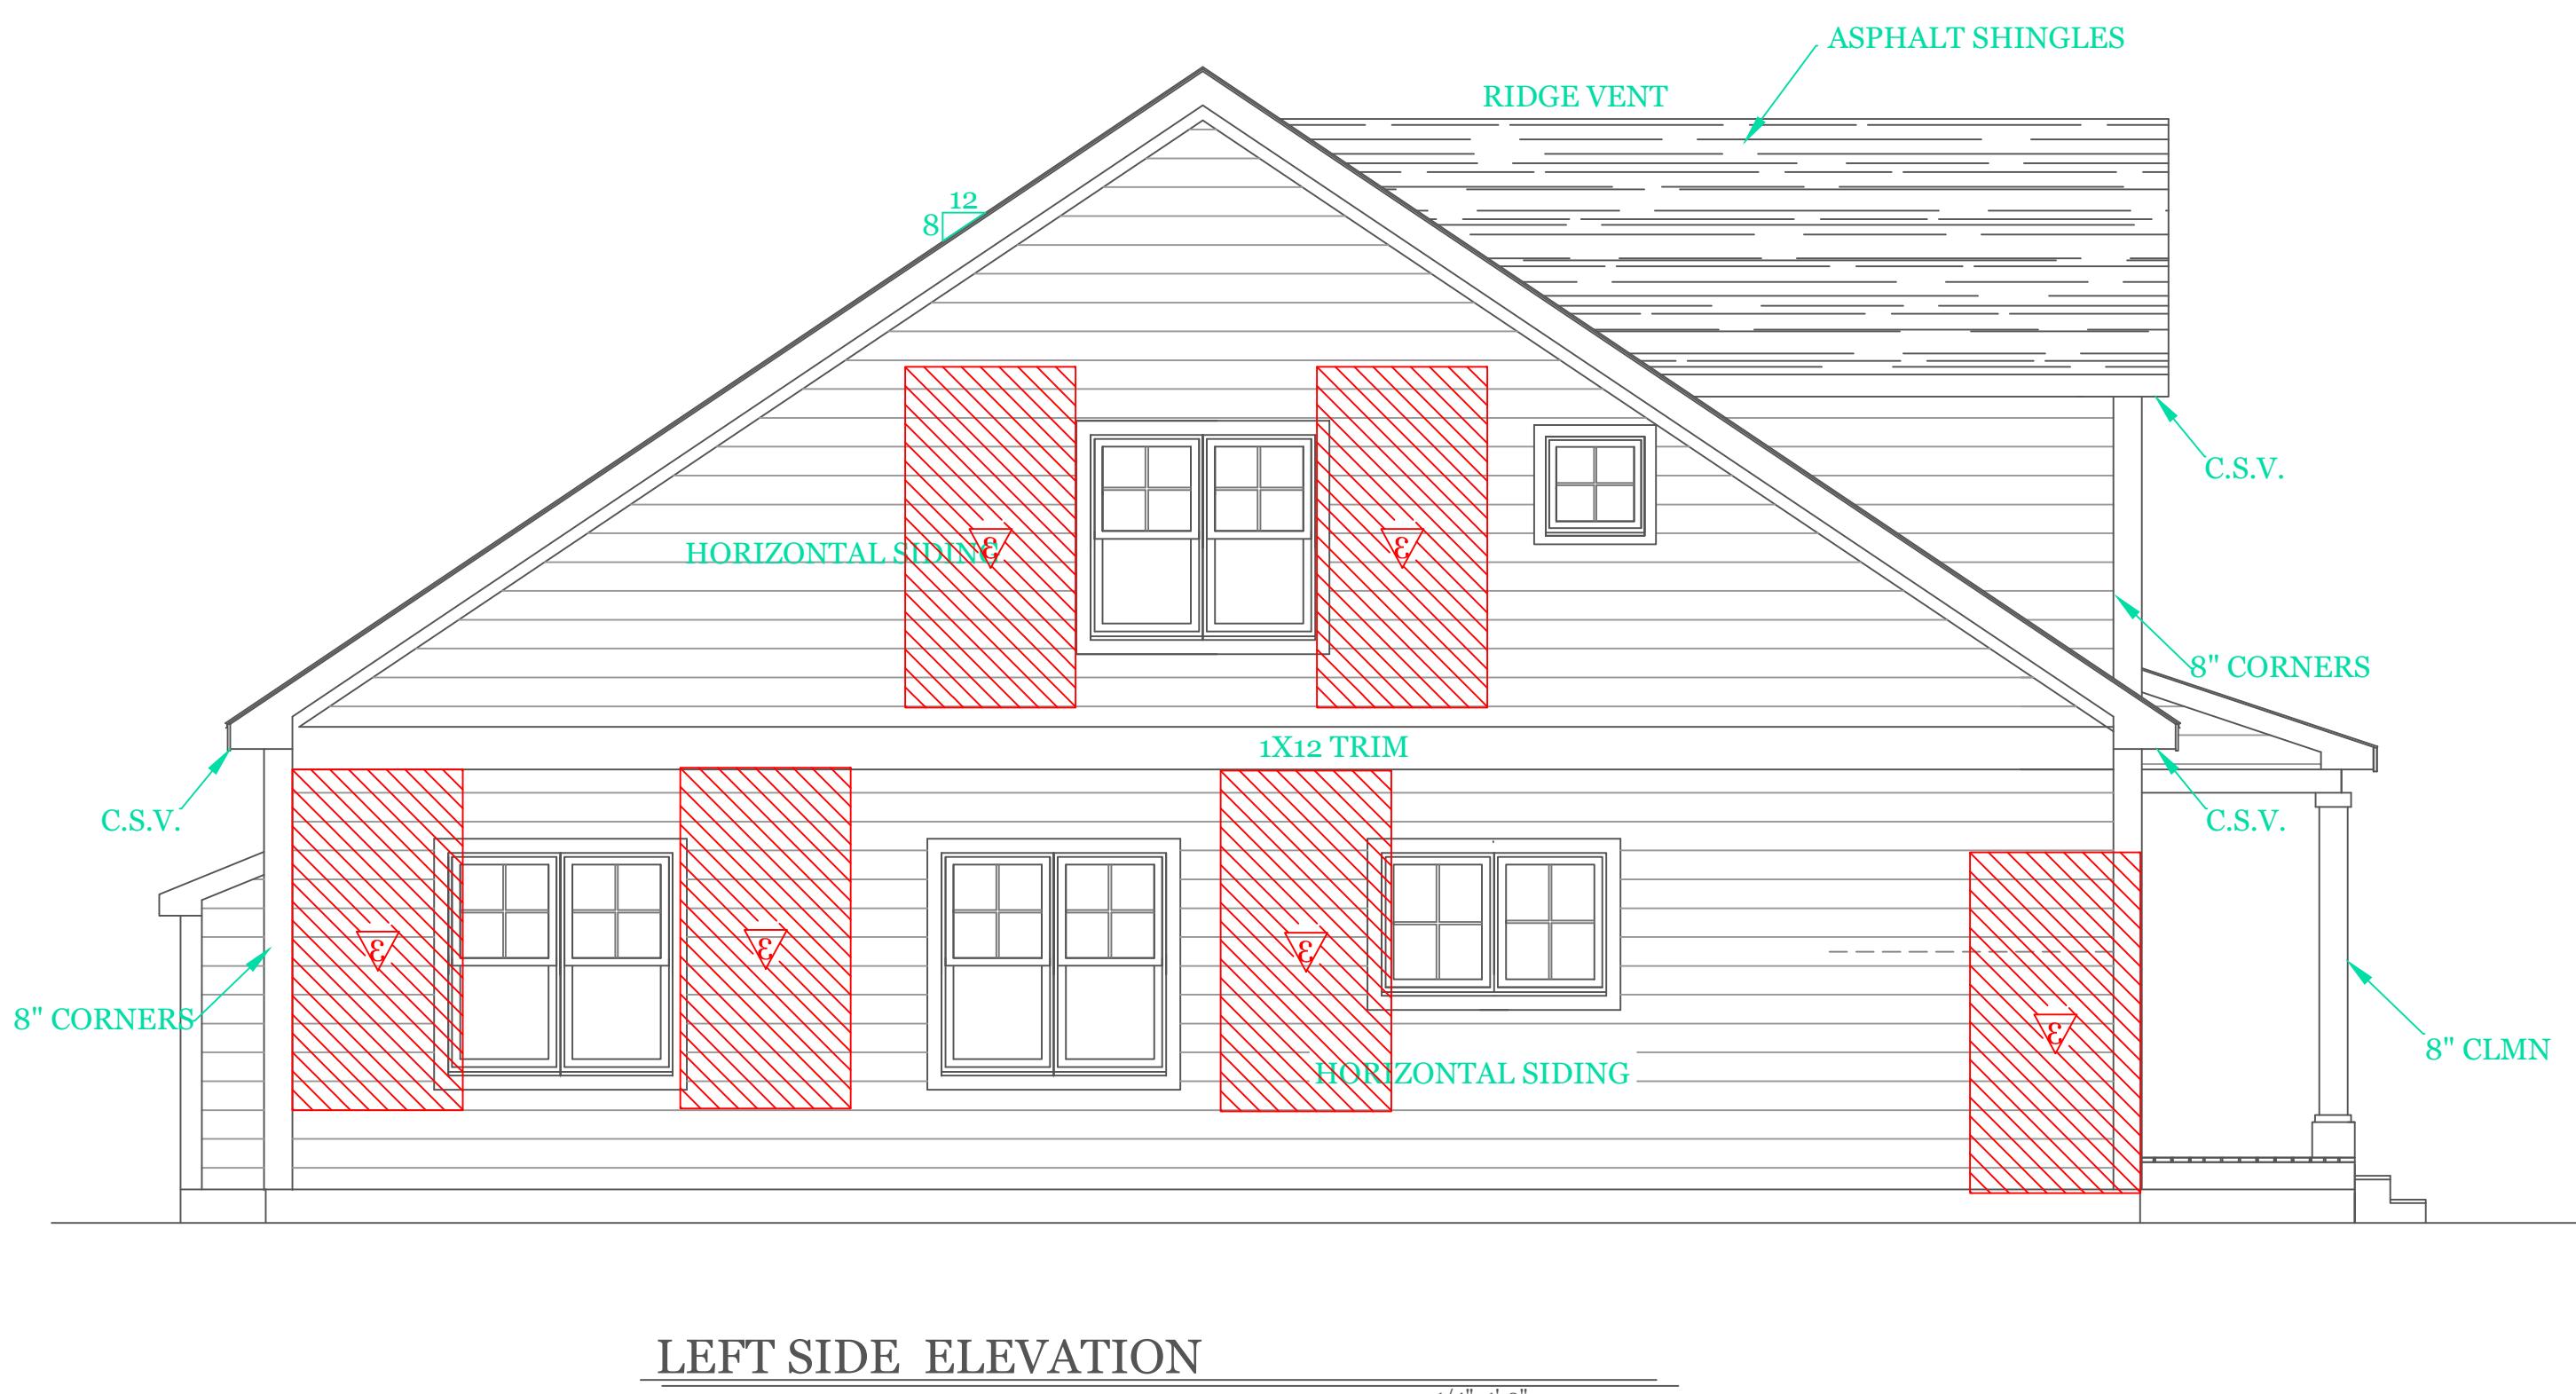
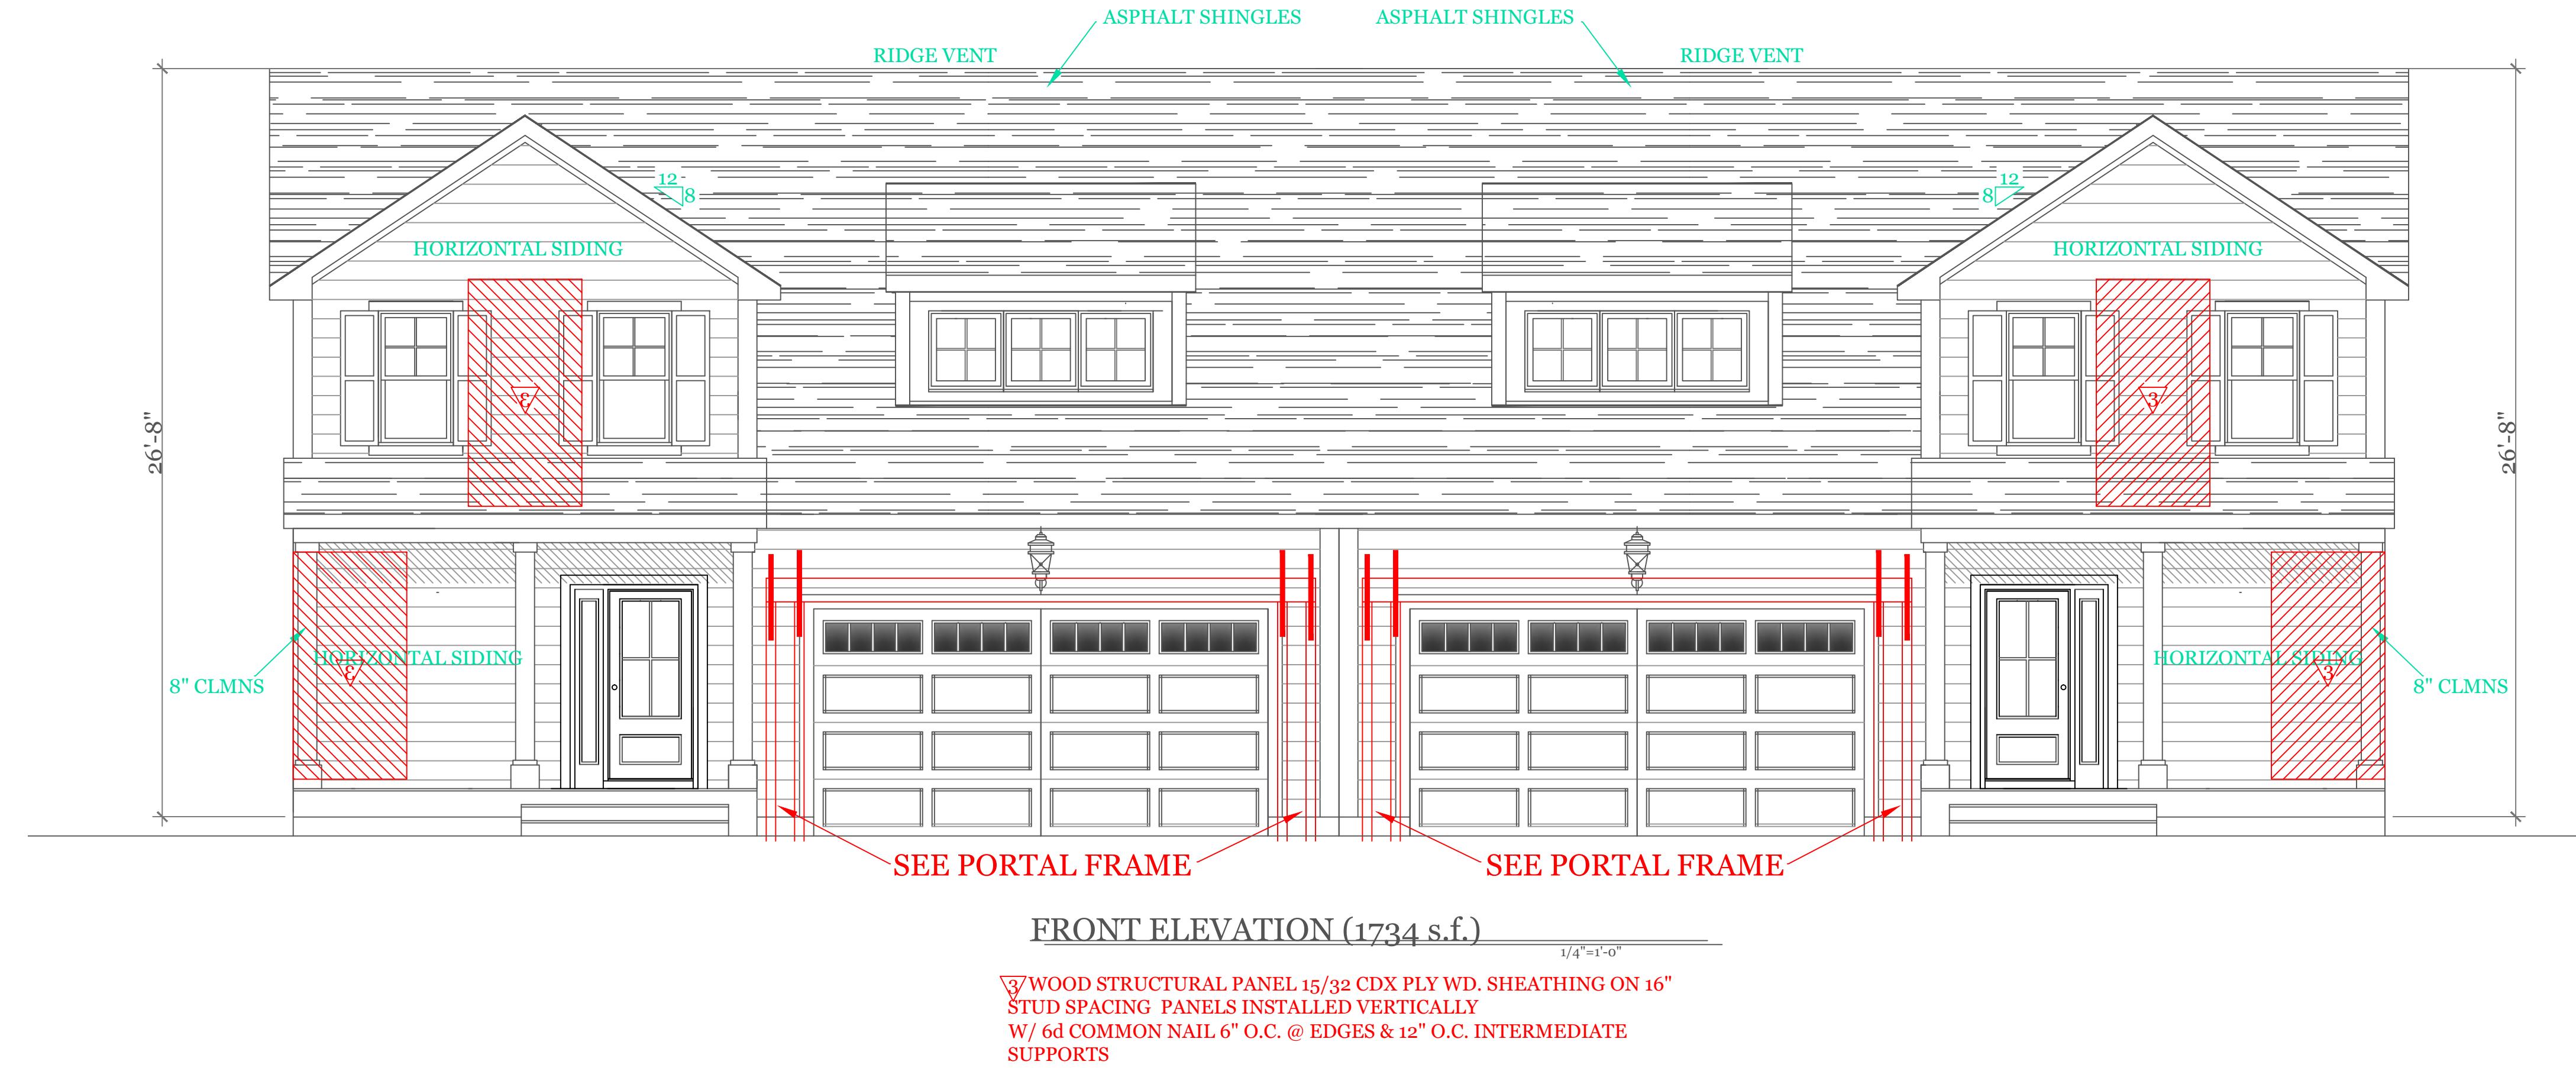


TABLE 402.1.2 INSULATION AND FENESTRATION REQUIREMENTS BY COMPONENT ^a								
CLIMATE ZONE	FENESTRATION U-FACTOR ^b	SKYLIGHT ^b U-FACTOR	GLAZED FENESTRATION SHGC ^{c,e}	CEILING R-VALUE	WOOD FRAME WALL R-VALUE	MASS WALL R-VALUE	BASEMENT ^c WALL R-VALUE	SLAB ^d R-VALUE & DEPTH
5 and Marine 4	0.30	0.55	NR	49	20 or 13+5 ^h	13/17	30g	15/19, 10, 2 ft

2018 INTERNATIONAL ENERGY CONSERVATION CODE® AND MASSACHUSETTES 780 CMR 9TH EDITION

- For SI: 1 foot = 304.8 mm.
- a. R-values are minimums. U-factors and SHGC are maximums. R-19 batts compressed into a nominal 2 x 6 framing cavity such that the R-value is reduced by R-1 or more shall be marked with the compressed batt R-value in addition to the full thickness R-value.
 - b. The fenestration U-factor column excludes skylights. The SHGC column applies to all glazed fenestration.
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 - d. R-5 shall be added to the required slab edge R-values for heated slabs. Insulation depth shall be the depth of the footing or 2 feet, whichever is less in Zones 1 through 3 for heated slabs.
 - e. There are no SHGC requirements in the Marine Zone.
 - f. Basement wall insulation is not required in warm-humid locations as defined by Figure 301.1 and Table 301.1.
 - g. Or insulation sufficient to fill the framing cavity, R-19 minimum.
 - h. "13+5" means R-13 cavity insulation plus R-5 insulated sheathing. If structural sheathing covers 25 percent or less of the exterior, insulating sheathing is not required where structural sheathing is used. If structural sheathing covers more than 25 percent of exterior, structural sheathing shall be supplemented with insulated sheathing of at least R-2.
 - i. The second R-value applies when more than half the insulation is on the interior of the mass wall.
 - j. For impact rated fenestration complying with Section R301.21.2 of the International Residential Code or Section 1608.1.2 of the International Building Code, the maximum U-factor shall be 0.75 in Zone 2 and 0.65 in Zone 3.

DESIGN CRITERIA											
GROUND SNOW LOAD	WIND SPEED (MPH)	SEISMIC DESIGN	WEATHERING	FROST LINE DEPTH	TERMITE	DECAY	WINTER DESIGN TEMP	ICE SHIELD UNDERLAYMENT REQUIRED	FLOOD HAZARD	AIR FREEZING INDEX	MEAN ANNUAL TEMP
TABLE 5301.2(5)	TABLE 5301.2.(4)	N/A	FIGURE 5301.2(3)	4 ft. minimum unless engineered data shows otherwise	FIGURE 5301.2(6)	FIGURE 5301.2(7)	APPENDIX 780 CMR 120.J TABLE 120.J.3.2.1	As required by the exterior roof covering manufacturer; roof pitch and local climate must also be considered	Refer to applicable Flood Insurance Rate Map (FIRM)	Only utilized in the design and construction of frost protected shallow foundations	Only utilized in the design and construction of frost protected shallow foundations
50 psf	124 mph	N/A	SEVERE	\$5403.14	MODERATE TO HEAVY	SLIGHT TO MODERATE	N/A	\$5905.0	FIRM MAPS	SEE NOTE J TABLE 5301.2(1)	SEE NOTE K TABLE 5301.2(1)

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 Design / Build
 17 Glenwood St.
 Holden Ma.
 Phone No.
 (508) 466-3202

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CONSULTING ENGINEER
 MICHAEL J. BURKE P.E.
 299 SALISBURY STR.
 WORCESTER, MA
 (508)450-3461

UNIT 'C' DUPLEX
 HIGGINS FARM AT
 SALISBURY HILL
 FRONT & LEFT SIDE
 ELEVATIONS
 DESIGN CRITERIA

UNIT 'C' DPLX
 DATE: 9/28/2022 R5/5/23
 SCALE: 1/4"=1'-0"
 DRAWN BY: RCS
 CHECKED BY: MJB
 Sheet 1 OF 8


1

NOTES:



REAR ELEVATION

$1/4''=1'-0''$

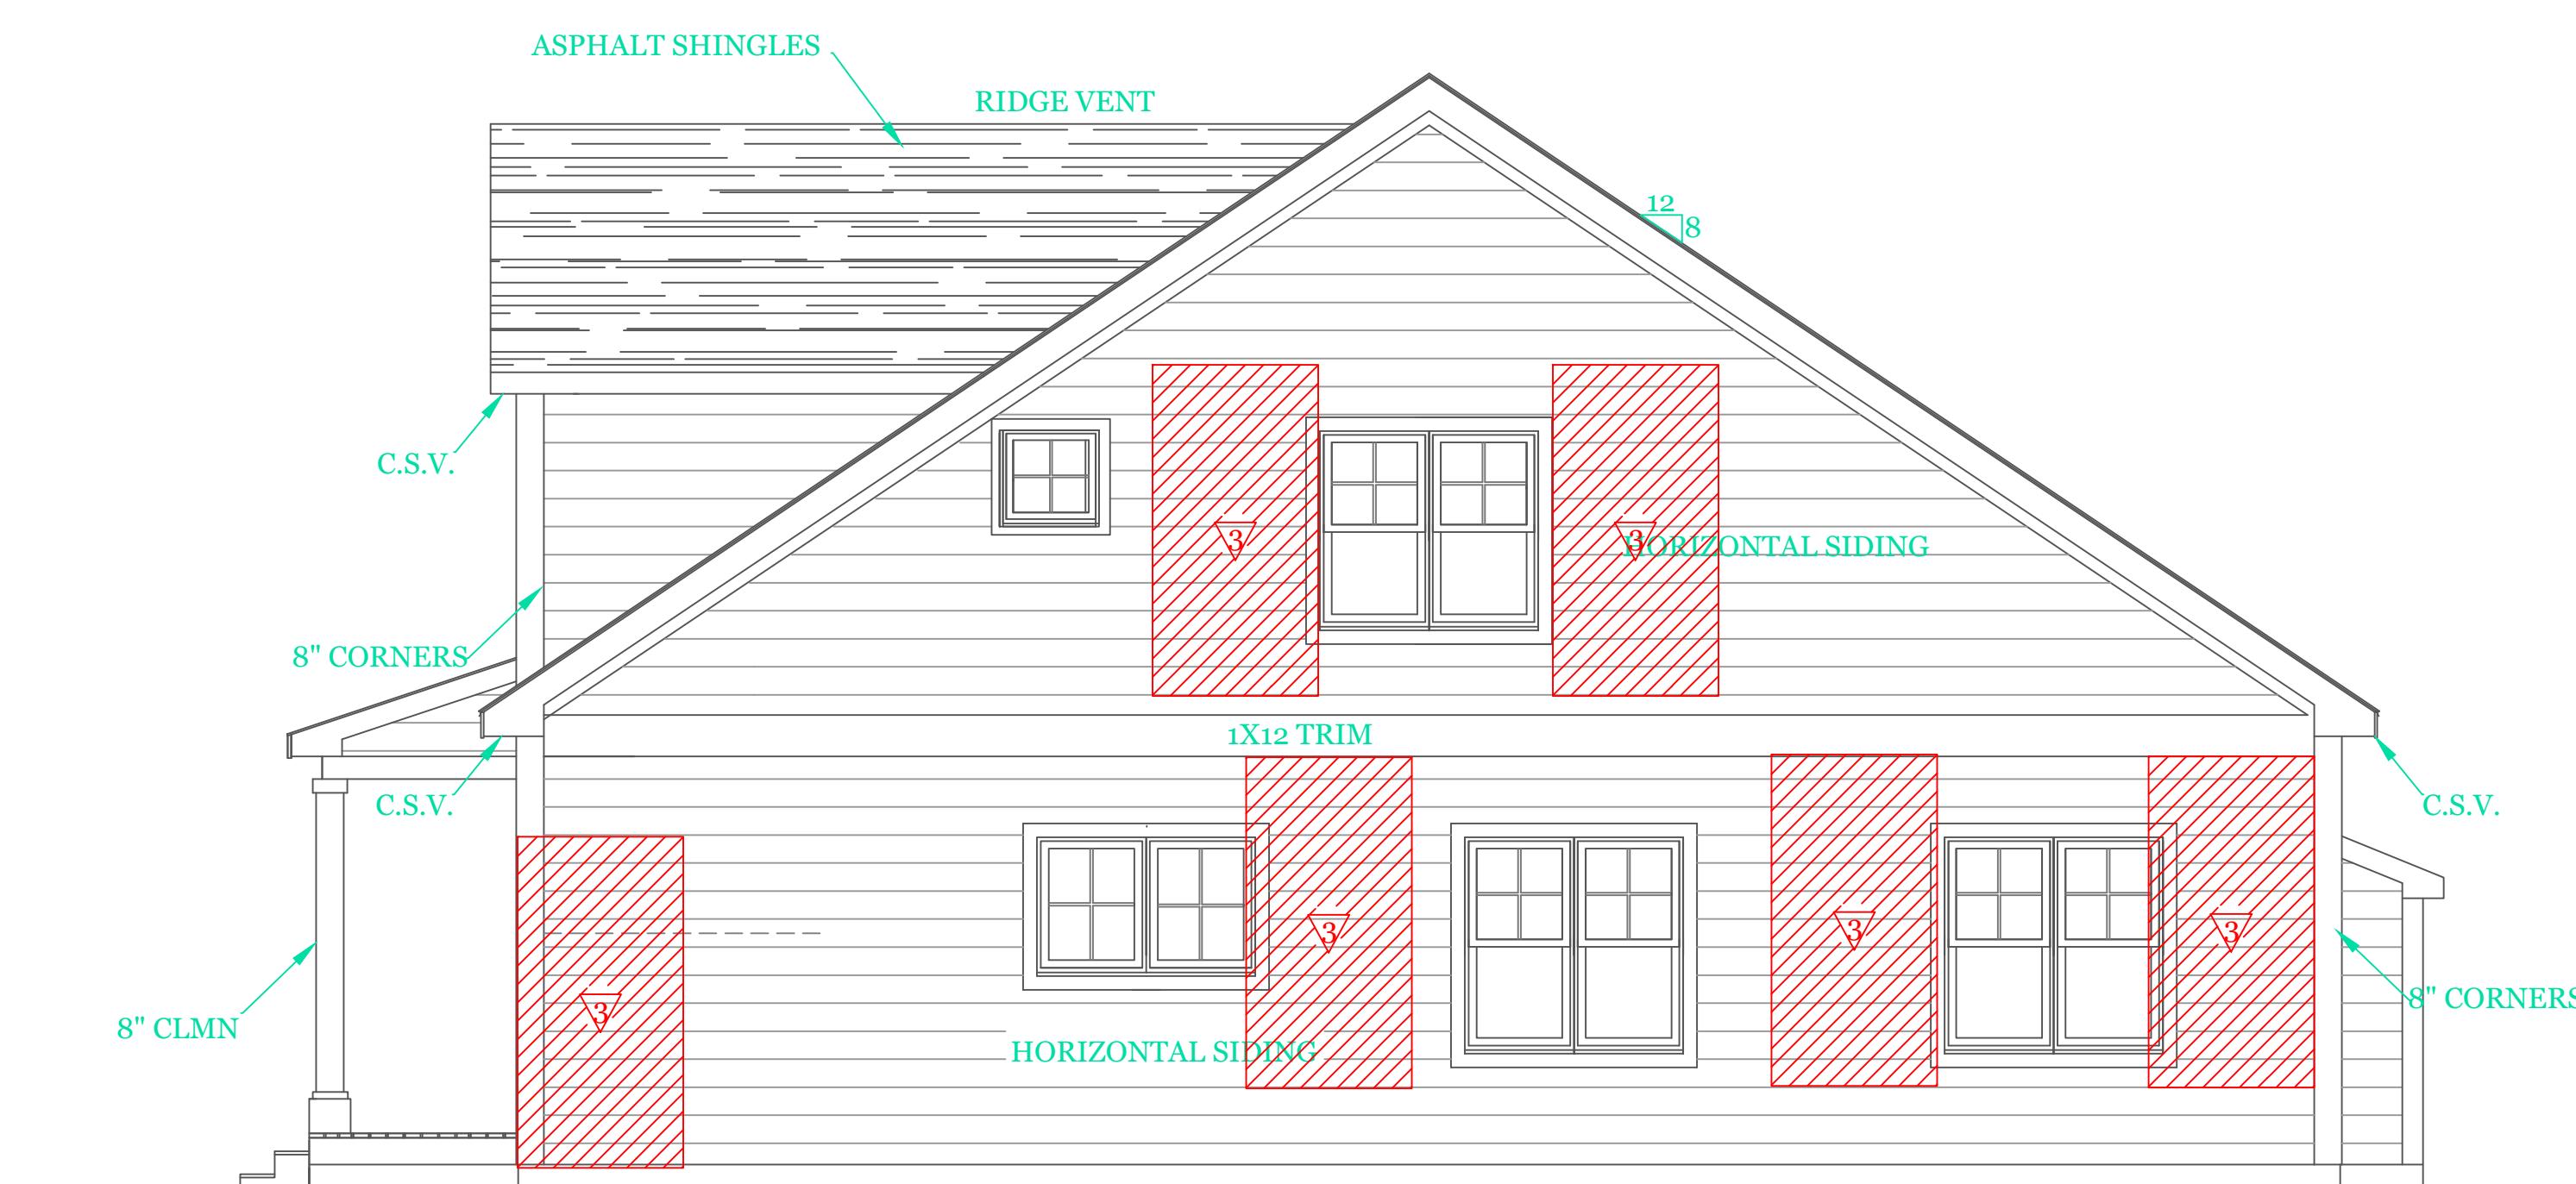

RIGHT SIDE ELEVATION

$1/4''=1'-0''$

R.C. Searles Associates

Exclusive Home Designers

Design / Build

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Holden Ma.

CONSULTING ENGINEER
MICHAEL J. BURKE P.E.
299 SALISBURY STR.
WORCESTER, MA
(508)450-3461

UNIT 'C' DUPLEX
HIGGINS FARM AT
SALISBURY HILL

UNIT 'C' DPLX

DATE: 9/28/2022 R5/5/23

SCALE: $1/4''=1'-0''$

DRAWN BY: RCS

CHECKED BY: MJB


Sheet 2 OF 8

2

NOTES:

SYMBOL SCHEDULE:

- [V] VENT
- [S] SMOKE AND CARBON DETECTOR
- (S) SMOKE DETECTOR
- [H] HEAT DETECTOR
- [■] BEARING POINT W/ SQUASH BLOCK

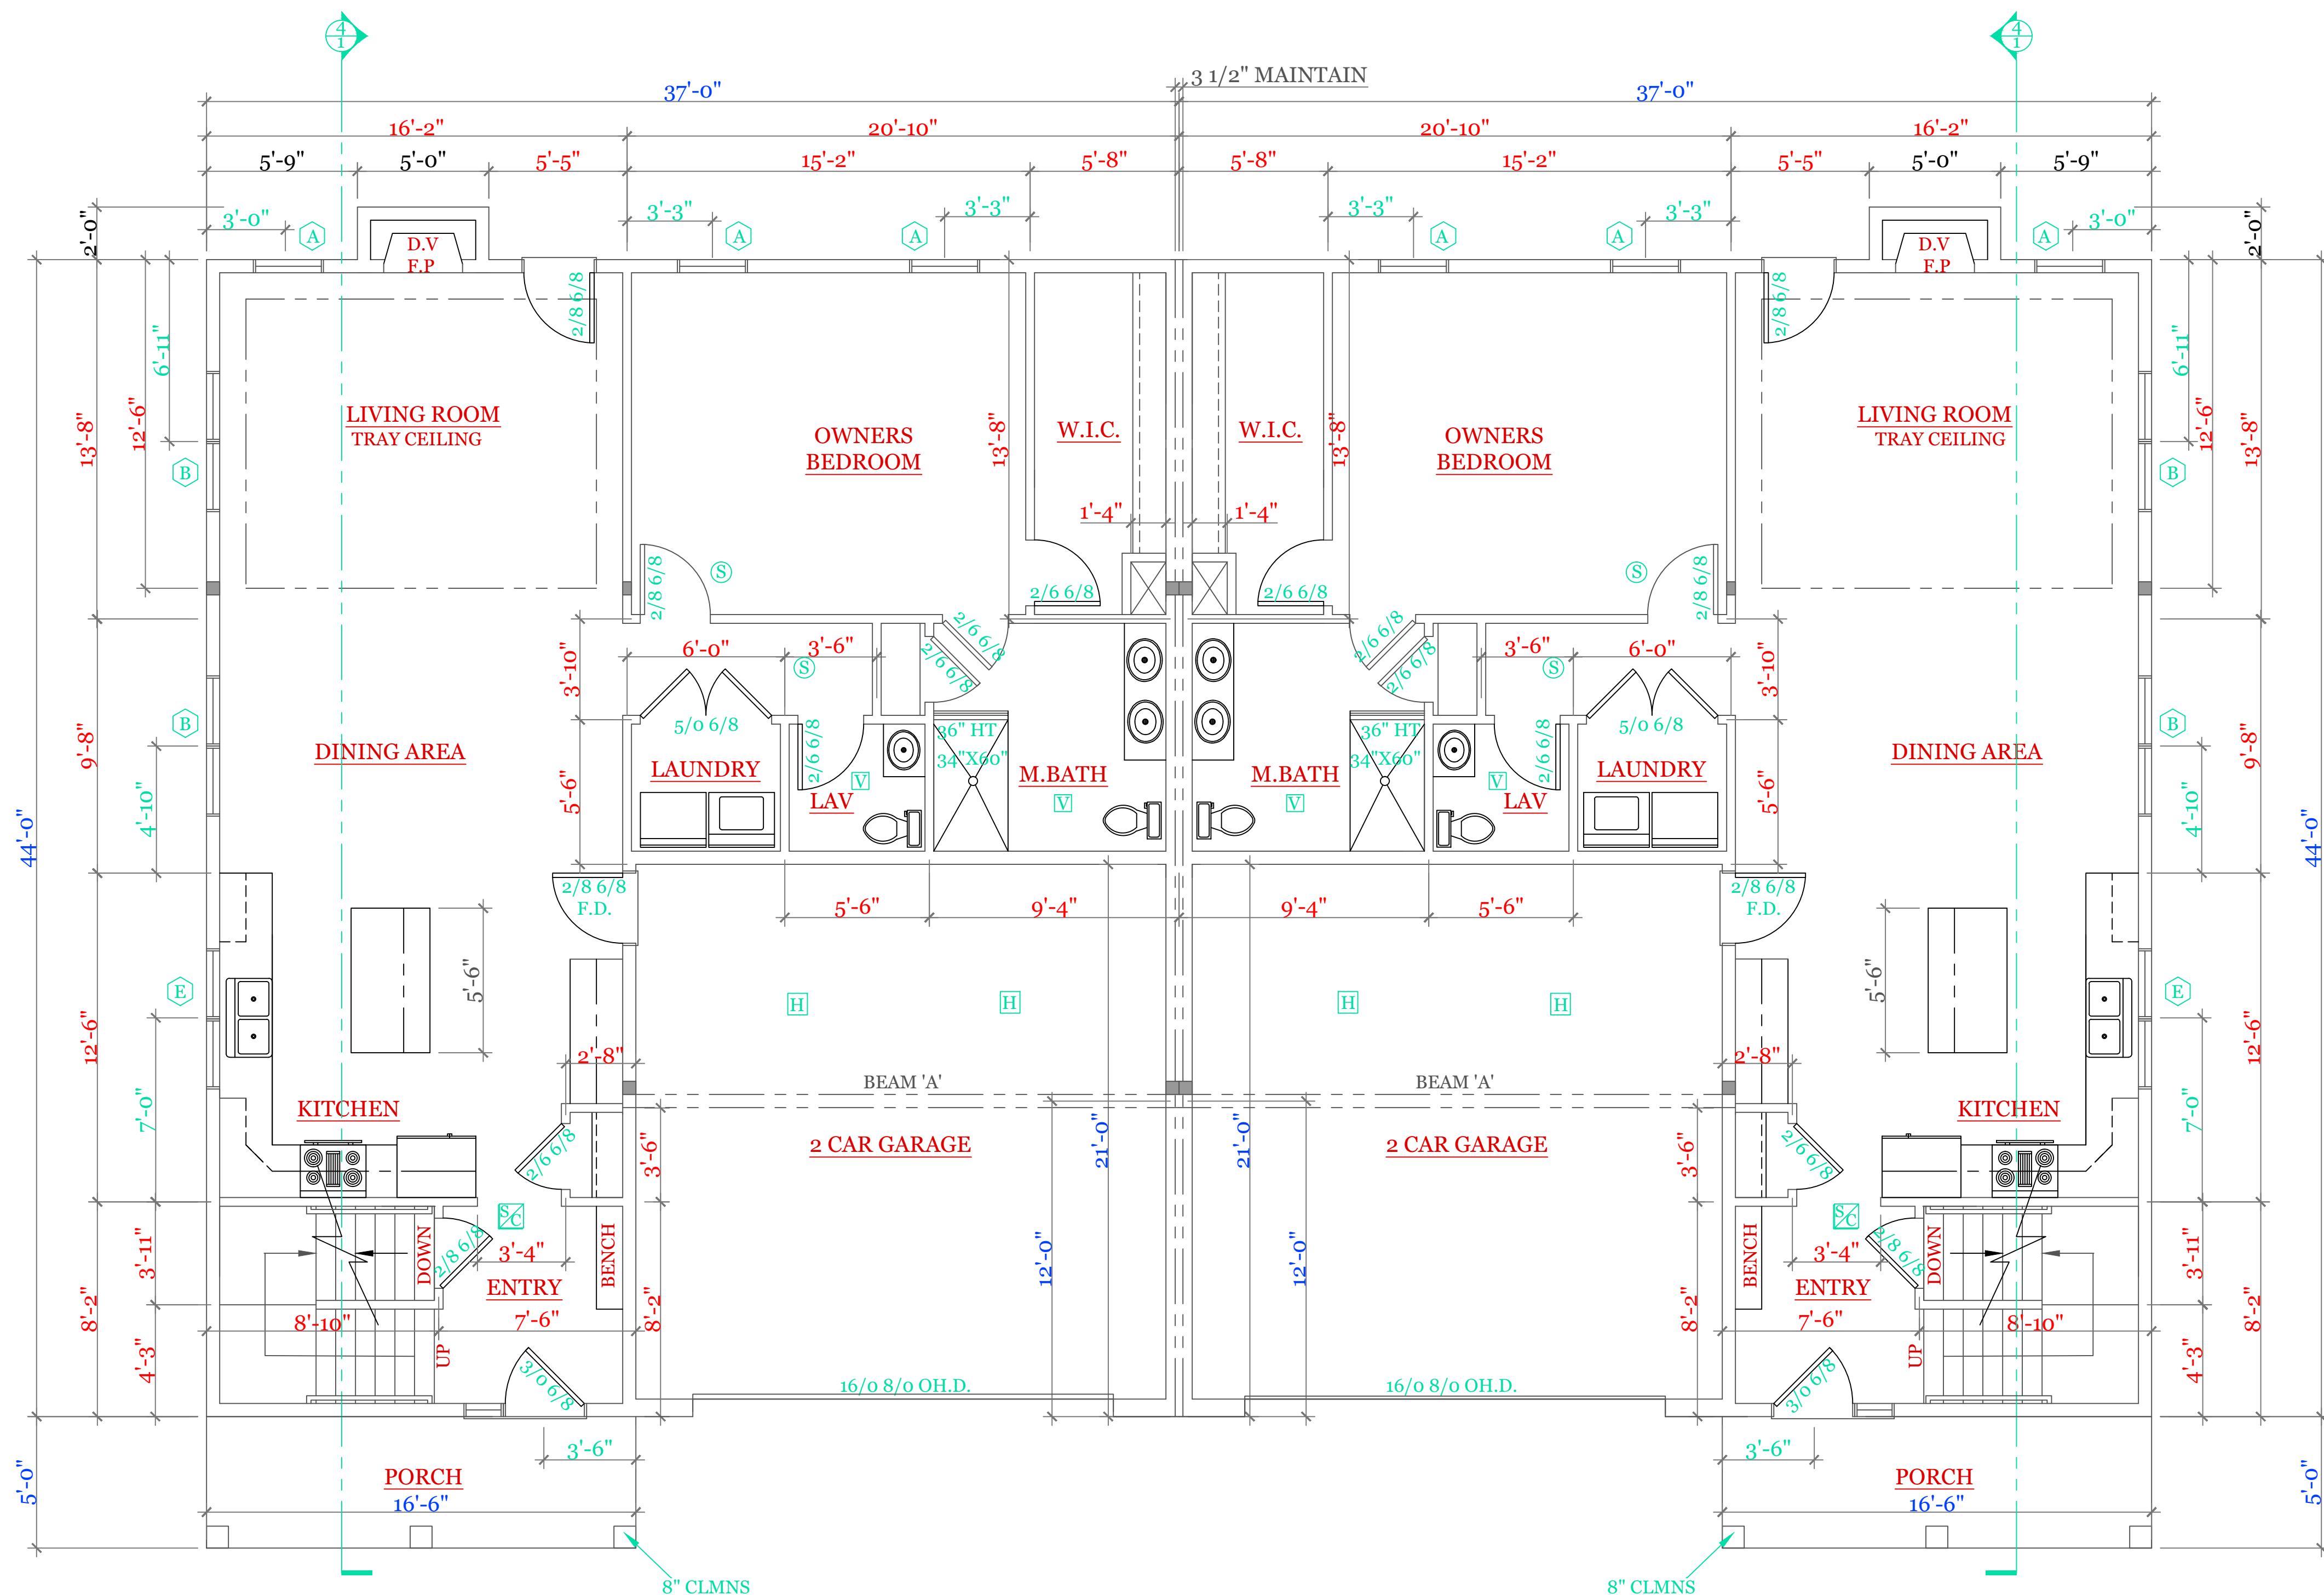

FIRST FLOOR PLAN (1194 s.f.) GARAGE (434 s.f.)

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UNIT 'C' DUPLEX	HIGGINS FARM AT SALISBURY HILL
FIRST FLOOR PLAN	WINDOW SCHEDULE

UNIT 'C' DPLX

DATE: 9/28/2022 R5/5/23

SCALE: 1/4"=1'-0"

DRAWN BY: RCS


CHECKED BY: MJB

Sheet 4 OF 8

WINDOW SCHEDULE: HARVEY LANSING PER UNIT			
INDEX	QUA	CATALOG	ROUGH OPENING
A	3	10000-1	2'-8 1/8" X 5'-6"
B	2	11000-1	5'-4 1/2" X 5'-6"
C	2	12000-1	2'-8 1/8" X 4'-9"
C1	2	13000-1	5'-4 1/2" X 4'-9"
D*	2	14000-1 TEMPERED	2'-4 3/8" X 2'-8"
E	1	15000-1	4'-0 1/2" X 3'-5 3/8"
F	1	16000-3	7'-9" X 3'-1"
FRONT	1	17000-1	4'-3 3/8" X 6'-10 1/2"
REAR	1	18000-1	3'-2 3/8" X 6'-10 1/2"

NOTES: CONSULT TABLE 603.7(1) JACKS & HEADERS

NOTES:	
SYMBOL SCHEDULE;	
V	VENT
SK	SMOKE AND CARBON DETECTOR
S	SMOKE DETECTOR
H	HEAT DETECTOR
■	BEARING POINT W/ SQUASH BLOCK

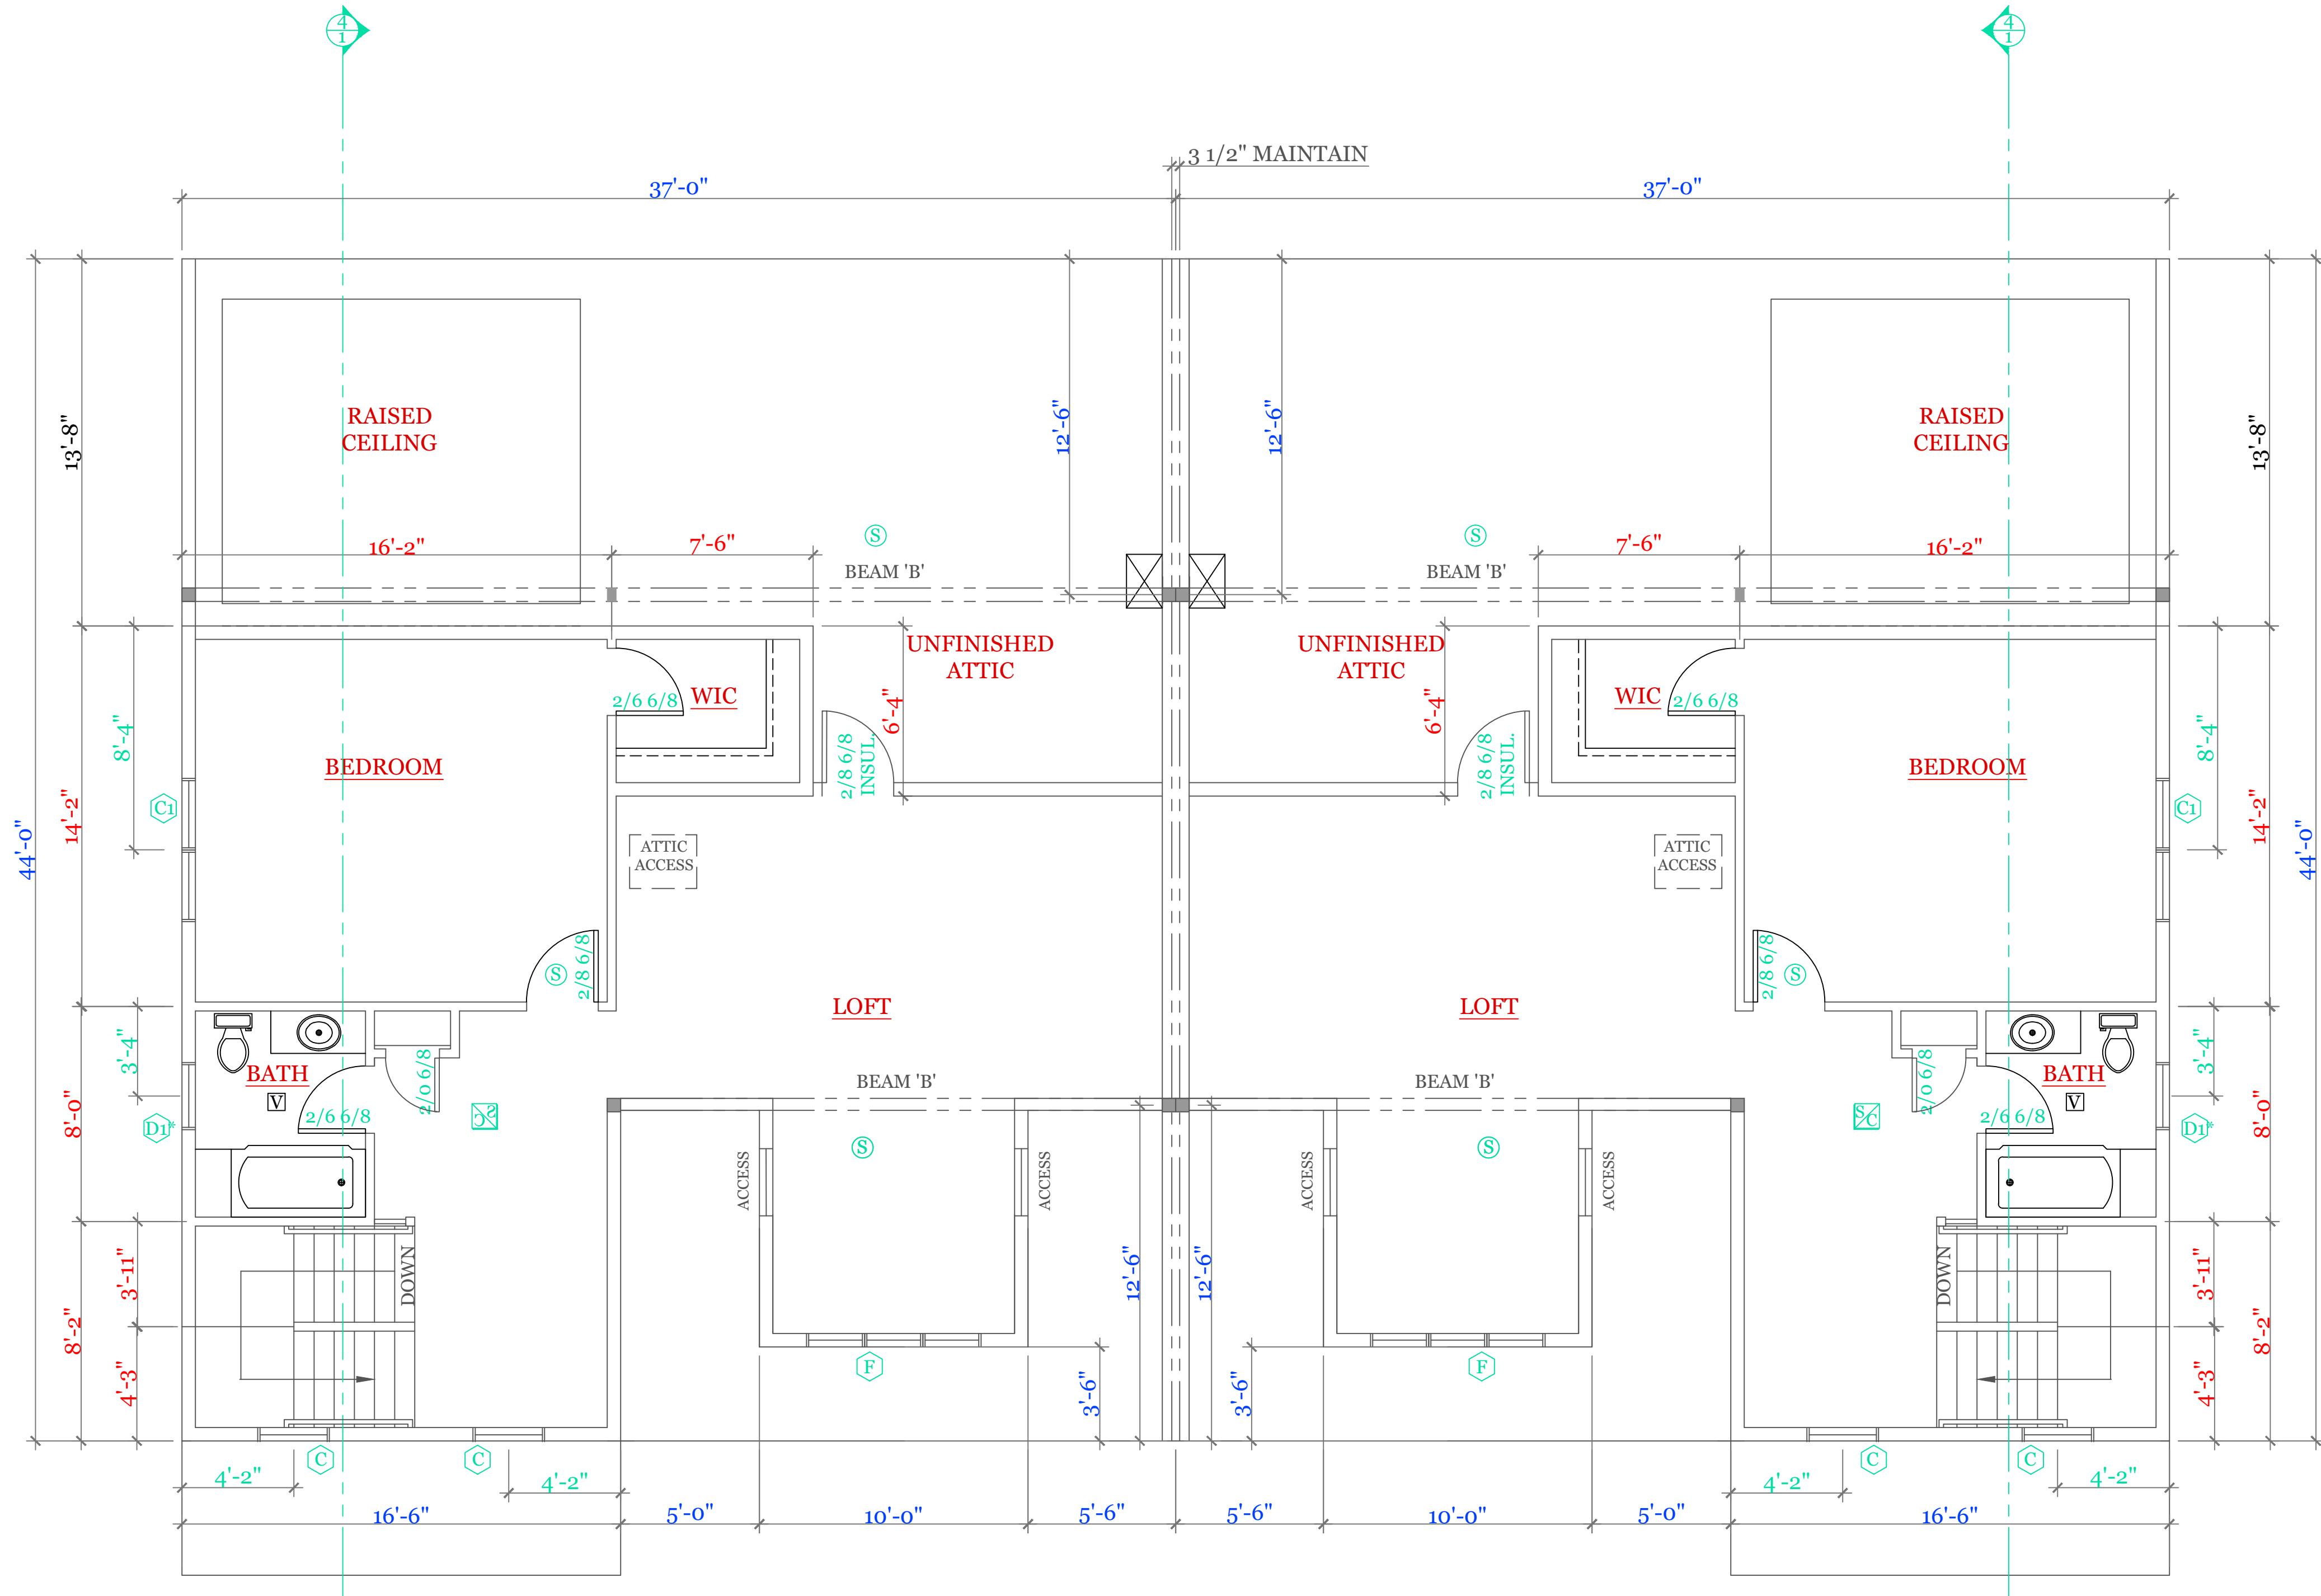

WINDOW SCHEDULE: HARVEY LANSING PER UNIT			
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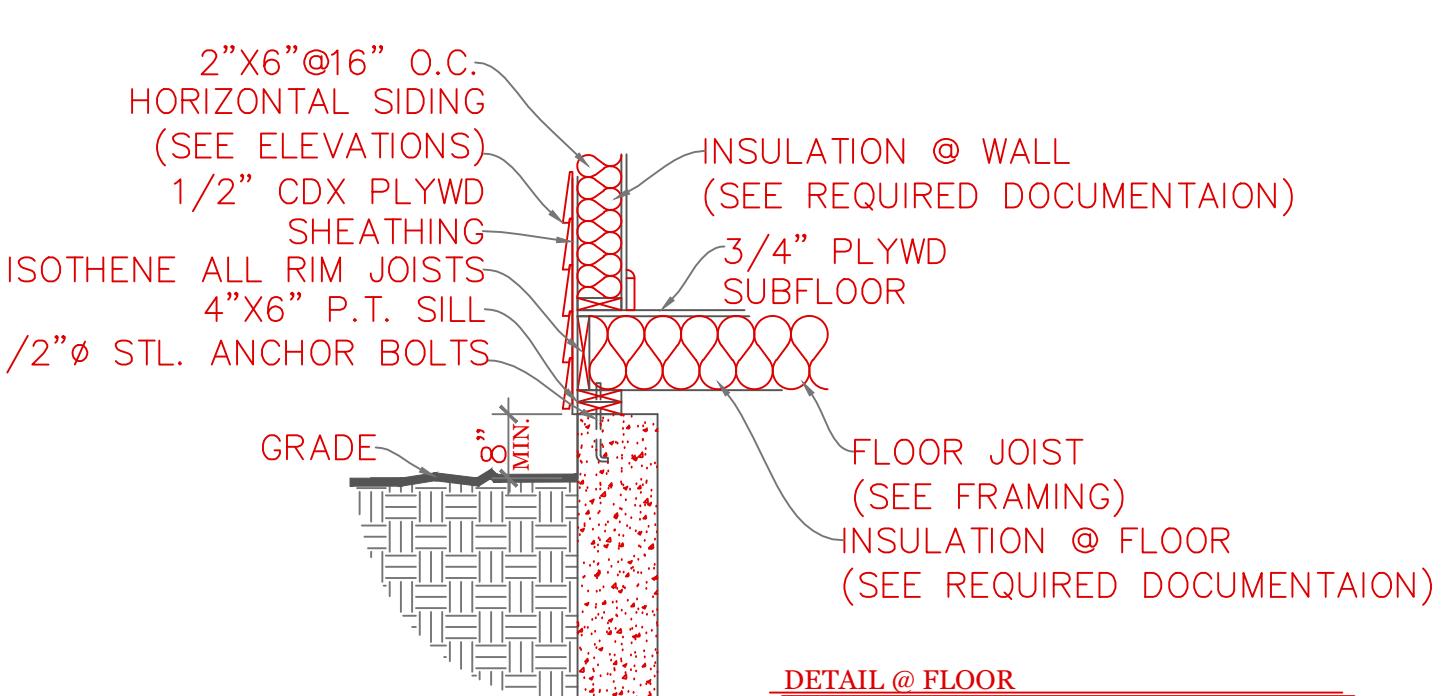
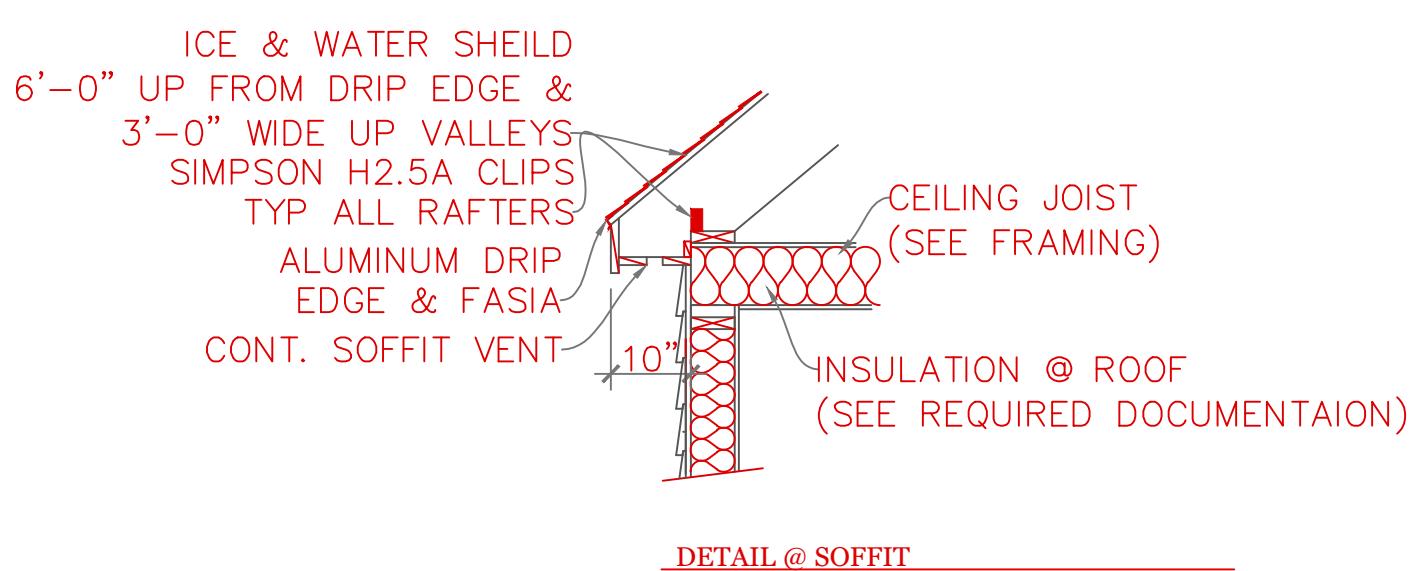
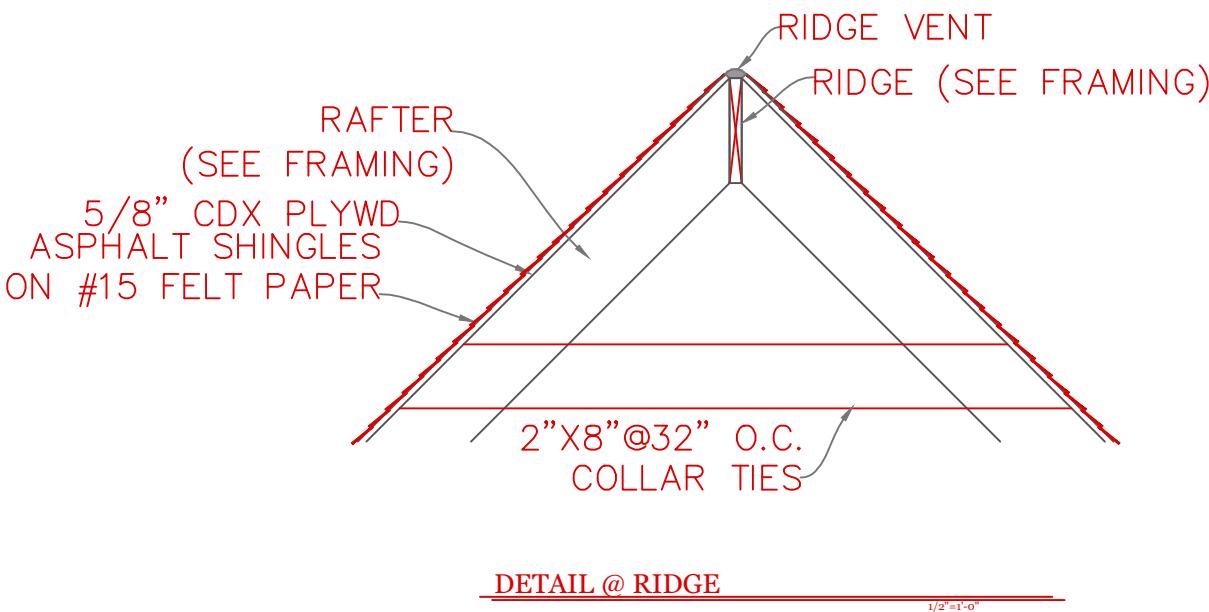
UNIT 'C' DUPLEX
HIGGINS FARM AT
SALISBURY HILL
SECOND FLOOR PLAN
WINDOW SCHEDULE

UNIT 'C' DPLX

DATE: 9/28/2022 R5/5/23
SCALE: 1/4"=1'-0"
DRAWN BY: RCS
CHECKED BY: MJB
Sheet 5 OF 8

5


TYPICAL BUILDING SECTION



CONSTRUCTION SCHEDULE:		(UNLESS NOTED OTHERWISE ON PLAN)
1	RIDGE BOARD:	SEE FRAMING W/ RIDGE VENT
2	ROOF MATERIAL:	ASPHALT SHINGLES ON 15# ROOF FELT
3	ROOF SHEATHING	1/2" O.S.B. w/ 15# ROOF FELT
4	ROOF RAFTER:	SEE FRAMING
5	COLLAR TIES:	1X8 @ 32" O.C.
6	DRIP EDGE:	ALUMINUM DRIP EDGE
7	SOFFIT:	CONT. SOFFIT VENT
8	CEILING JOIST:	SEE FRAMING
9	ATTIC INSULATION:	R-38
10	EXT WALL:	2"x6" @ 16" O.C.
11	EXT. SHEATHING	1/2" O.S.B. w/ HOUSE WRAP
12	EXT. FINISH:	SEE ELEVATIONS
13	INSULATION@WALL	R-21
14	INTERIOR WALL	2"x4" @ 16" O.C.
15	SUB FLOOR:	3/4" ADVANTEK GLUED & NAILED
16	JOIST:	SEE FRAMING.
17	SILL:	2"x6" P.T. SILL W/ 2X6 KD TOP PLATE
18	INSULATION @ FLOOR	R-30
19	ANCHOR:	1/2" Ø STL ANCHOR BOLTS
20	BEAM:	SEE FRAMING PLAN
21	COLUMN:	3 1/2" L.C.
22	FND. WALL:	10"x7"-10" CONC. WALL
23	SLAB:	SEE FOUNDATION NOTES
24	FOOTING:	20"x10" CONT. KEYED FTNG
25	CONC. PAD:	30"x30"x15" CONC. PAD


NOTES: -ISOSENE ALL RIM JOISTS (OPTIONAL)
-ICE & WATER SHEILD 6'-0" UP FROM DRIP EDGE
& 3'-0" WIDE UP VALLEYS
-SIMPSON H2.5A CLIPS TYP ALL RAFTERS

DUPLEX BUILDING ONLY

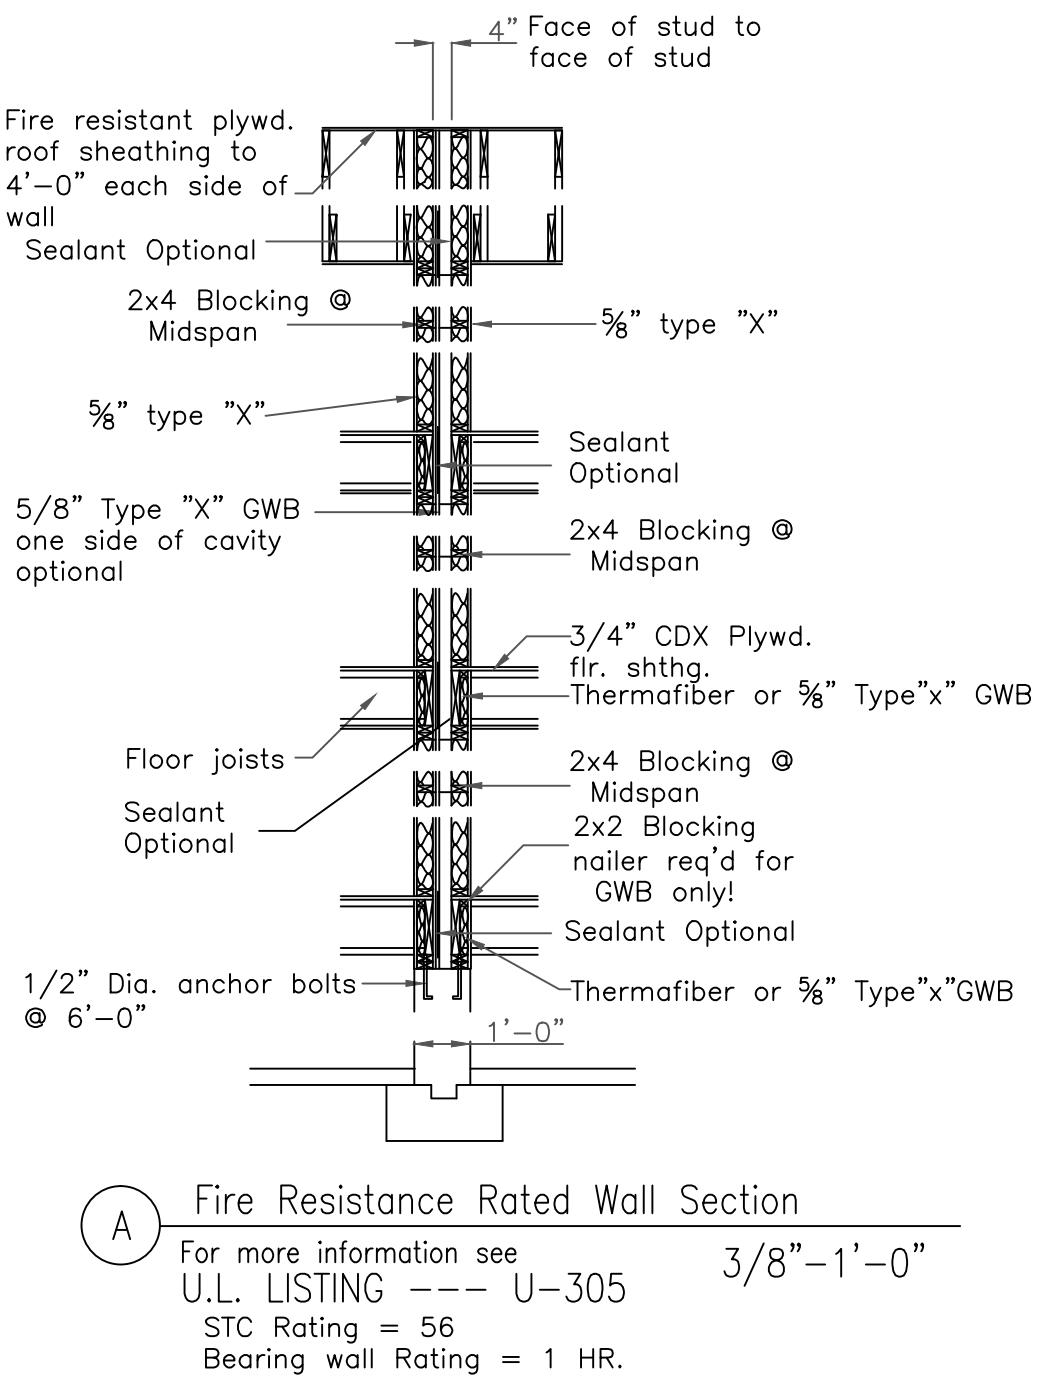


FIRE RESISTANCE RATINGS - ANSI/UL 263 (BXUV)

DESIGN NO. U366
Bearing Wall Rating - 2 HR
Finish Rating - 120 MIN.
STC 60-64

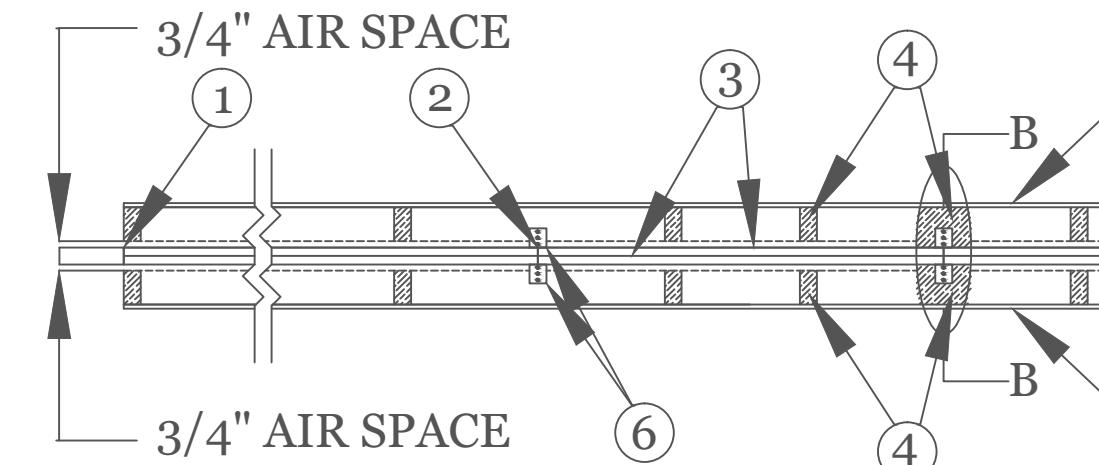

CONFIGURATION B
EXPOSED TO FIRE FROM EITHER SIDE

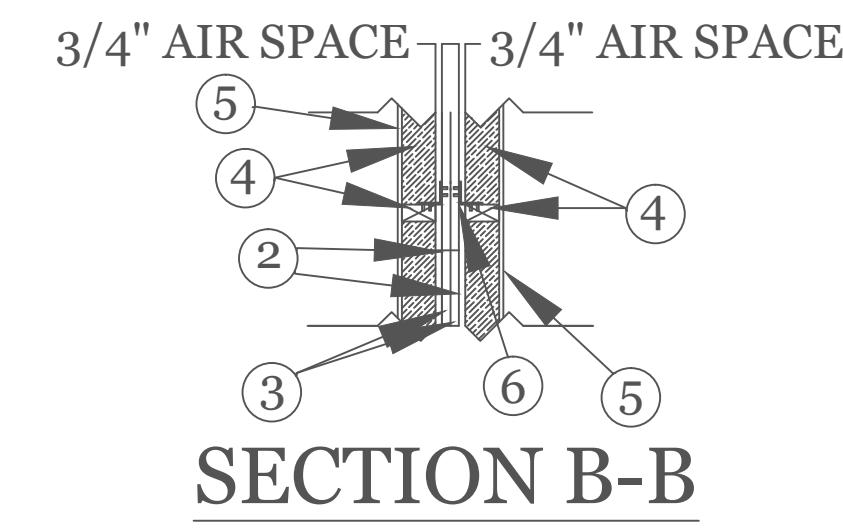

SECTION B-B

AREA SEPARATION WALL: - (Max Height - 44 ft)

- Floor, Intermediate or Top Wall** - 2 in. wide channel shaped with 1 in. long legs formed from No. 25 MSG galv steel, secured with suitable fasteners spaced 24 in. O.C.
- Steel Studs** - Steel members formed from No. 25 MSG galv steel having "H" shaped flanged spaced 24 in. O.C.; overall depth 2in. and flange width 1-3/8 in.
- Gypsum Board*** - Two layers of 1 in. thick gypsum wallboard liner panels, supplied in nom 24 in. widths. Vertical edges of panels friction fitted into "H" shaped studs.

BPB AMERICA INC - ProRoc Shaftliner
JAMES HARDE GYPSUM INC - ProRoc Shaftliner

PROTECTED WALL: - (Bearing or Nonbearing Wall)

- Wood Studs** - Nom 2 by 4 in. max spacing 16 in. O.C. Studs cross-braced at midheight where necessary for clip attachment. Min 3/4 in. separation between wood framing and area separation wall.

- Gypsum Board** - Classified or Unclassified - Min. 1/2 in. thick, 4 ft. wide, applied either horizontally or vertically. Wallboard attached to studs with 1-1/4 in. long steel drywall nails space 8 in. O.C. Vertical joints located over studs. (Optional) Joints covered with paper tape and joint compound. Nail heads covered with joint compound.


- Attachment Clips** - Aluminum angle; 0.063 in. thick, min 2 in. wide with min 2 in. and 2-1/4 in. legs. Clips secured with Type S screws 3/8 in. long to "H" studs and with Type W screws 1-1/4 in. long to wood framing through holes provided in clip. Clips spaced a max of 10ft. O.C. vertically between wood framing and "H" studs for separation walls up to 23 ft. high. For separation walls up to 44 ft. high, clips spaced as described above for the upper 24 ft. and the remaining wall area below requires clips spaced a max of 5 ft. O.C. vertically between wood framing and "H" studs.

* Bearing the UL Classification Mark

NOTES:

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CROSS SECTION

PORCH DETAIL

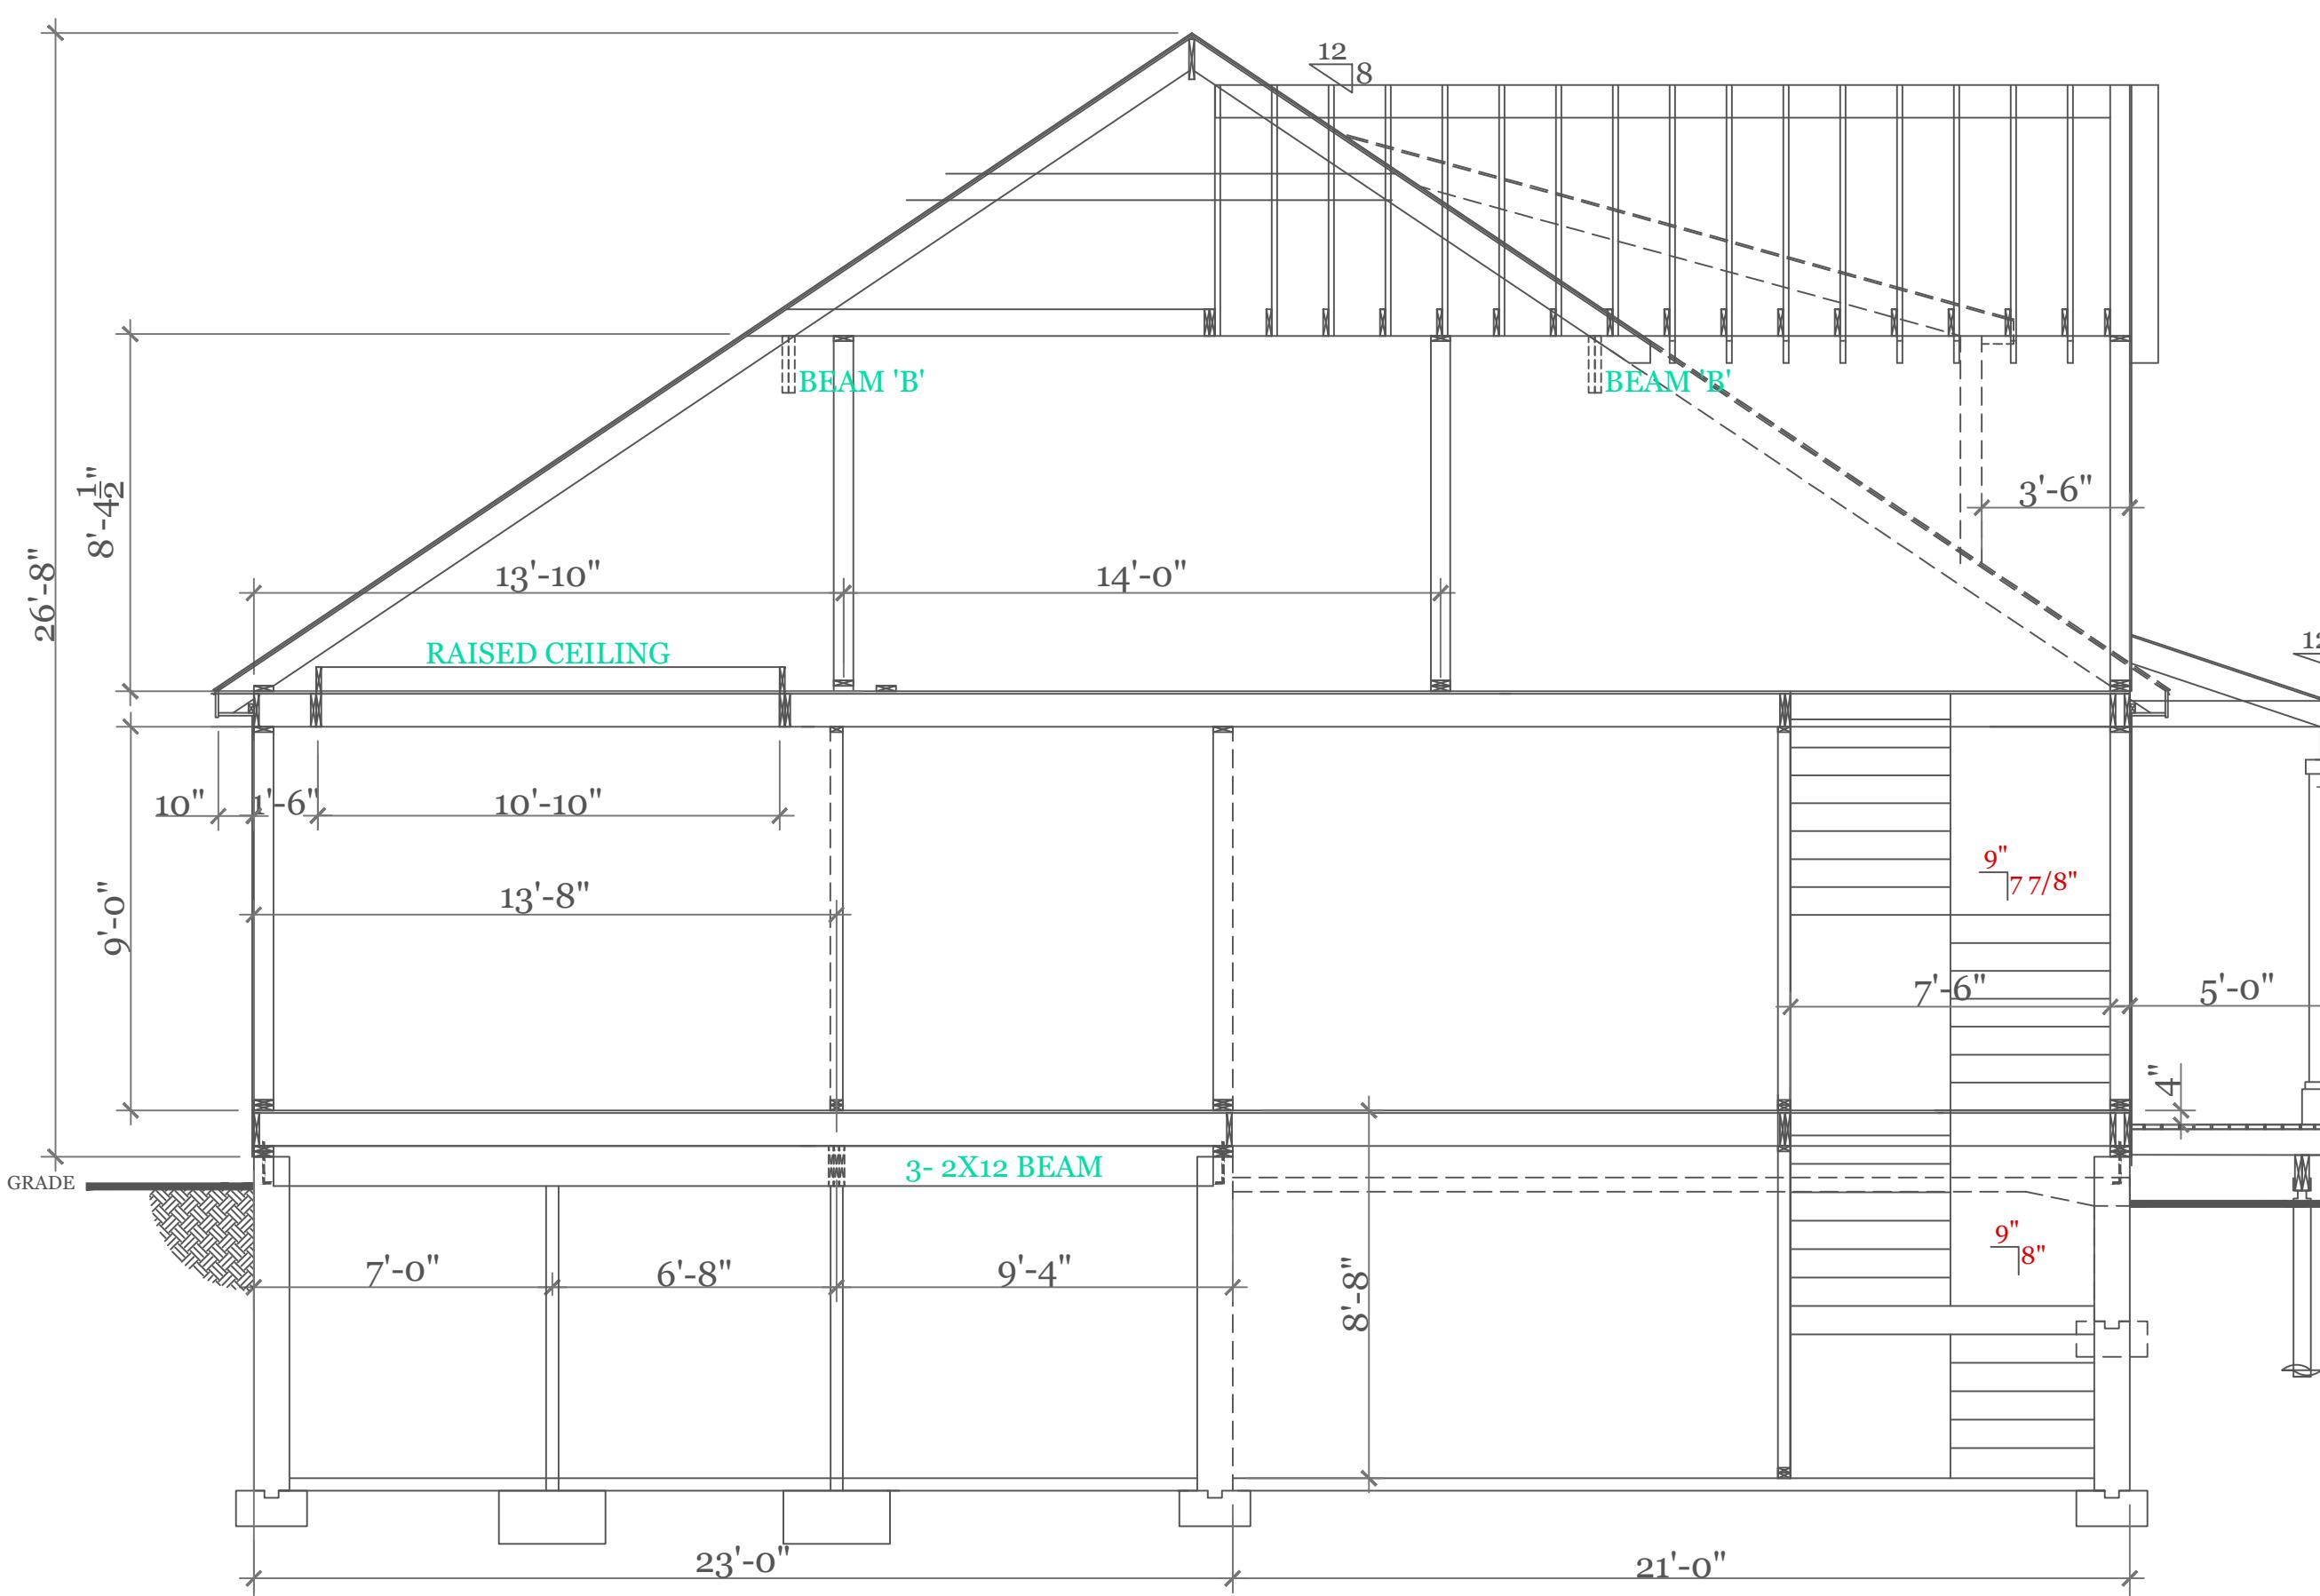**UNIT 'C' DUPLEX
HIGGINS FAM AT
SALISBURY HILL
CONSTR. SCHEDULE**

DATE: 9/28/2022 R5/5/23


SCALE: AS NOTED

DRAWN BY: RCS

CHECKED BY: MJB

Sheet 6 OF 8


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SECOND FLOOR FRAMING (2"X10"@16"O.C. UNLESS NOTED)

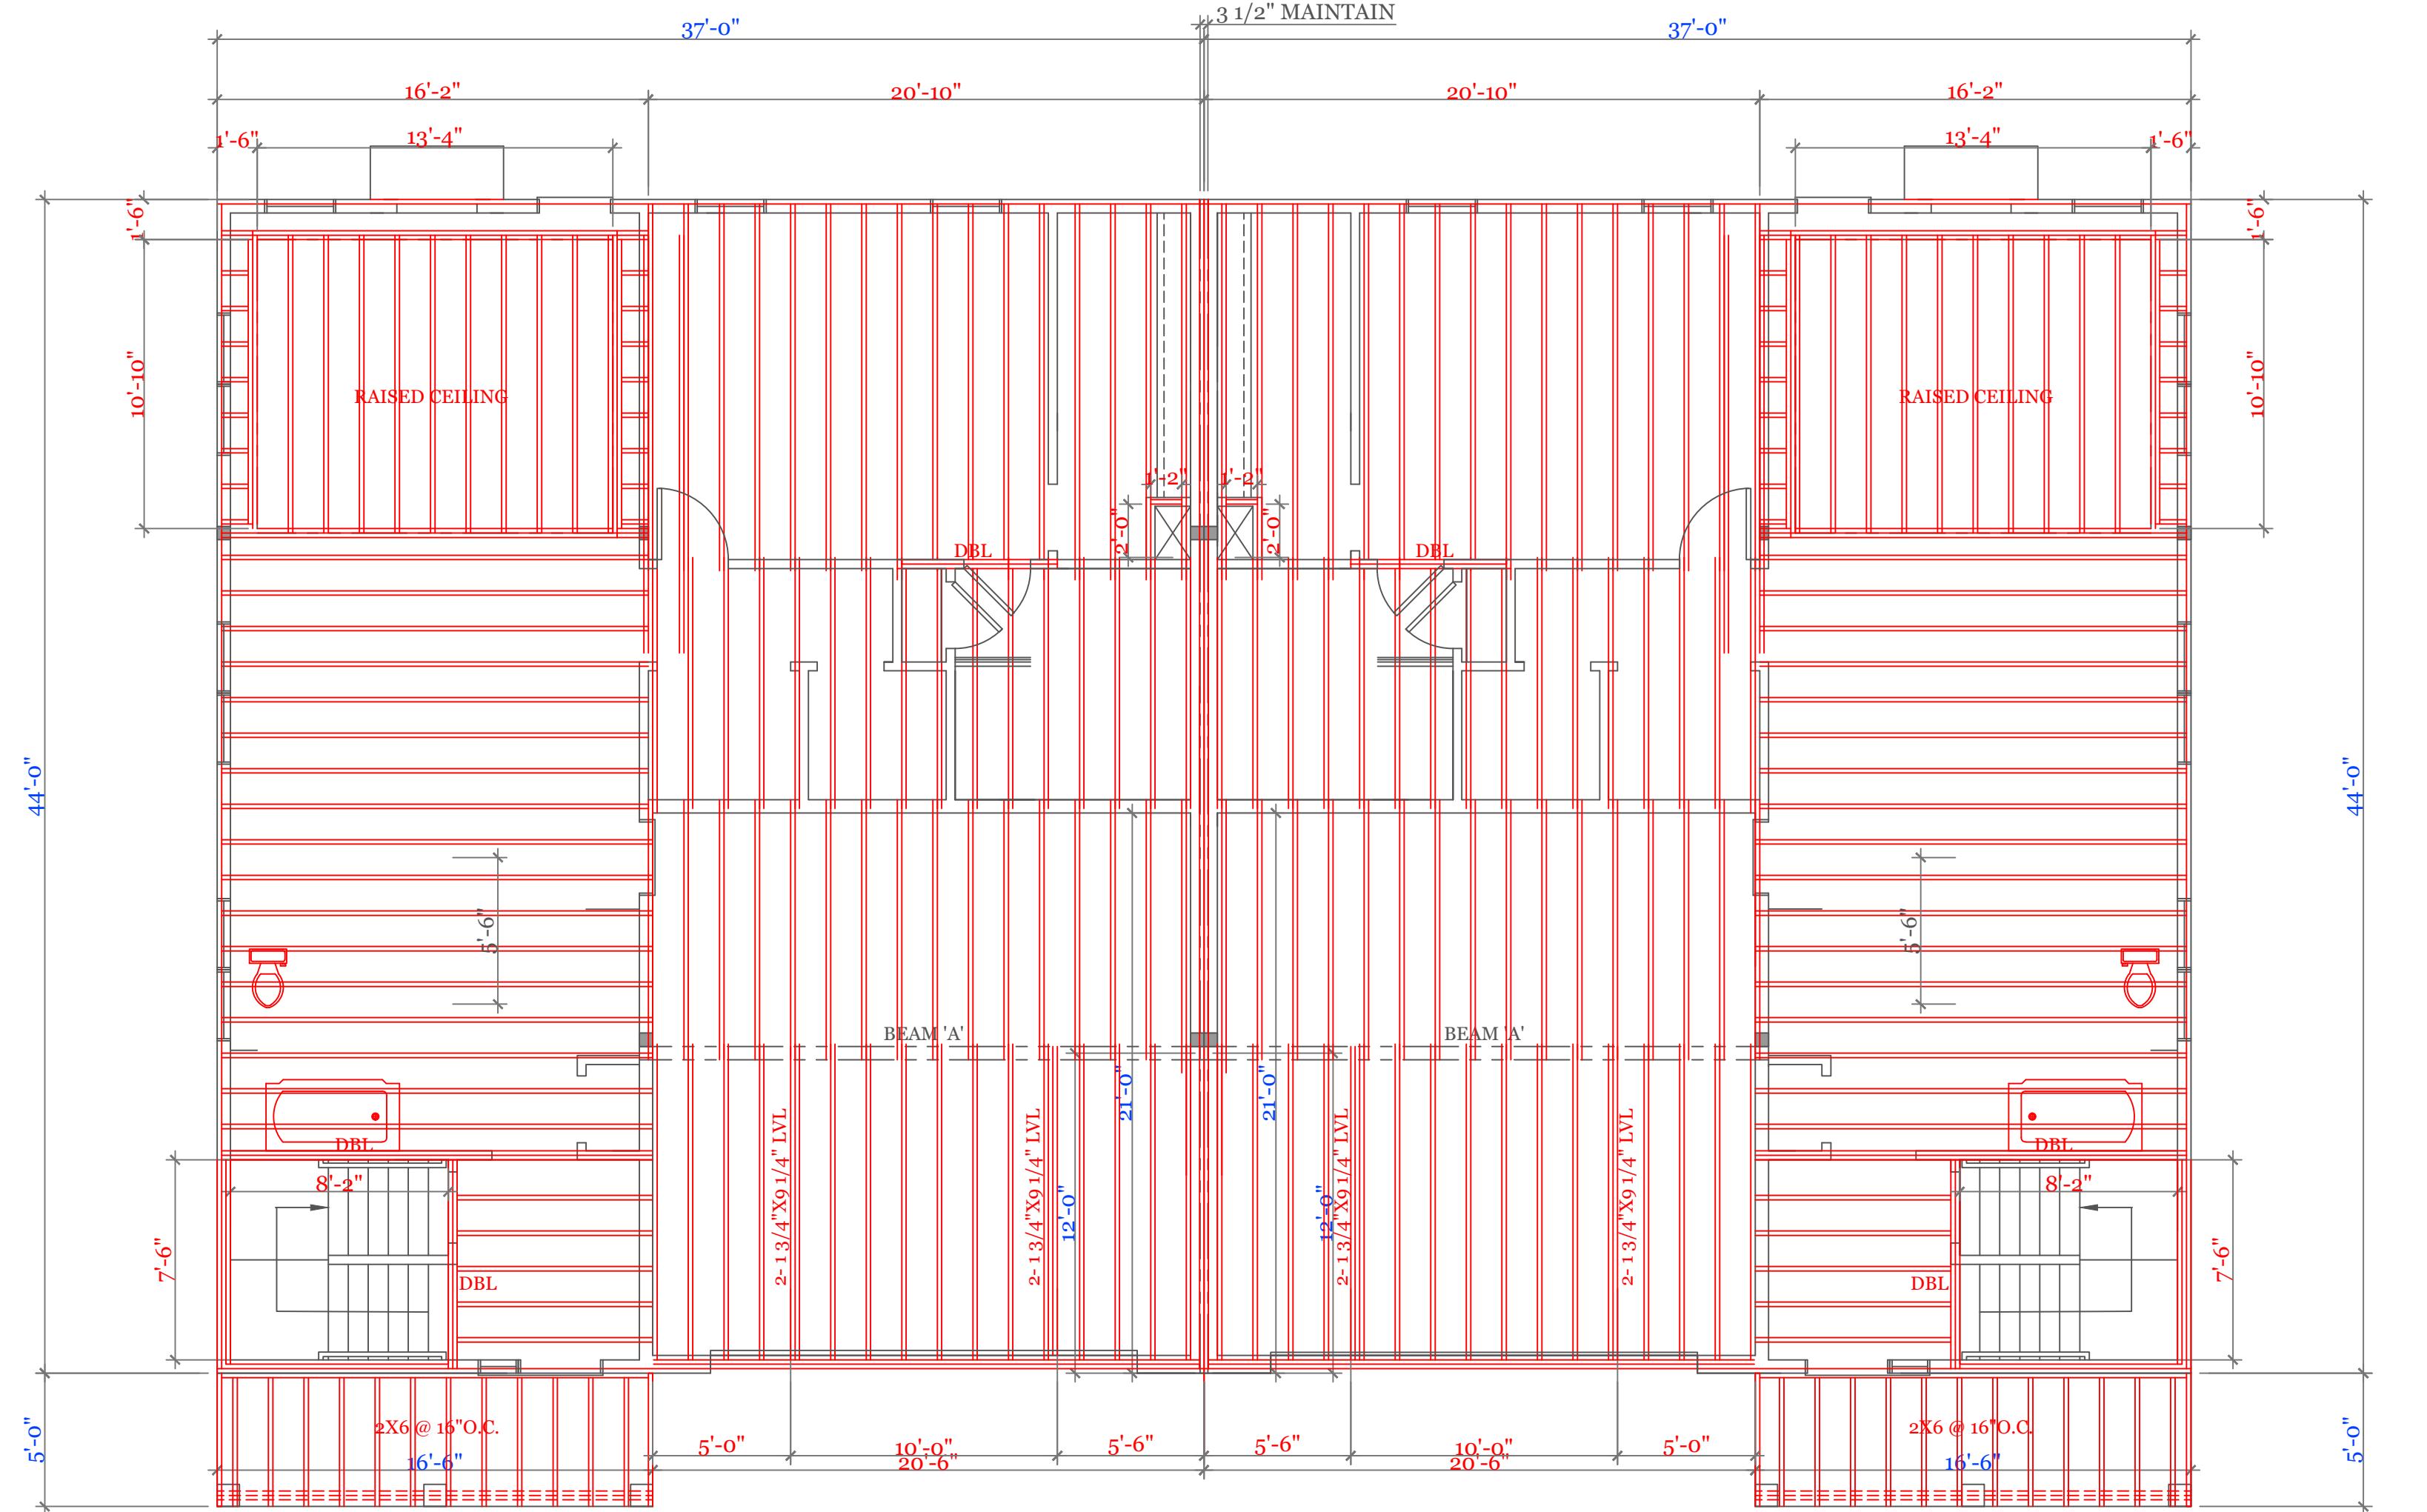■ BEARING POINTS BLOCKED TO FOUNDATION OR BEAM SUPPORT.

BEAM CALCULATIONS						
BEAM	SIZE	SPAN	LIVE LOAD	TOTAL LOAD	MAX LIVE (PLF)	MAX TOTAL (PLF)
A	5 1/4" X 14" LVL	21'-6"	240	382	334	482
B	5 1/4"X 18" LVL ROOF	21'-6"	---	840	---	1050



FIRST FLOOR FRAMING (2"X10"@16"O.C. UNLESS NOTED)
BEARING POINTS BLOCKED TO FOUNDATION OR BEAM SUPPORT. $3\frac{1}{16}'' = 1'-0''$

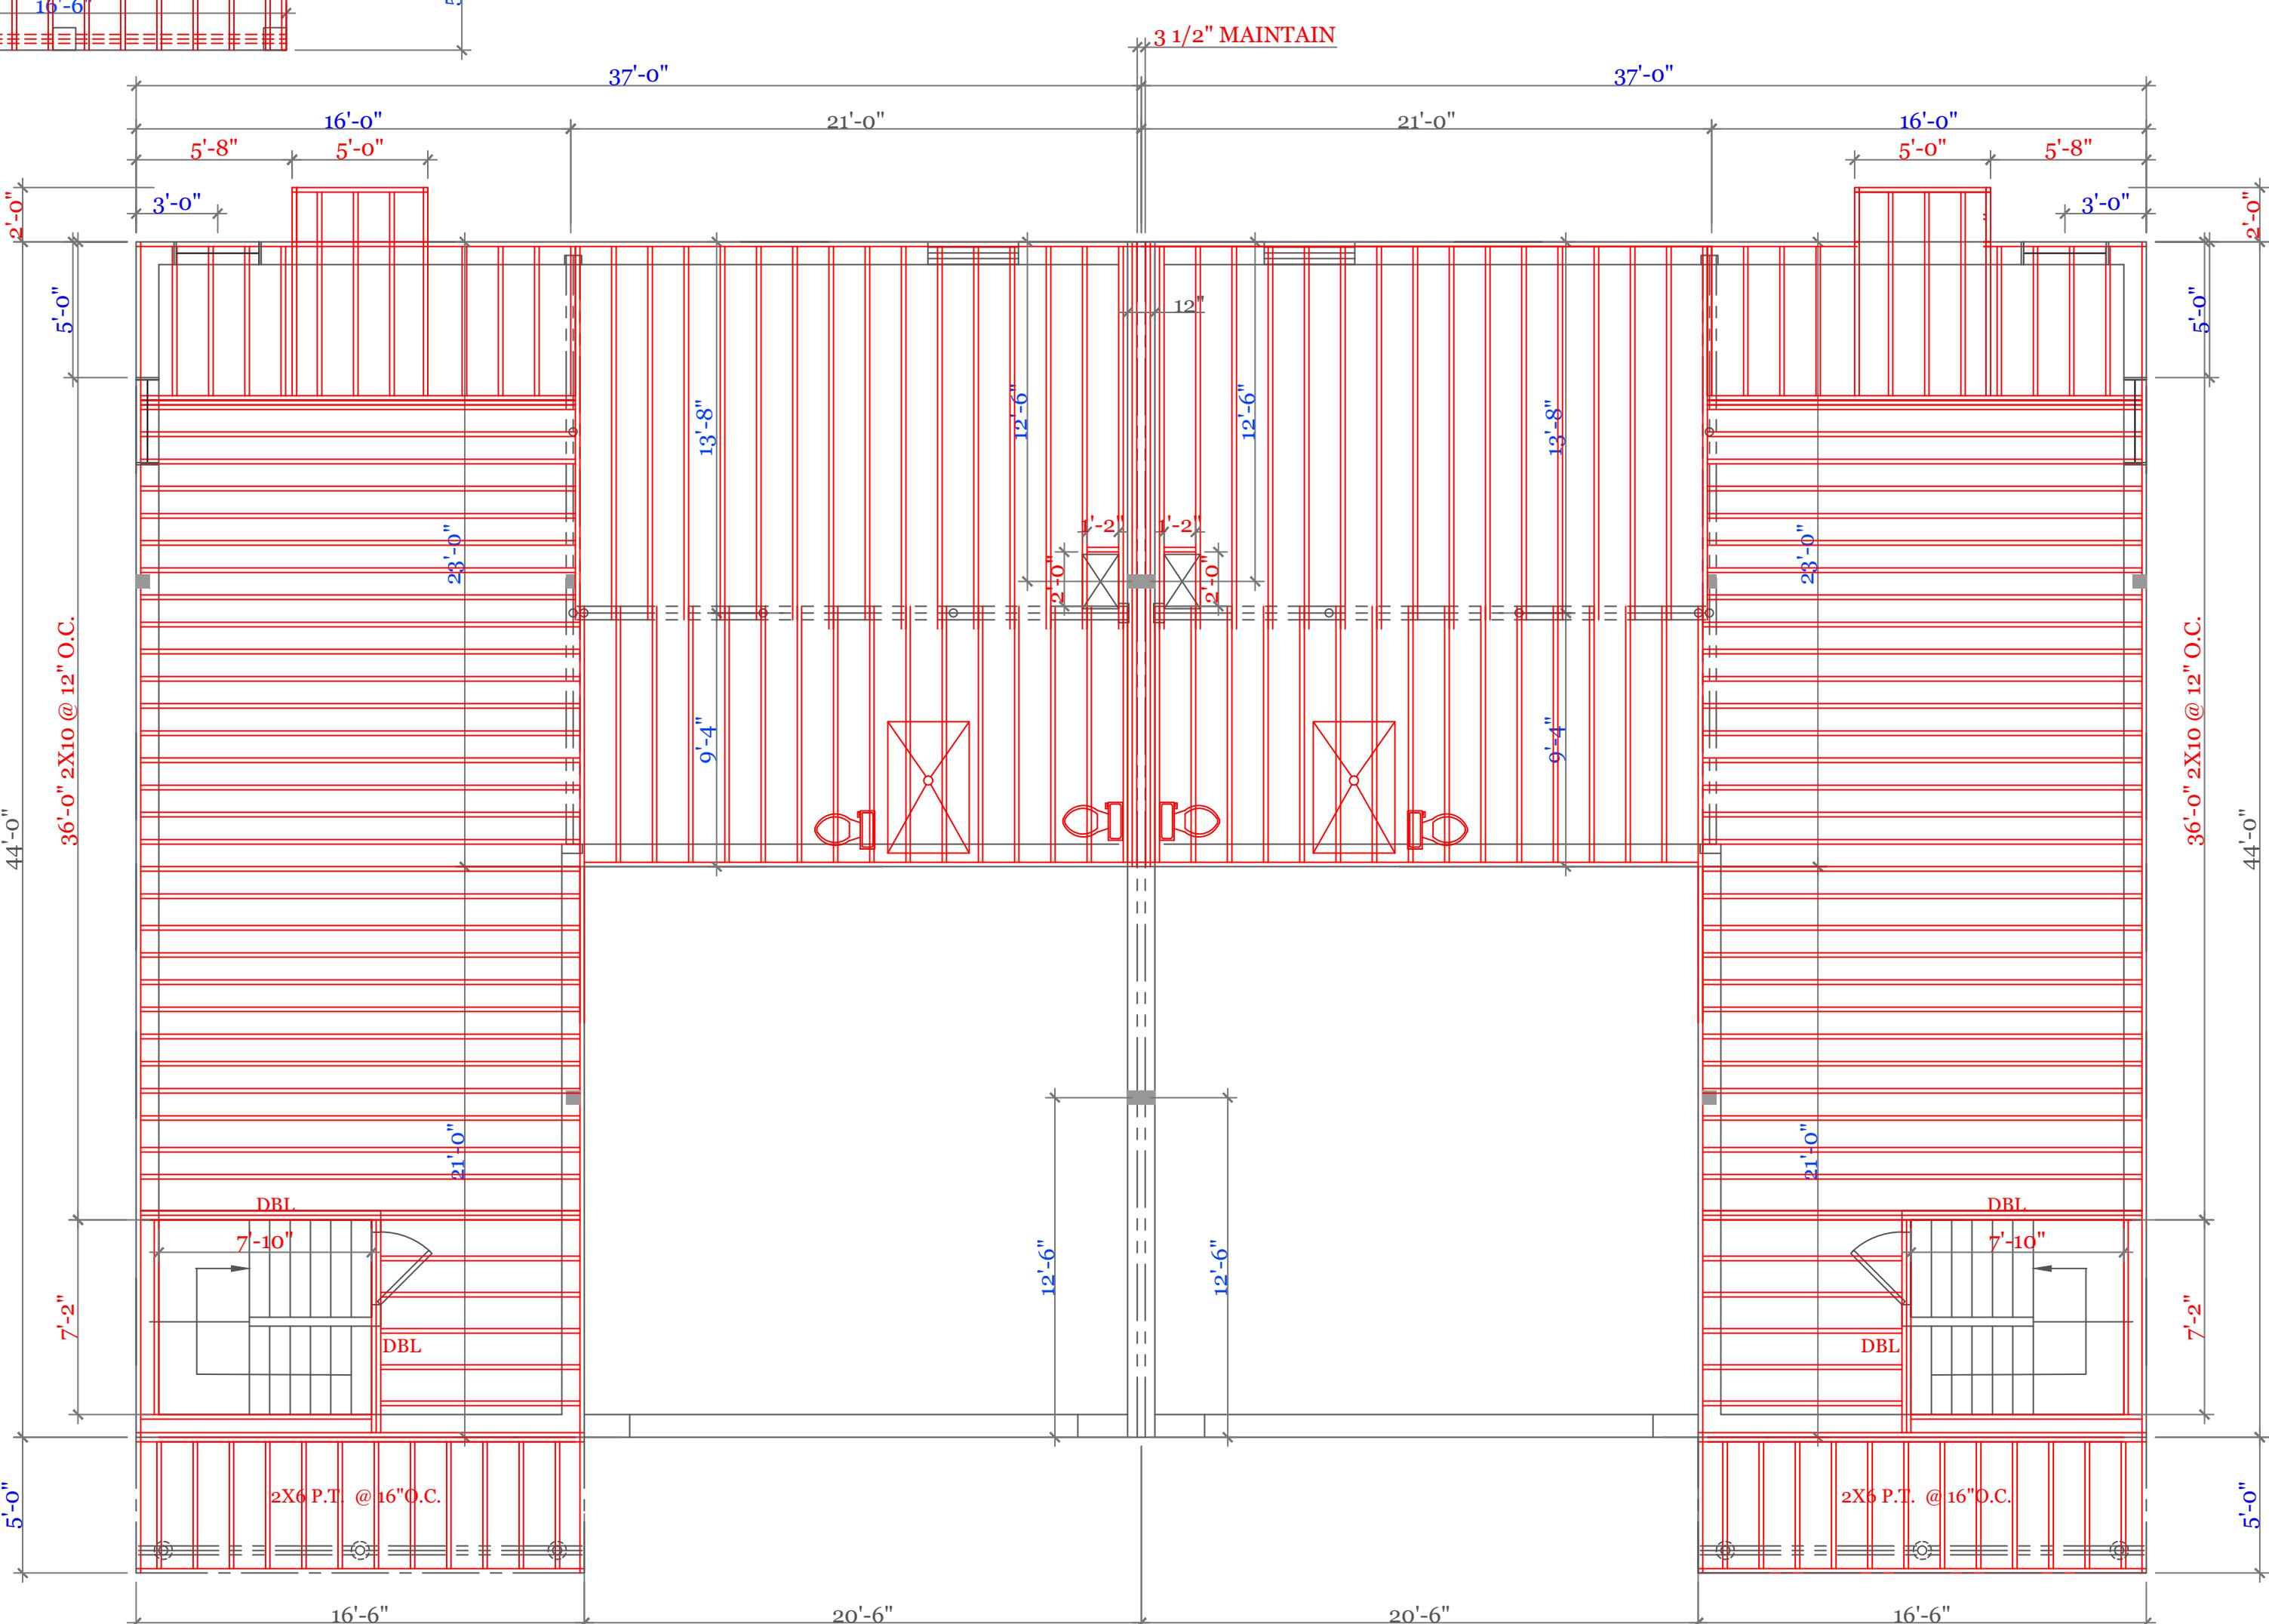NOTES:

R.C. Searles Associates

Exclusive Home Designers

Design / Build

Phone No. 17 Glenwood St.
(508) 466-3202 Holden Ma.

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WORCESTER, MA
(508)450-3461

UNIT 'C' DUPLEX HIGGINS FARM AT SALISBURY GREEN

UNIT 'C' DPLX

DATE: 9/28/2022 R5/5/23

SCALE: 3/16" = 1'-0"

DRAWN BY:

CHECKED BY: MJB


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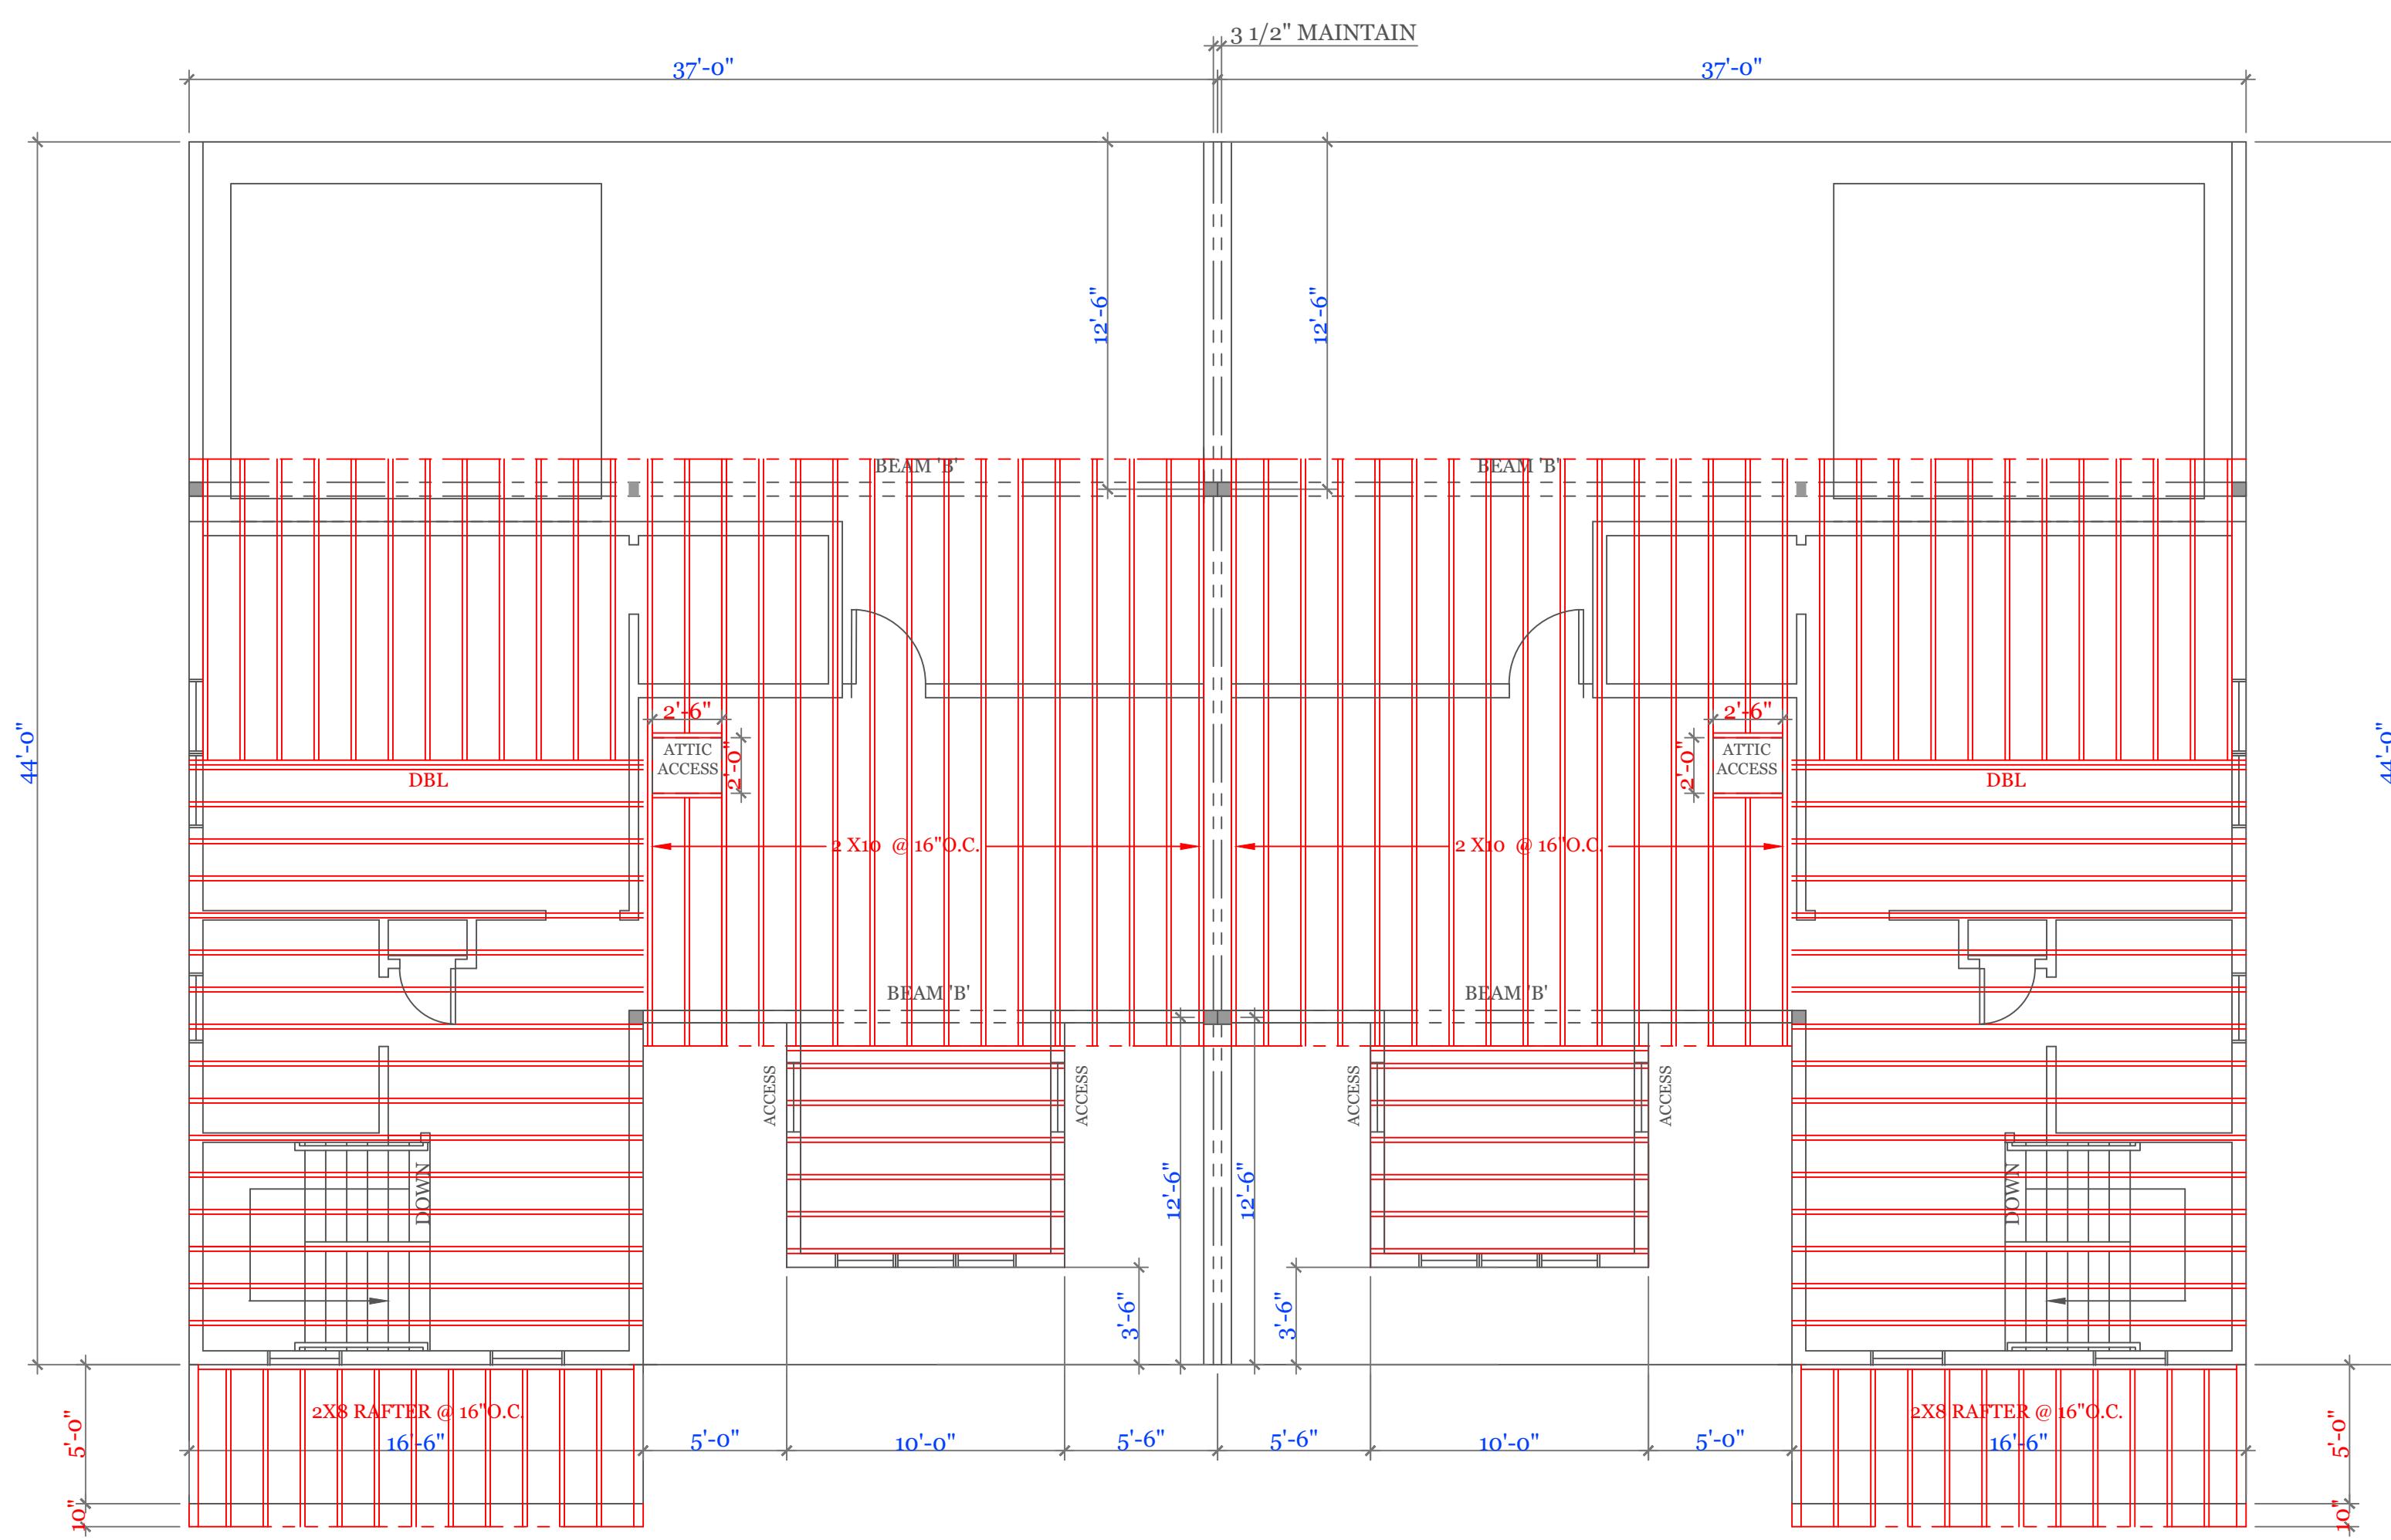
7 / 10

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NOTES:



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UNIT 'C' DUPLEX
HIGGINS FARM AT
SALISBURY GREEN

UNIT 'C' DPLX

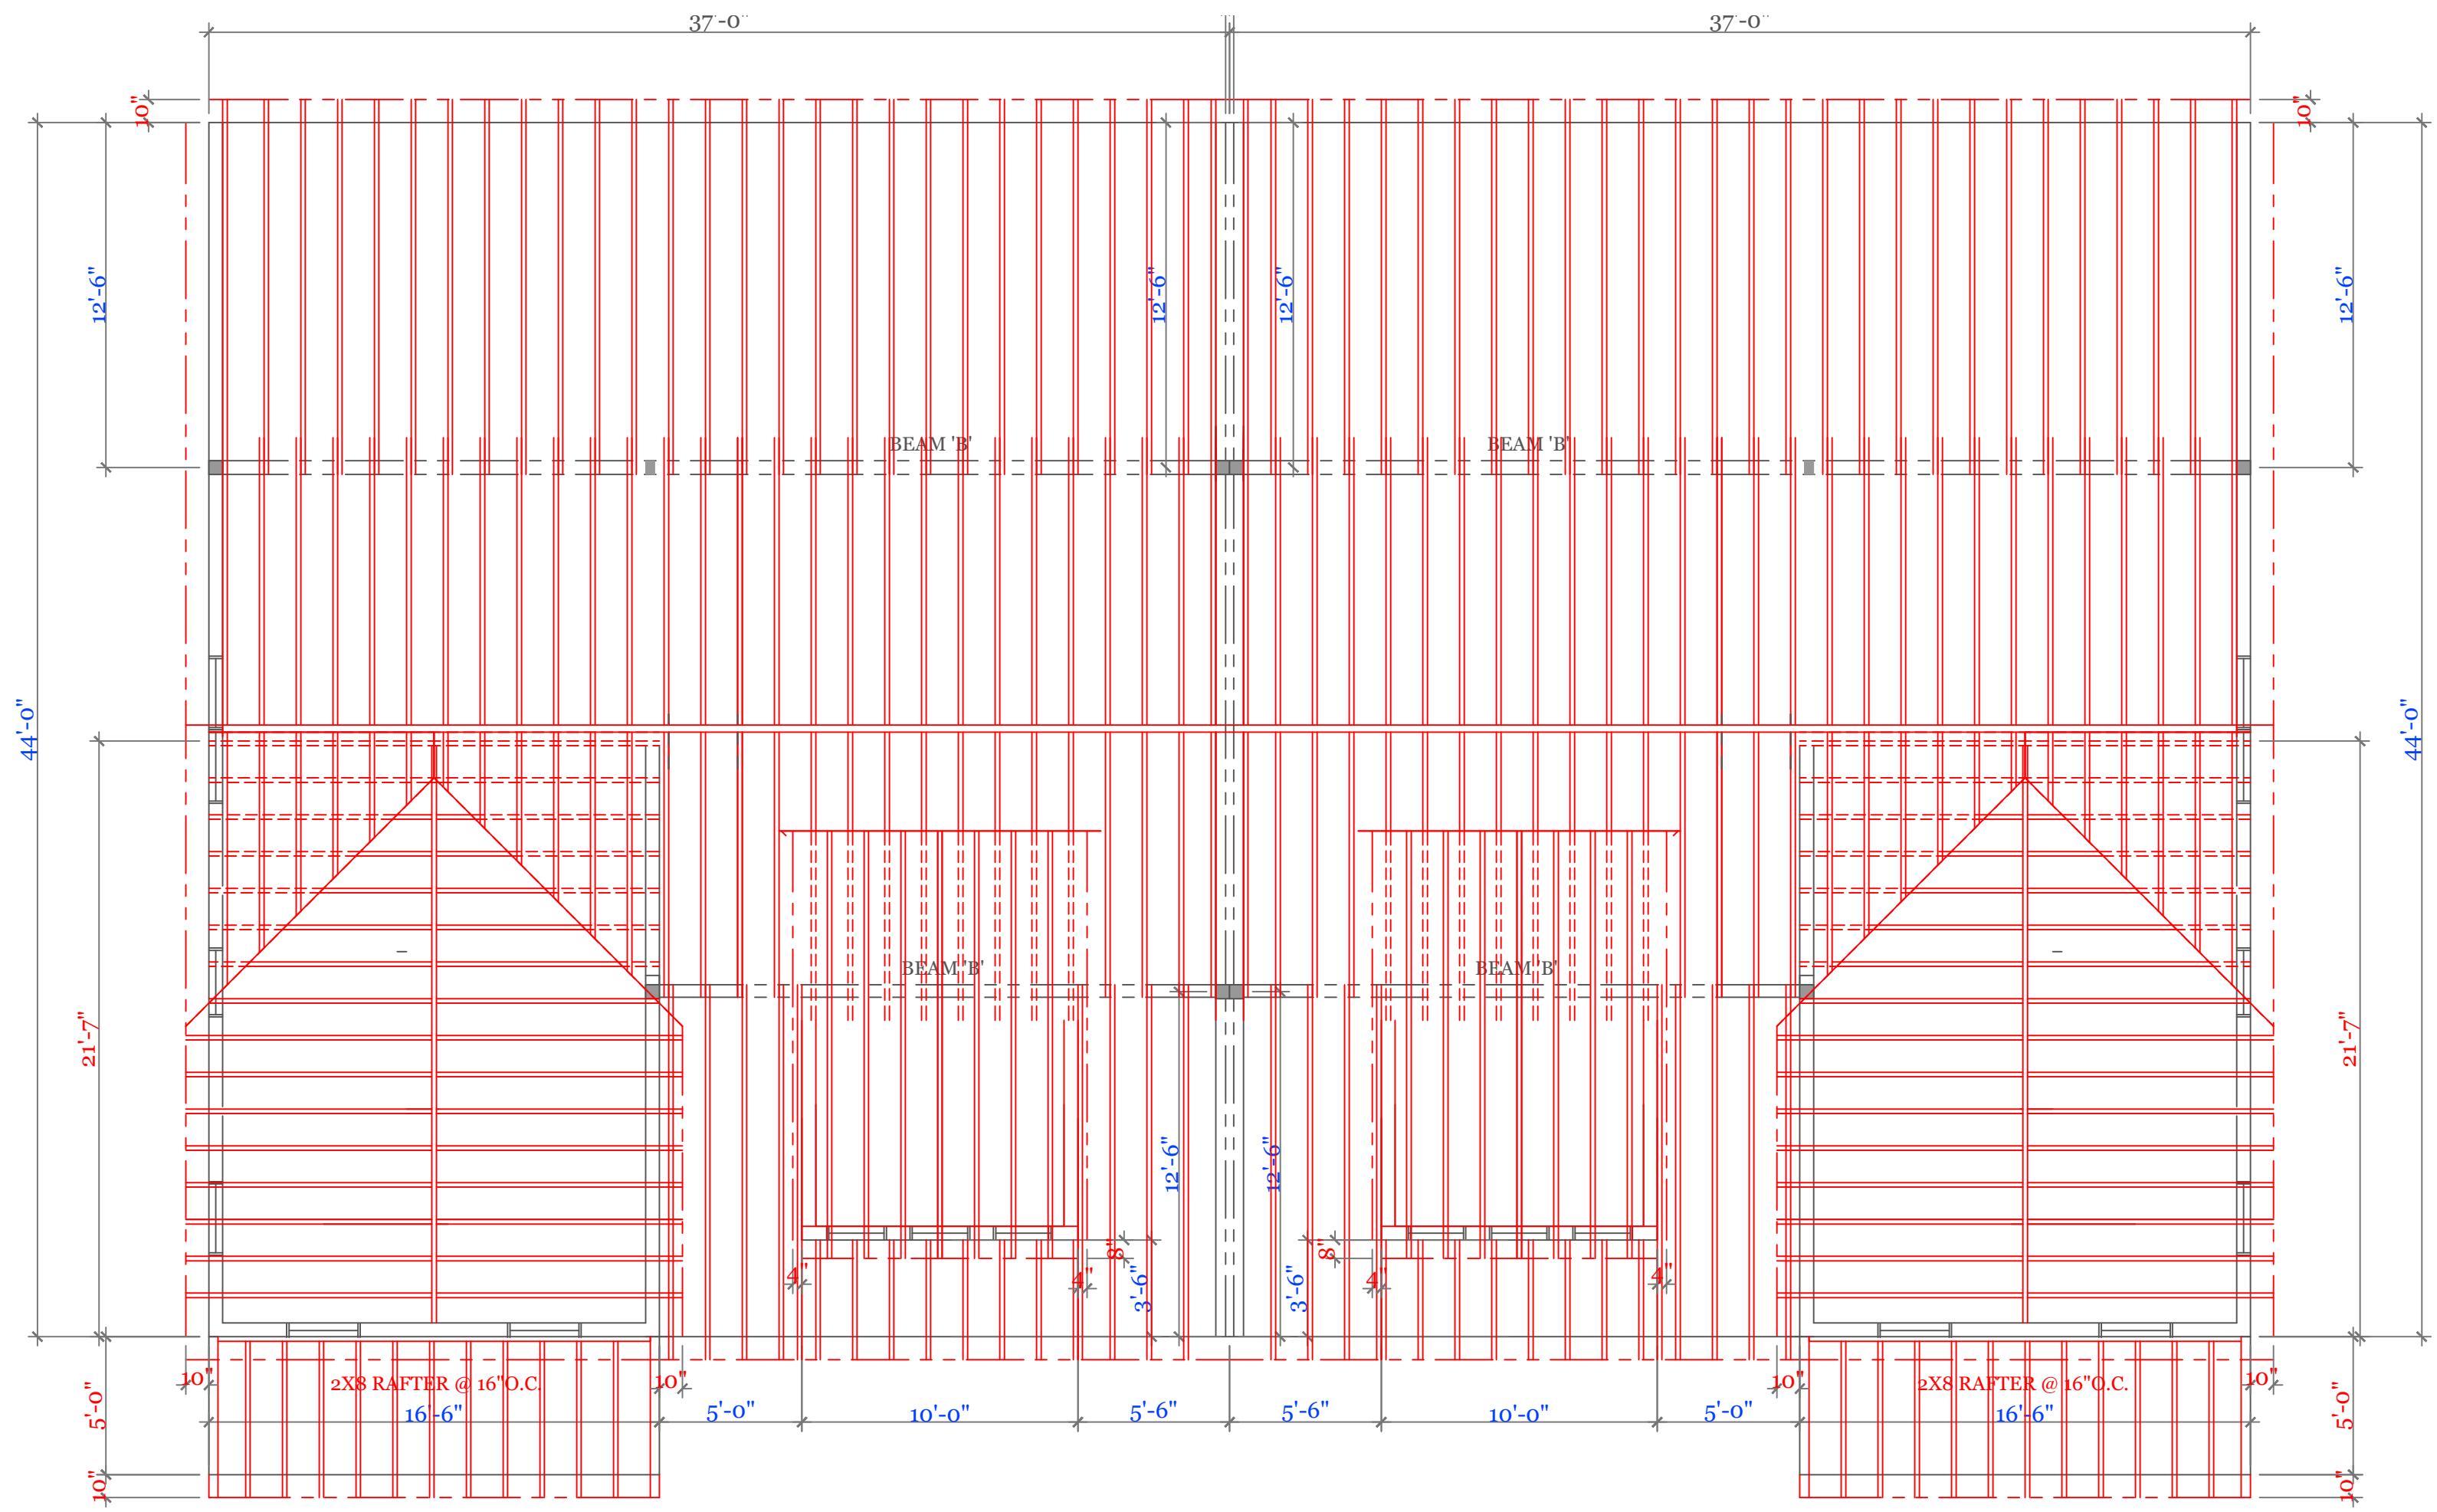DATE: 9/28/2022 R5/5/23

SCALE: 3/16" = 1'-0"

DRAWN BY: RCS


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8 OF 8


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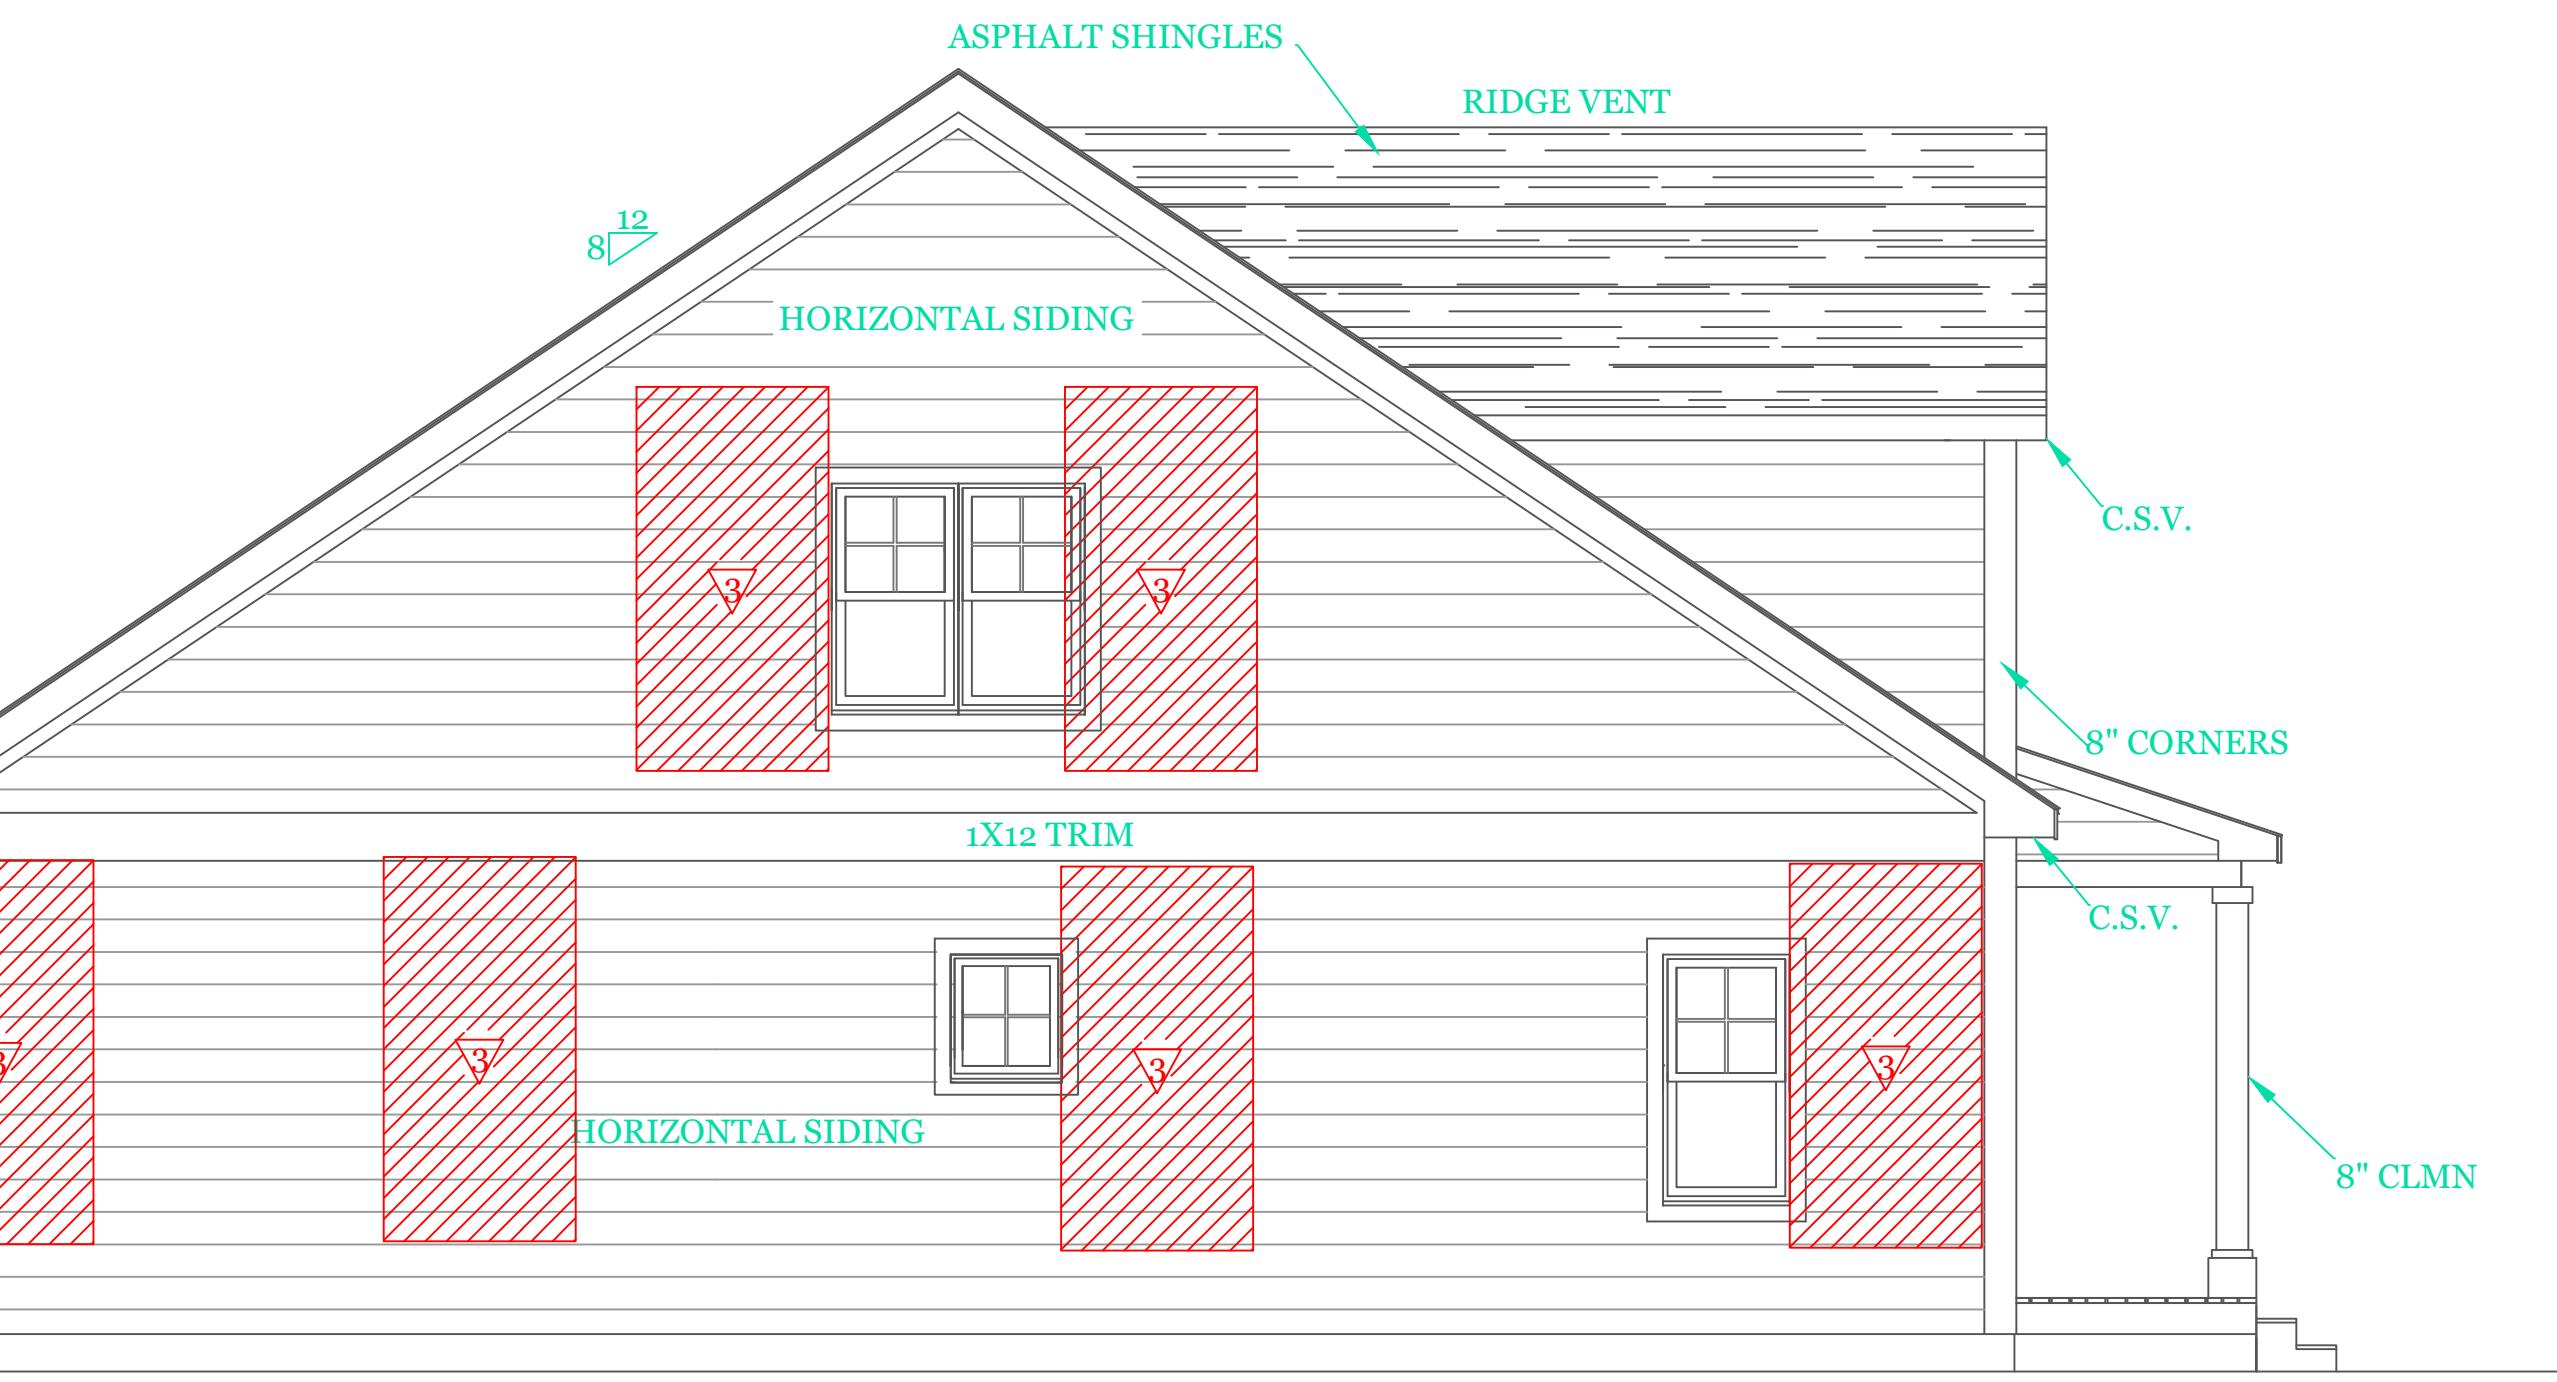


FRONT ELEVATION (1734 s.f.)


1/4"=1'-0"
WOOD STRUCTURAL PANEL 15/32 CDX PLY WD. SHEATHING ON 16"
STUD SPACING PANELS INSTALLED VERTICALLY
W/ 6d COMMON NAIL 6" O.C. @ EDGES & 12" O.C. INTERMEDIATE
SUPPORTS

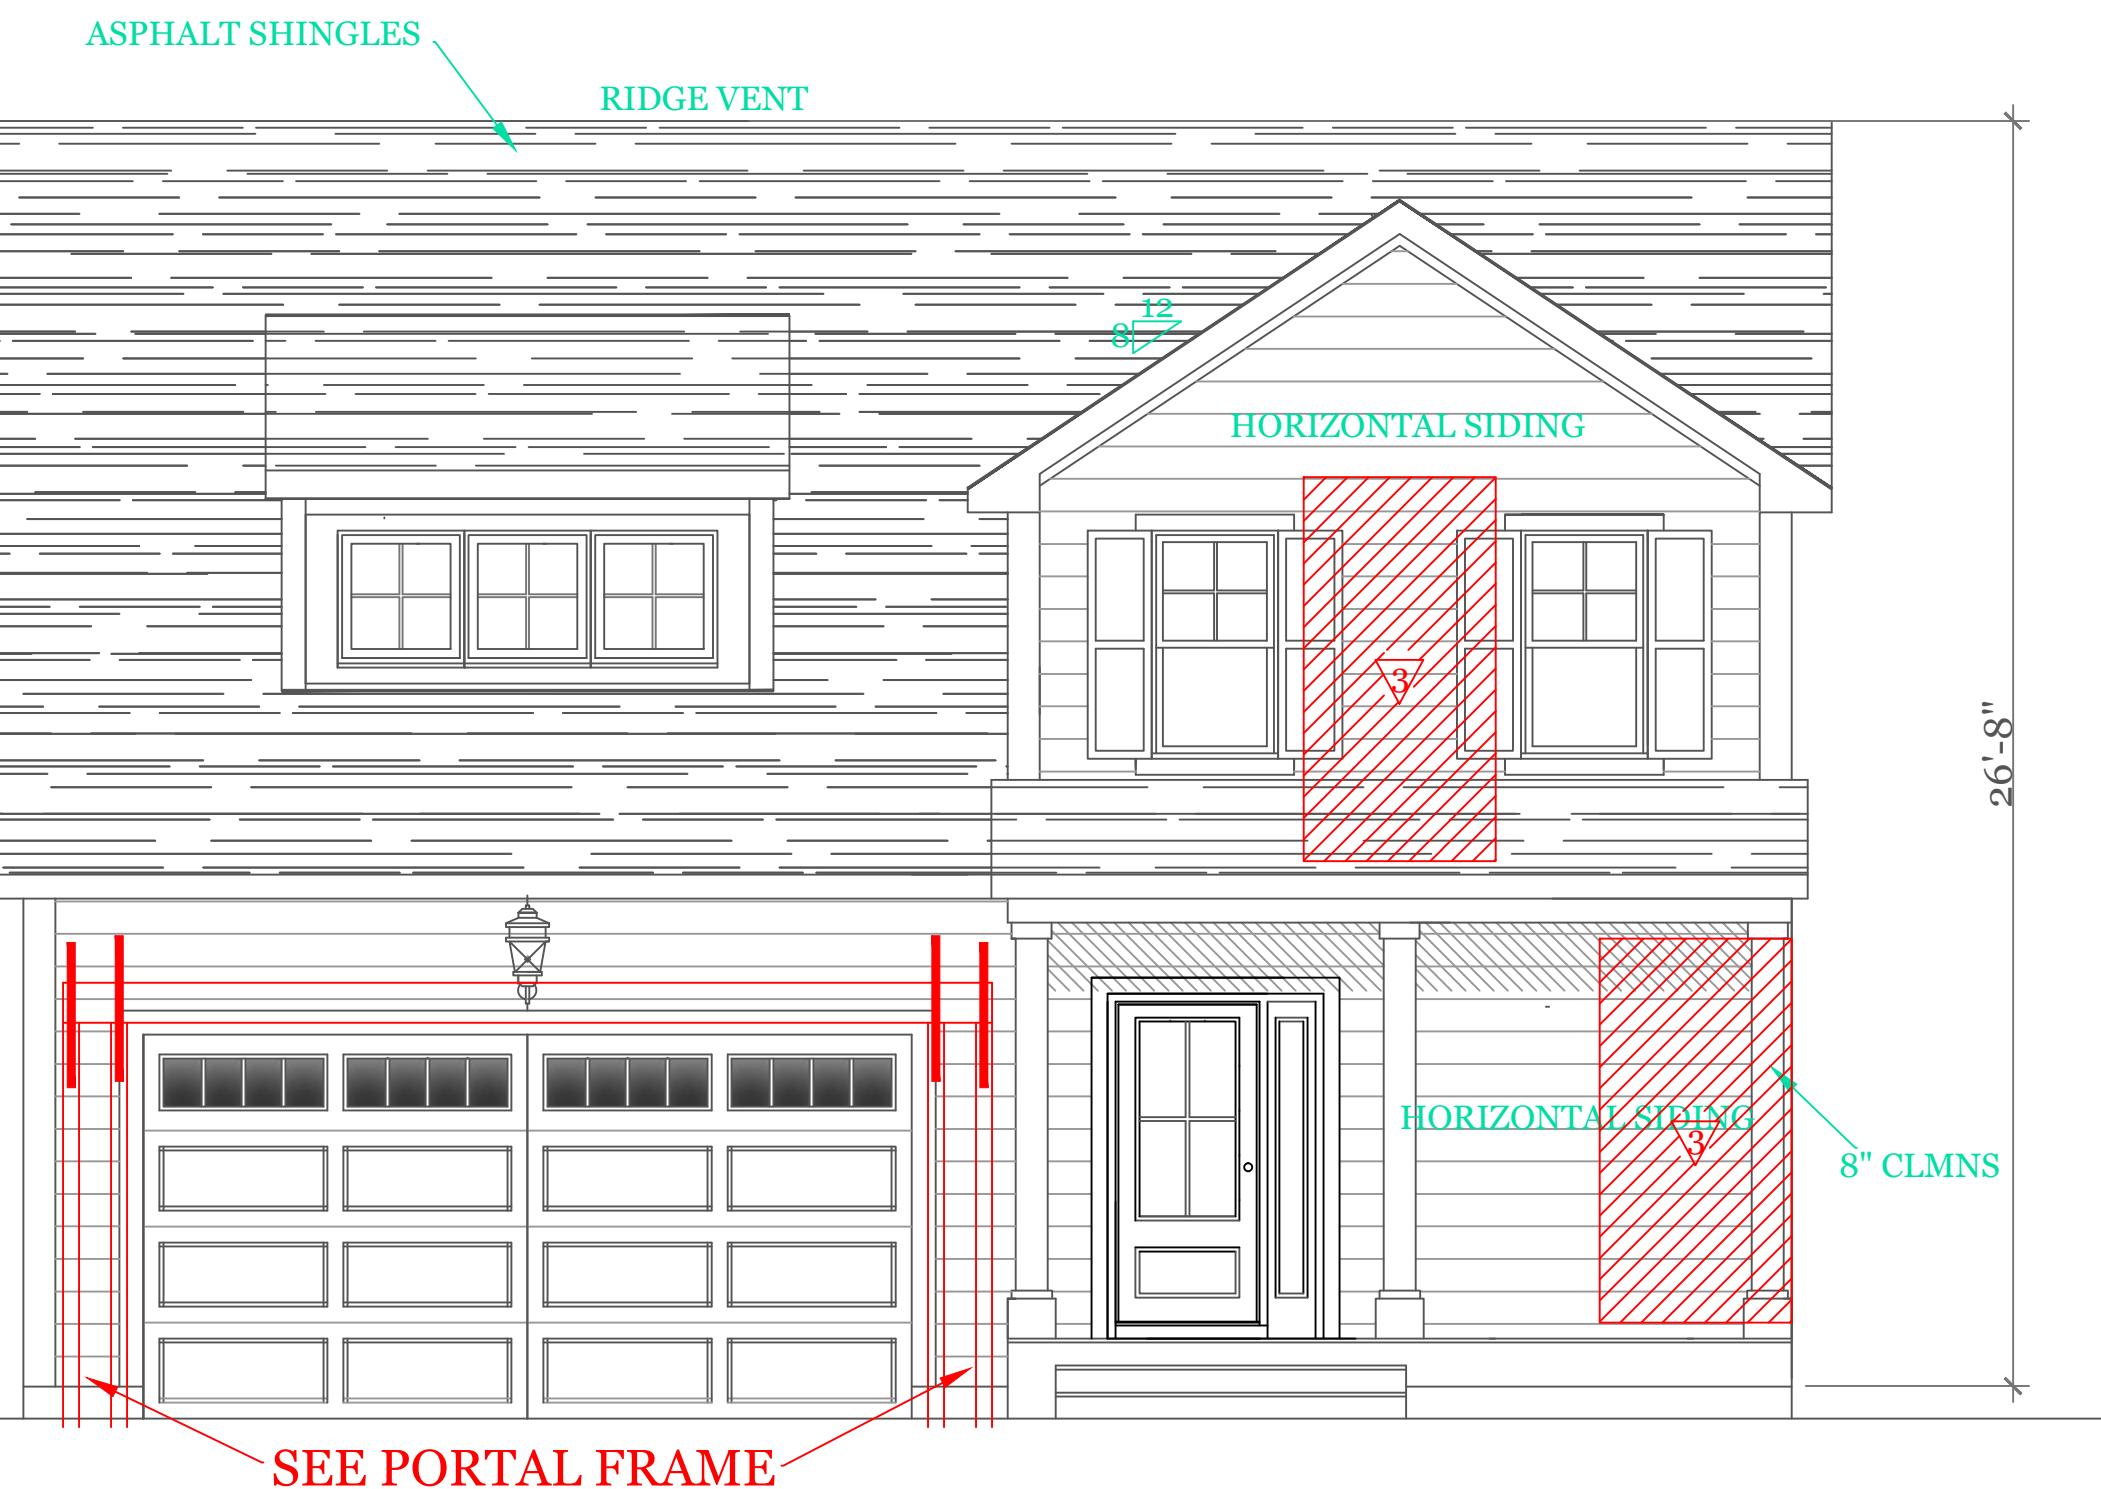

RIGHT SIDE ELEVATION

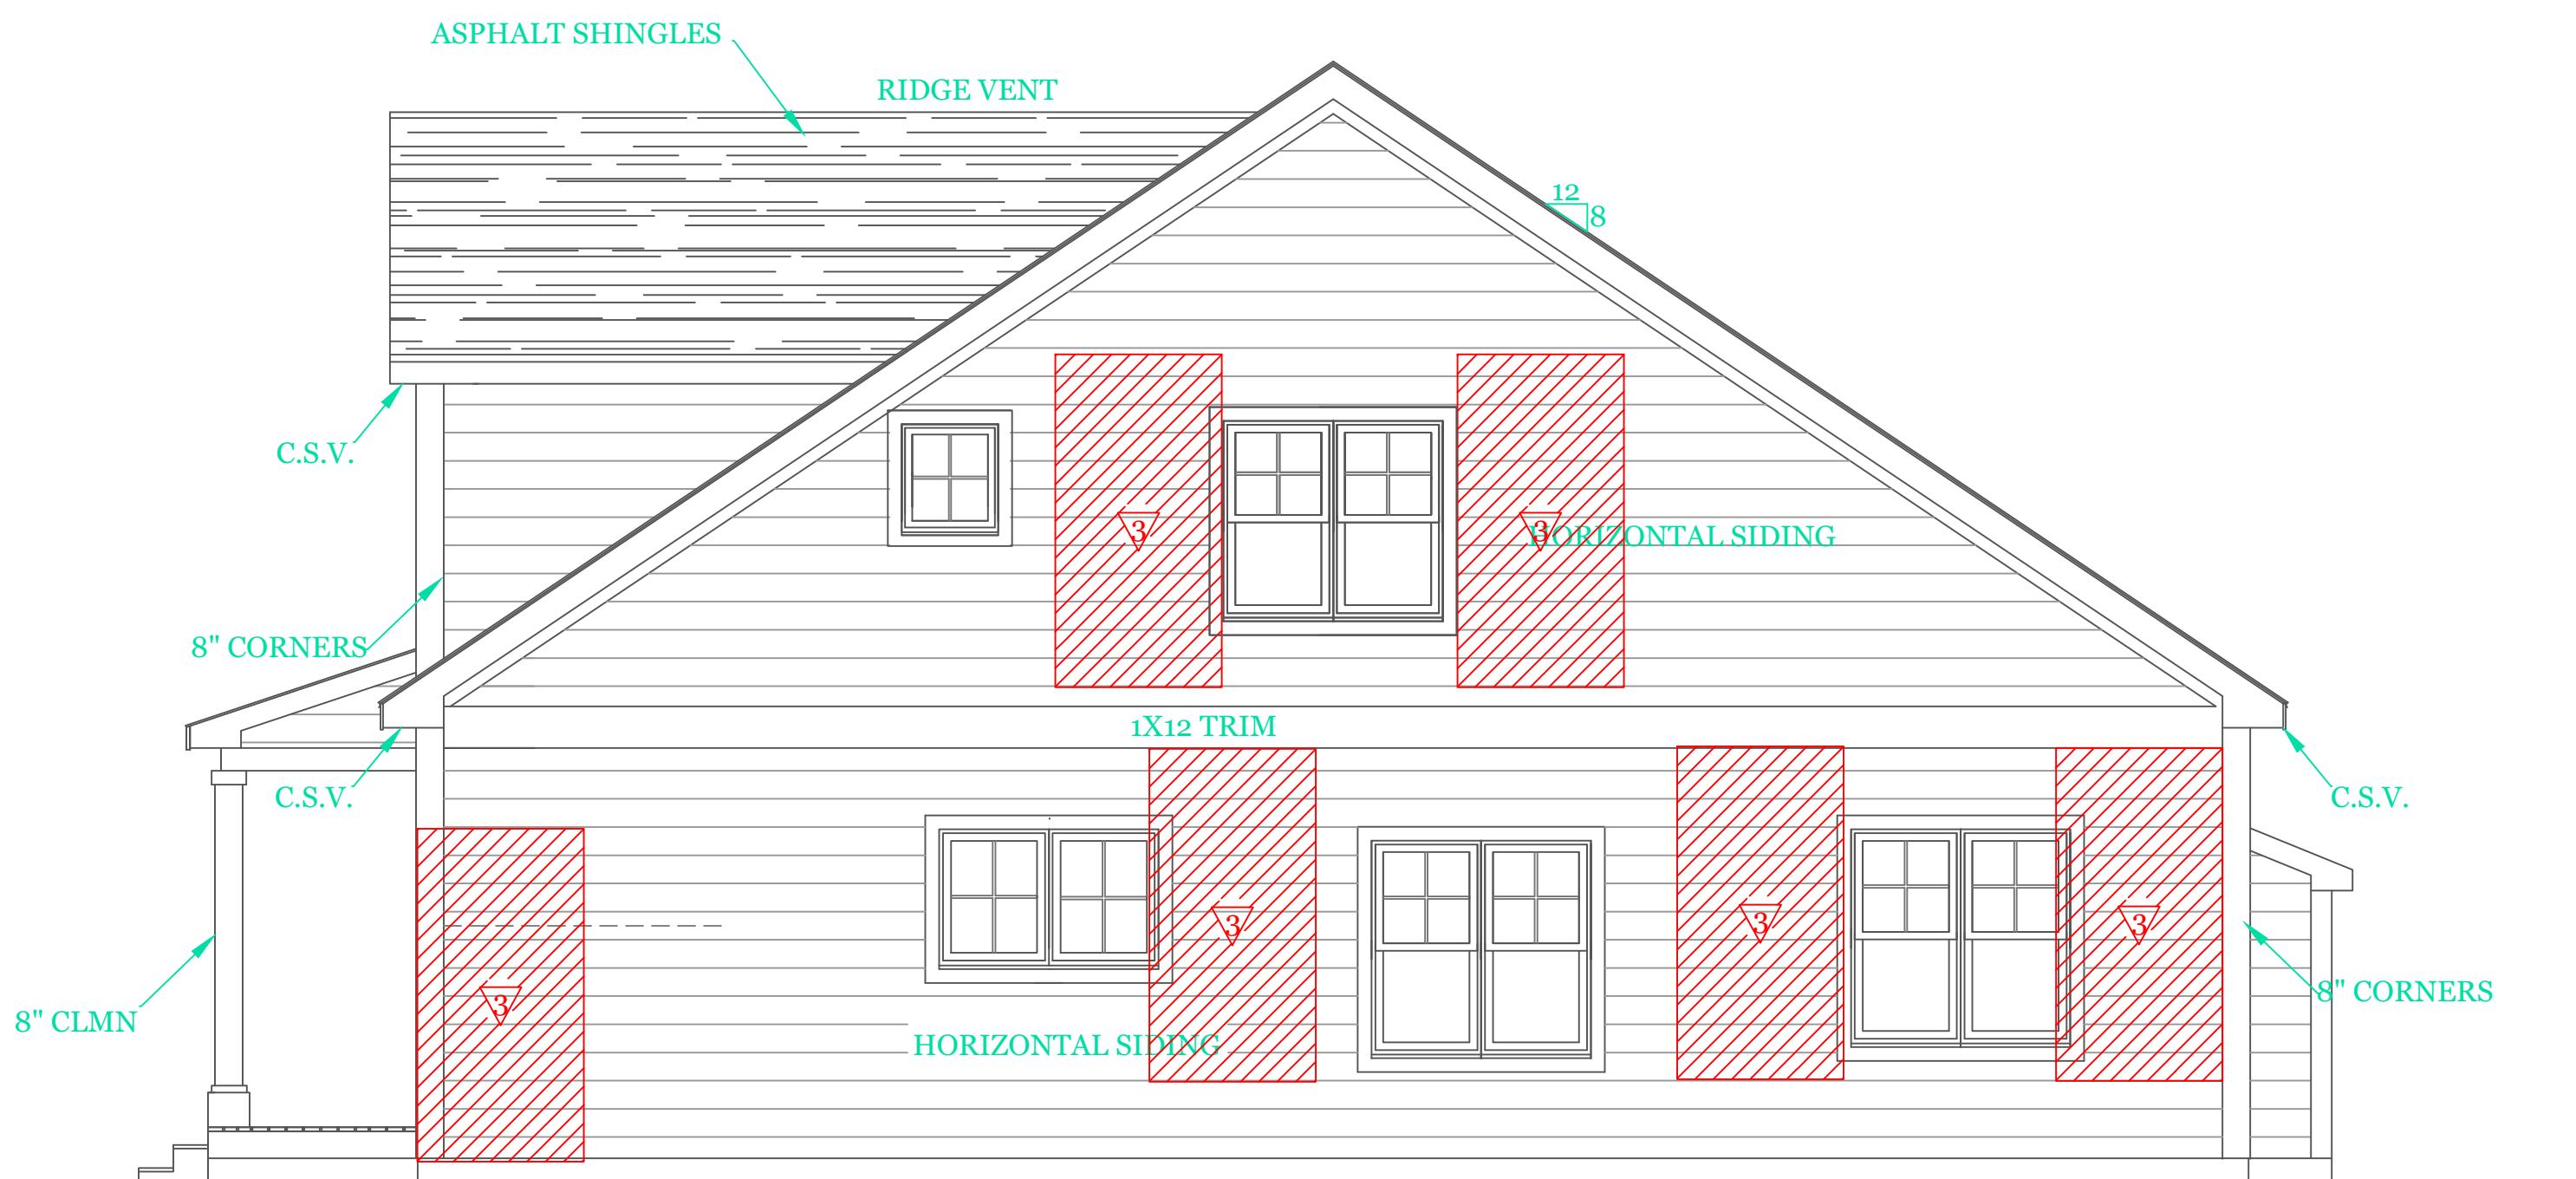

LEFT SIDE ELEVATION

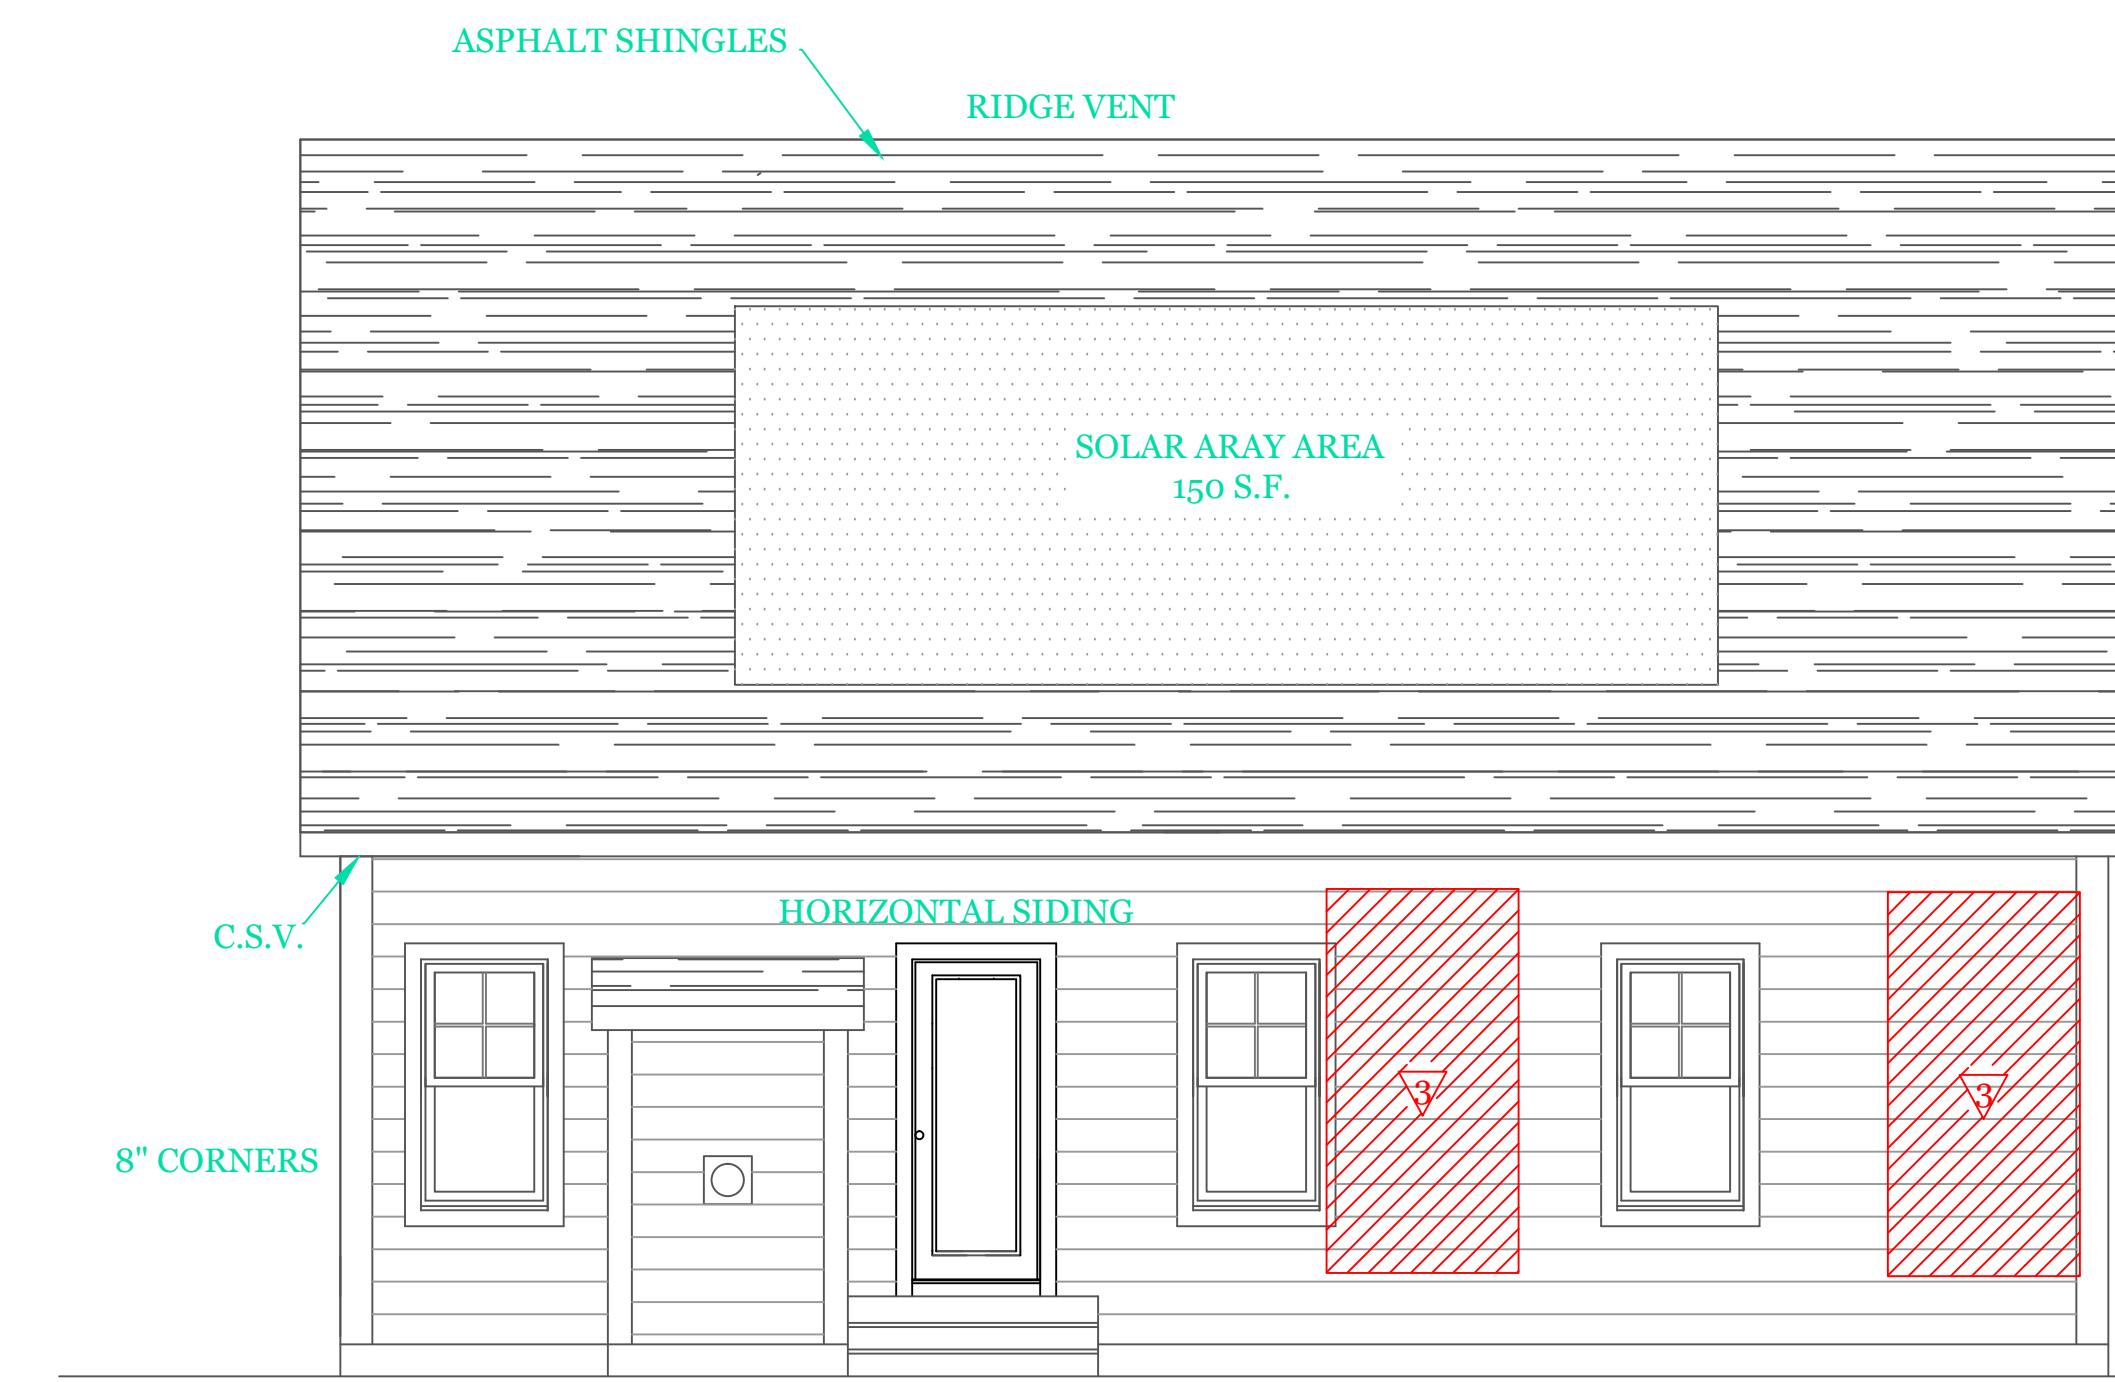

REAR ELEVATION

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ELEVATIONS

UNIT 'C' 1734 S.F. HIGGINS FARM AT SALISBURY HILL
UNIT 'C' GL
DATE: 9/28/2022 R5/5/23
SCALE: 1/4"=1'-0"
DRAWN BY: RCS
CHECKED BY: MJB


Sheet 1 OF 5

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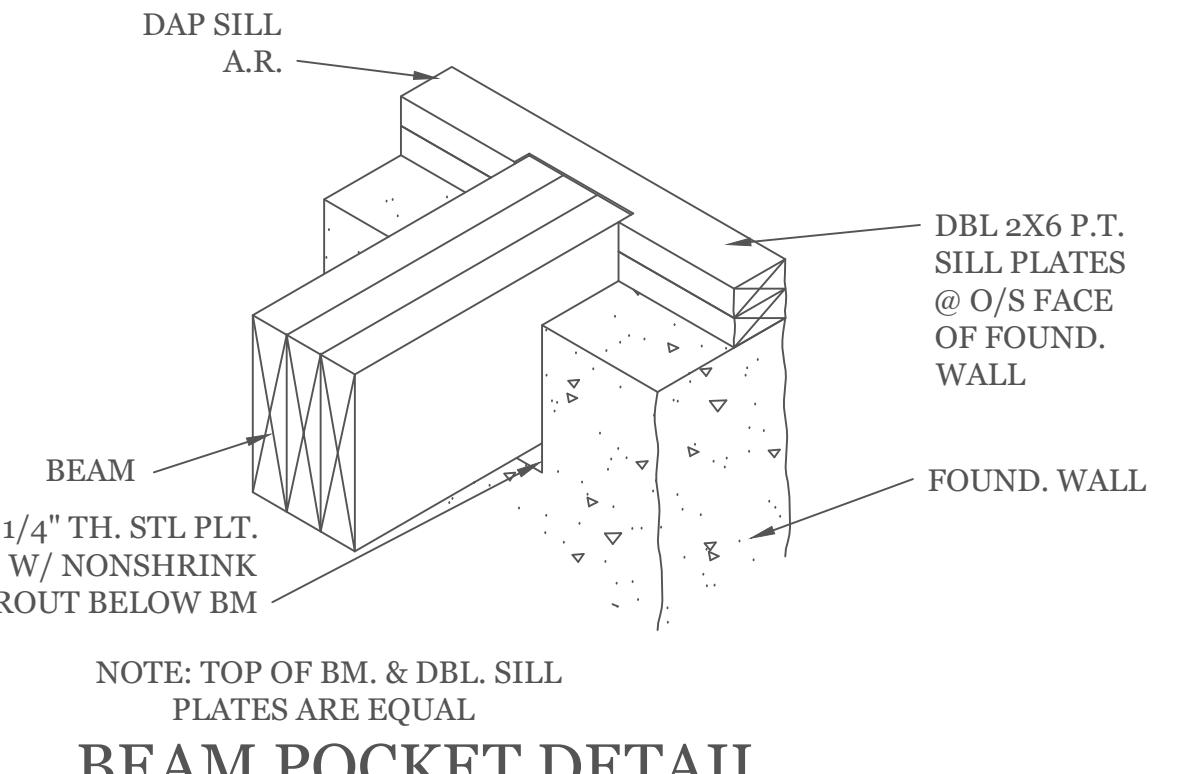
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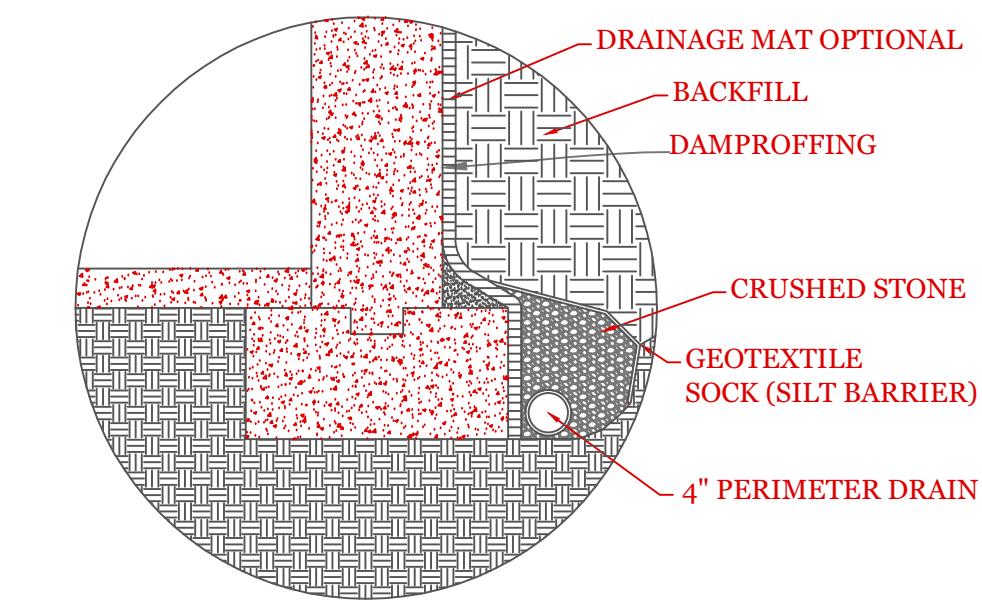
TYPICAL FOUNDATION DETAILS



CONCRETE TUBE DETAIL

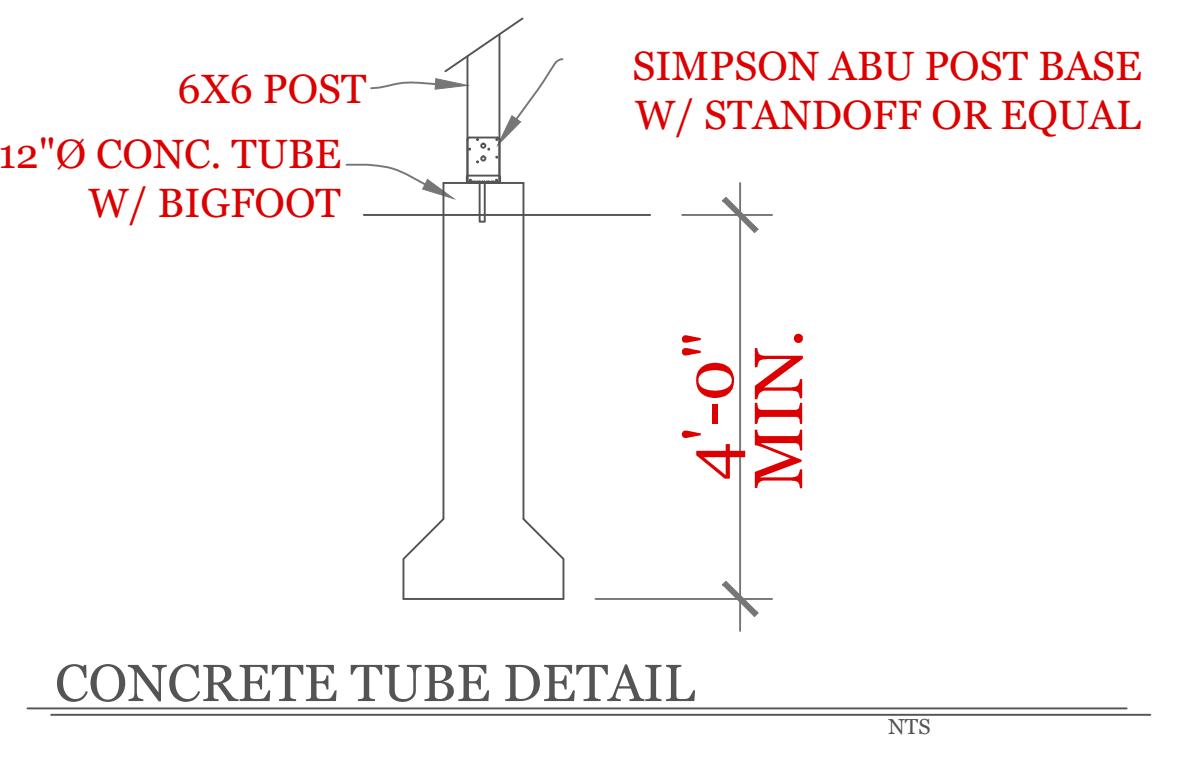


BEAM POCKET DETAIL



TYP. PERIMETER DRAIN DETAIL

NOTE: SLOPE DRAIN TO SUMP OR OUTFALL

NTS

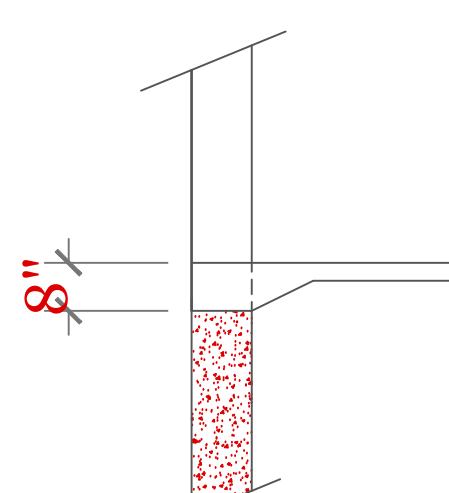


GARAGE FLOOR @ O.H.D.

3/8" = 1'-0"


SYMBOL SCHEDULE;

- V VENT
- SC SMOKE AND CARBON DETECTOR
- S SMOKE DETECTOR
- H HEAT DETECTOR
- BEARING POINT W/ SQUASH BLOCK

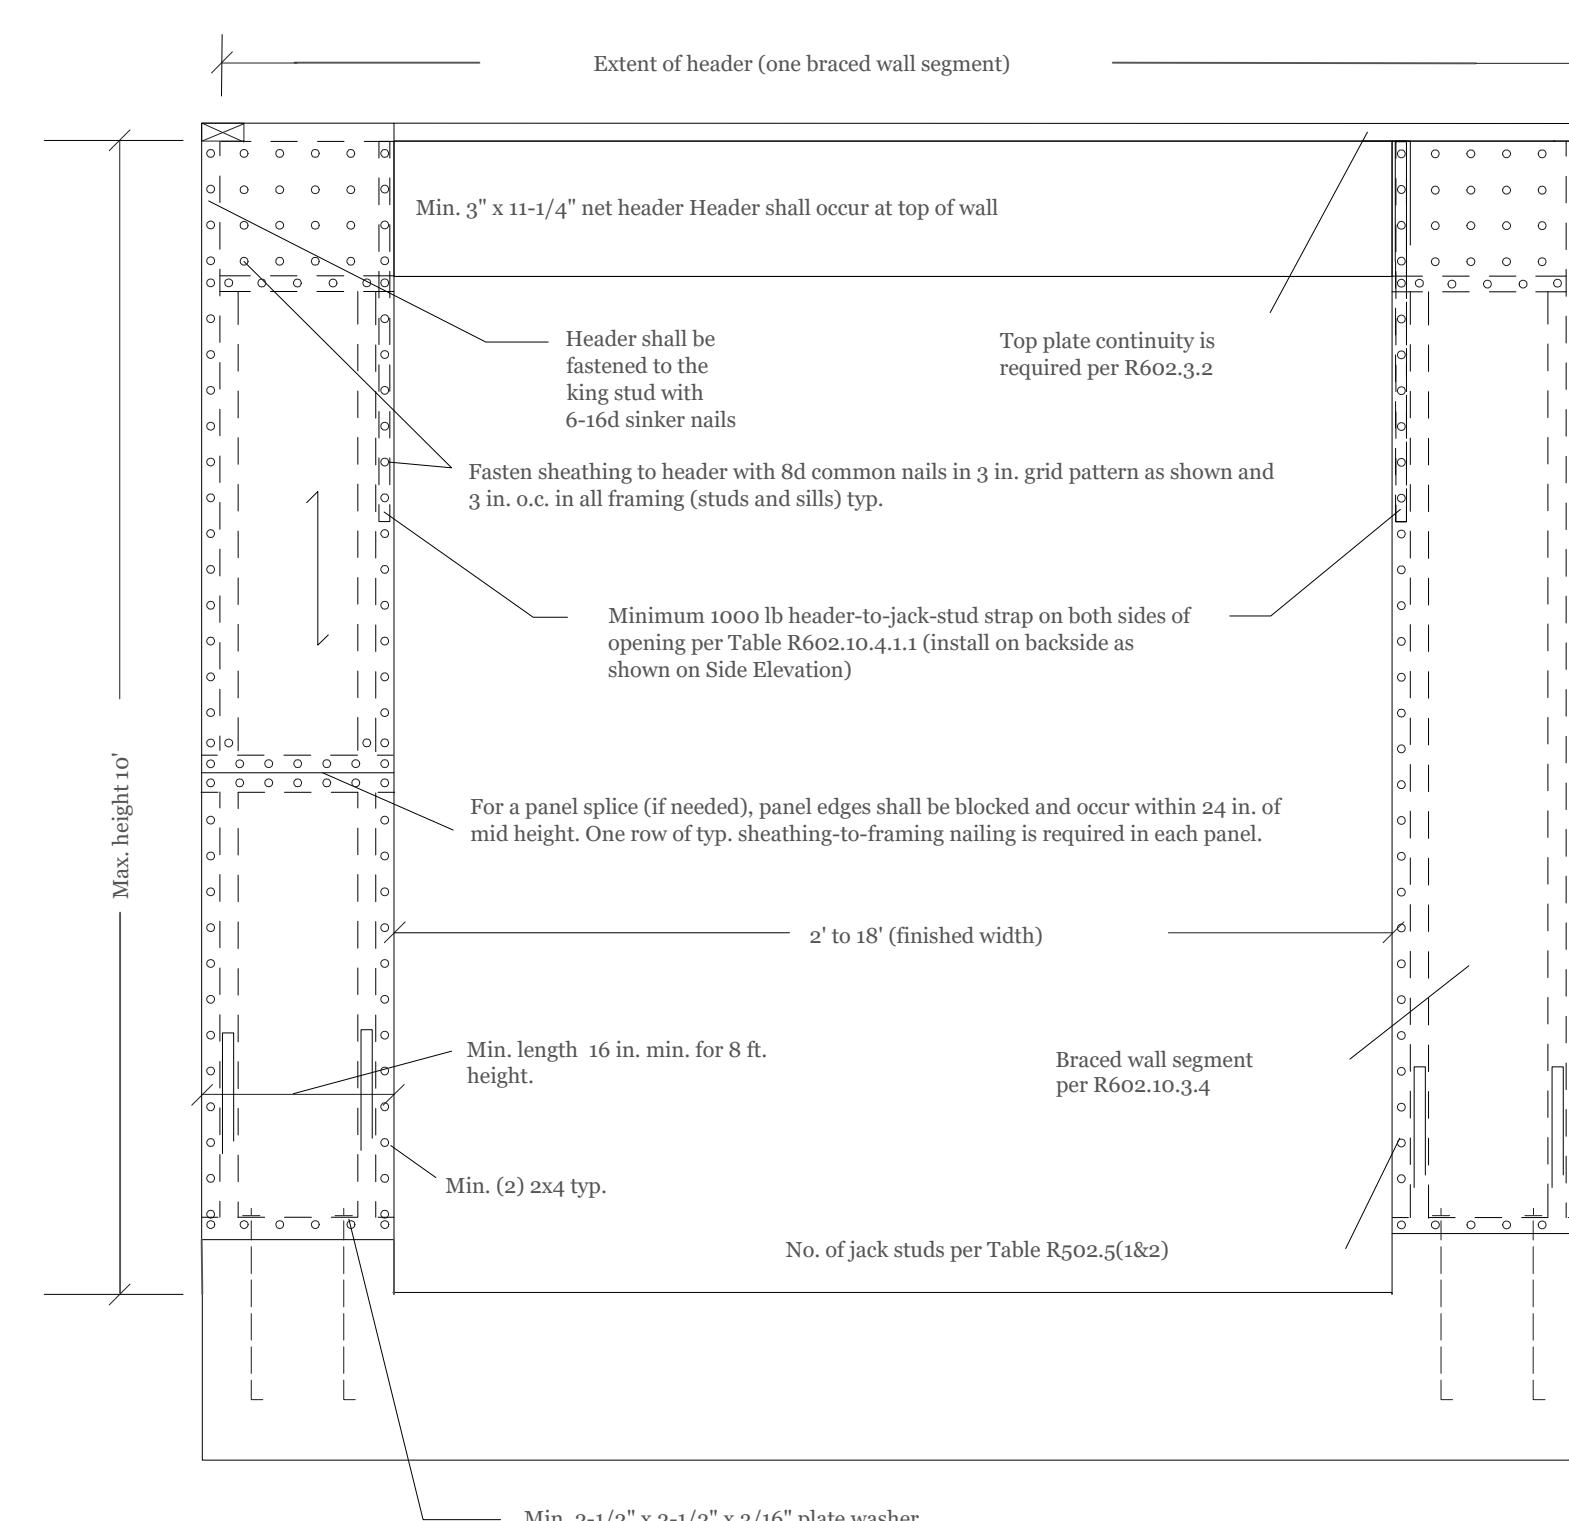

OUTSIDE ELEVATION PORTAL FRAME

NTS

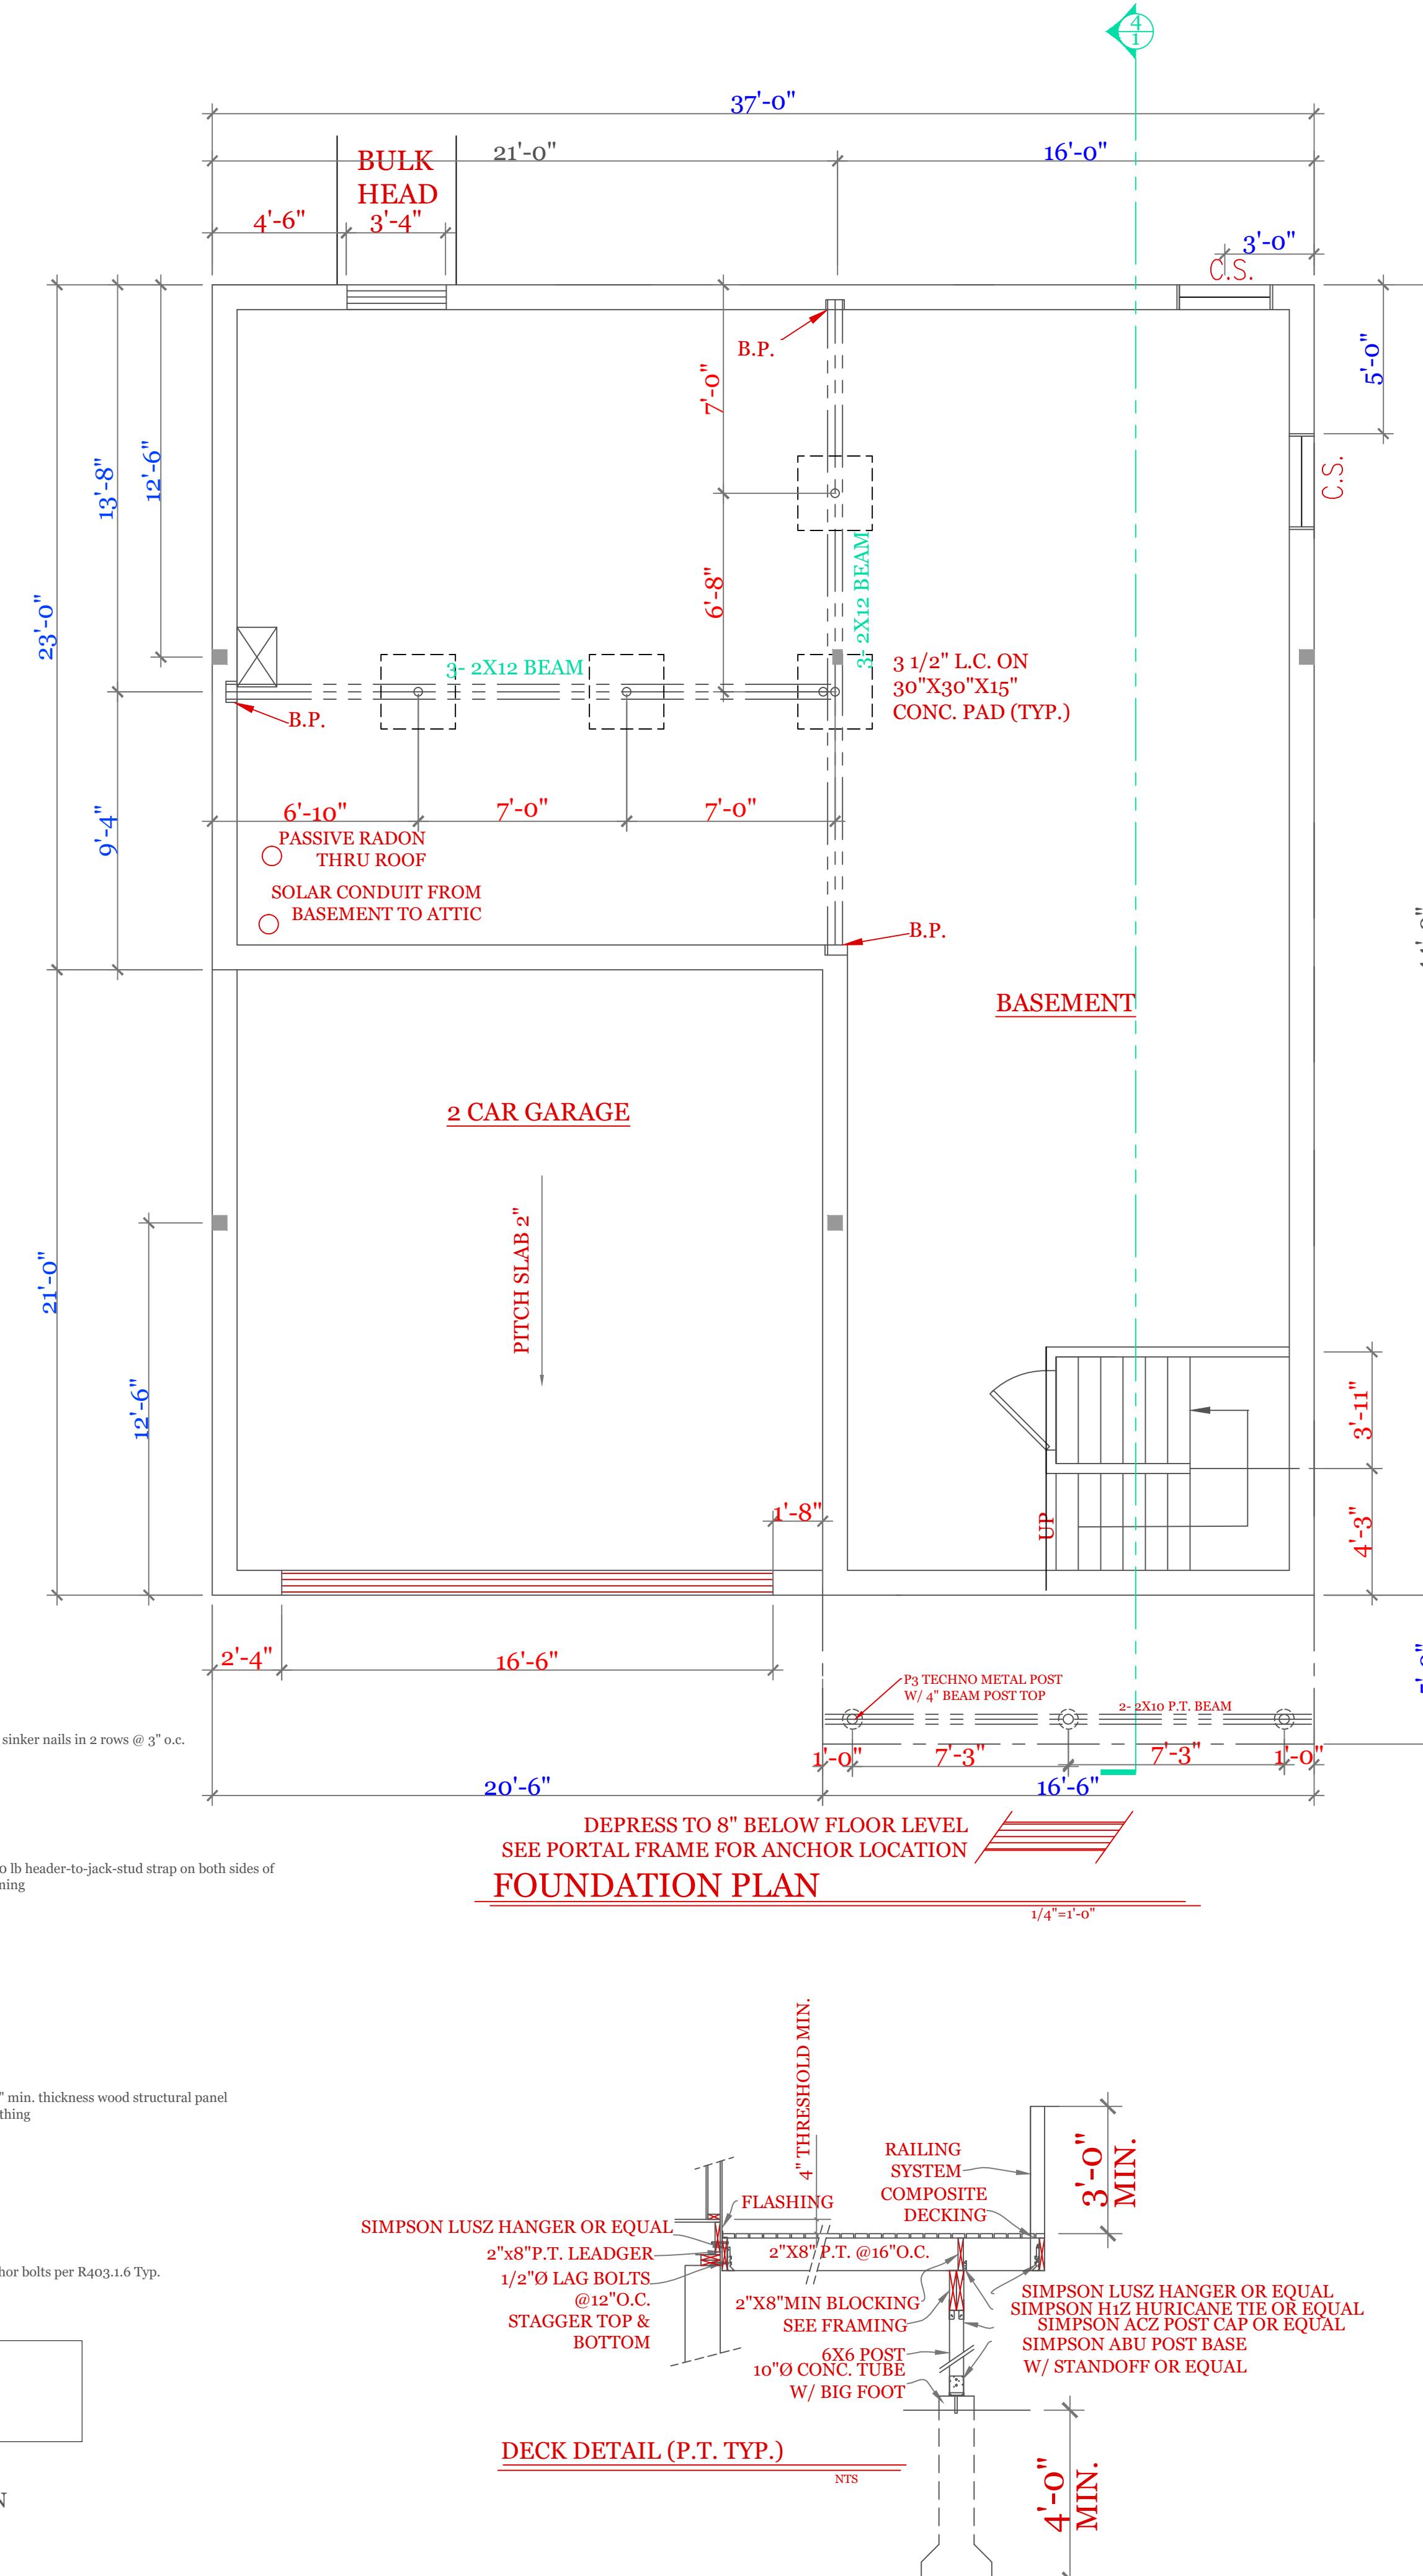

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UNIT 'C' 1734 S.F.
HIGGINS FARM AT
SALISBURY HILL
FOUNDATION PLAN
PORTAL FRAME
DETAILS

UNIT 'C' GL

DATE: 9/28/2022 R5/5/23
SCALE: 1/4" = 1'-0"
DRAWN BY: RCS
CHECKED BY: MJB



Sheet 2 OF 5

2

NOTES:

FOUNDATION NOTES:
1. HOUSE FOUNDATION- 10"X7'-10" POUR ON 20"X10" CONTINUOUS KEYED FOOTING. FOOTING TO BE PLACED ON UNDISTURBED SOIL OR 95% COMPACTED GRAVEL FREE OF ORGANIC SOIL AND MATERIAL.
2. GARAGE FOUNDATION- 8"X4'-0" MINIMUM POUR ON 16"X8" CONTINUOUS KEYED FOOTING. BOTTOM OF FOOTING TO BE 4'-0" MINIMUM BELOW GRADE. SOIL CONDITION SEE NOTE 1.
3. BASEMENT FLOOR-MINIMUM 4" CONCRETE (3,500 PSI)
4. GARAGE FLOOR- MINIMUM 4" CONCRETE (3,500 PSI) WITH WELDED WIRE FABRIC REINFORCEMENT. FLOOR TO PITCH 2" TWARD OVERHEAD GARAGE DOOR.
5. ANCHOR BOLTS 12" FROM CORNERS AND 6'-0" ON CENTER.
6. ONE #4 REBAR WITHIN 12" OF THE TOP OF THE WALL, STORY AND ONE #4 BAR NEAR MID-HEIGHT OF THE WALL, STORY (TABLE R404.1.6(1) 2015 INTERNATIONAL RESIDENTIAL BUILDING CODE)

NOTES:	
SYMBOL SCHEDULE;	
VENT	
SMOKE AND CARBON DETECTOR	
SMOKE DETECTOR	
HEAT DETECTOR	
BEARING POINT W/ SQUASH BLOCK	

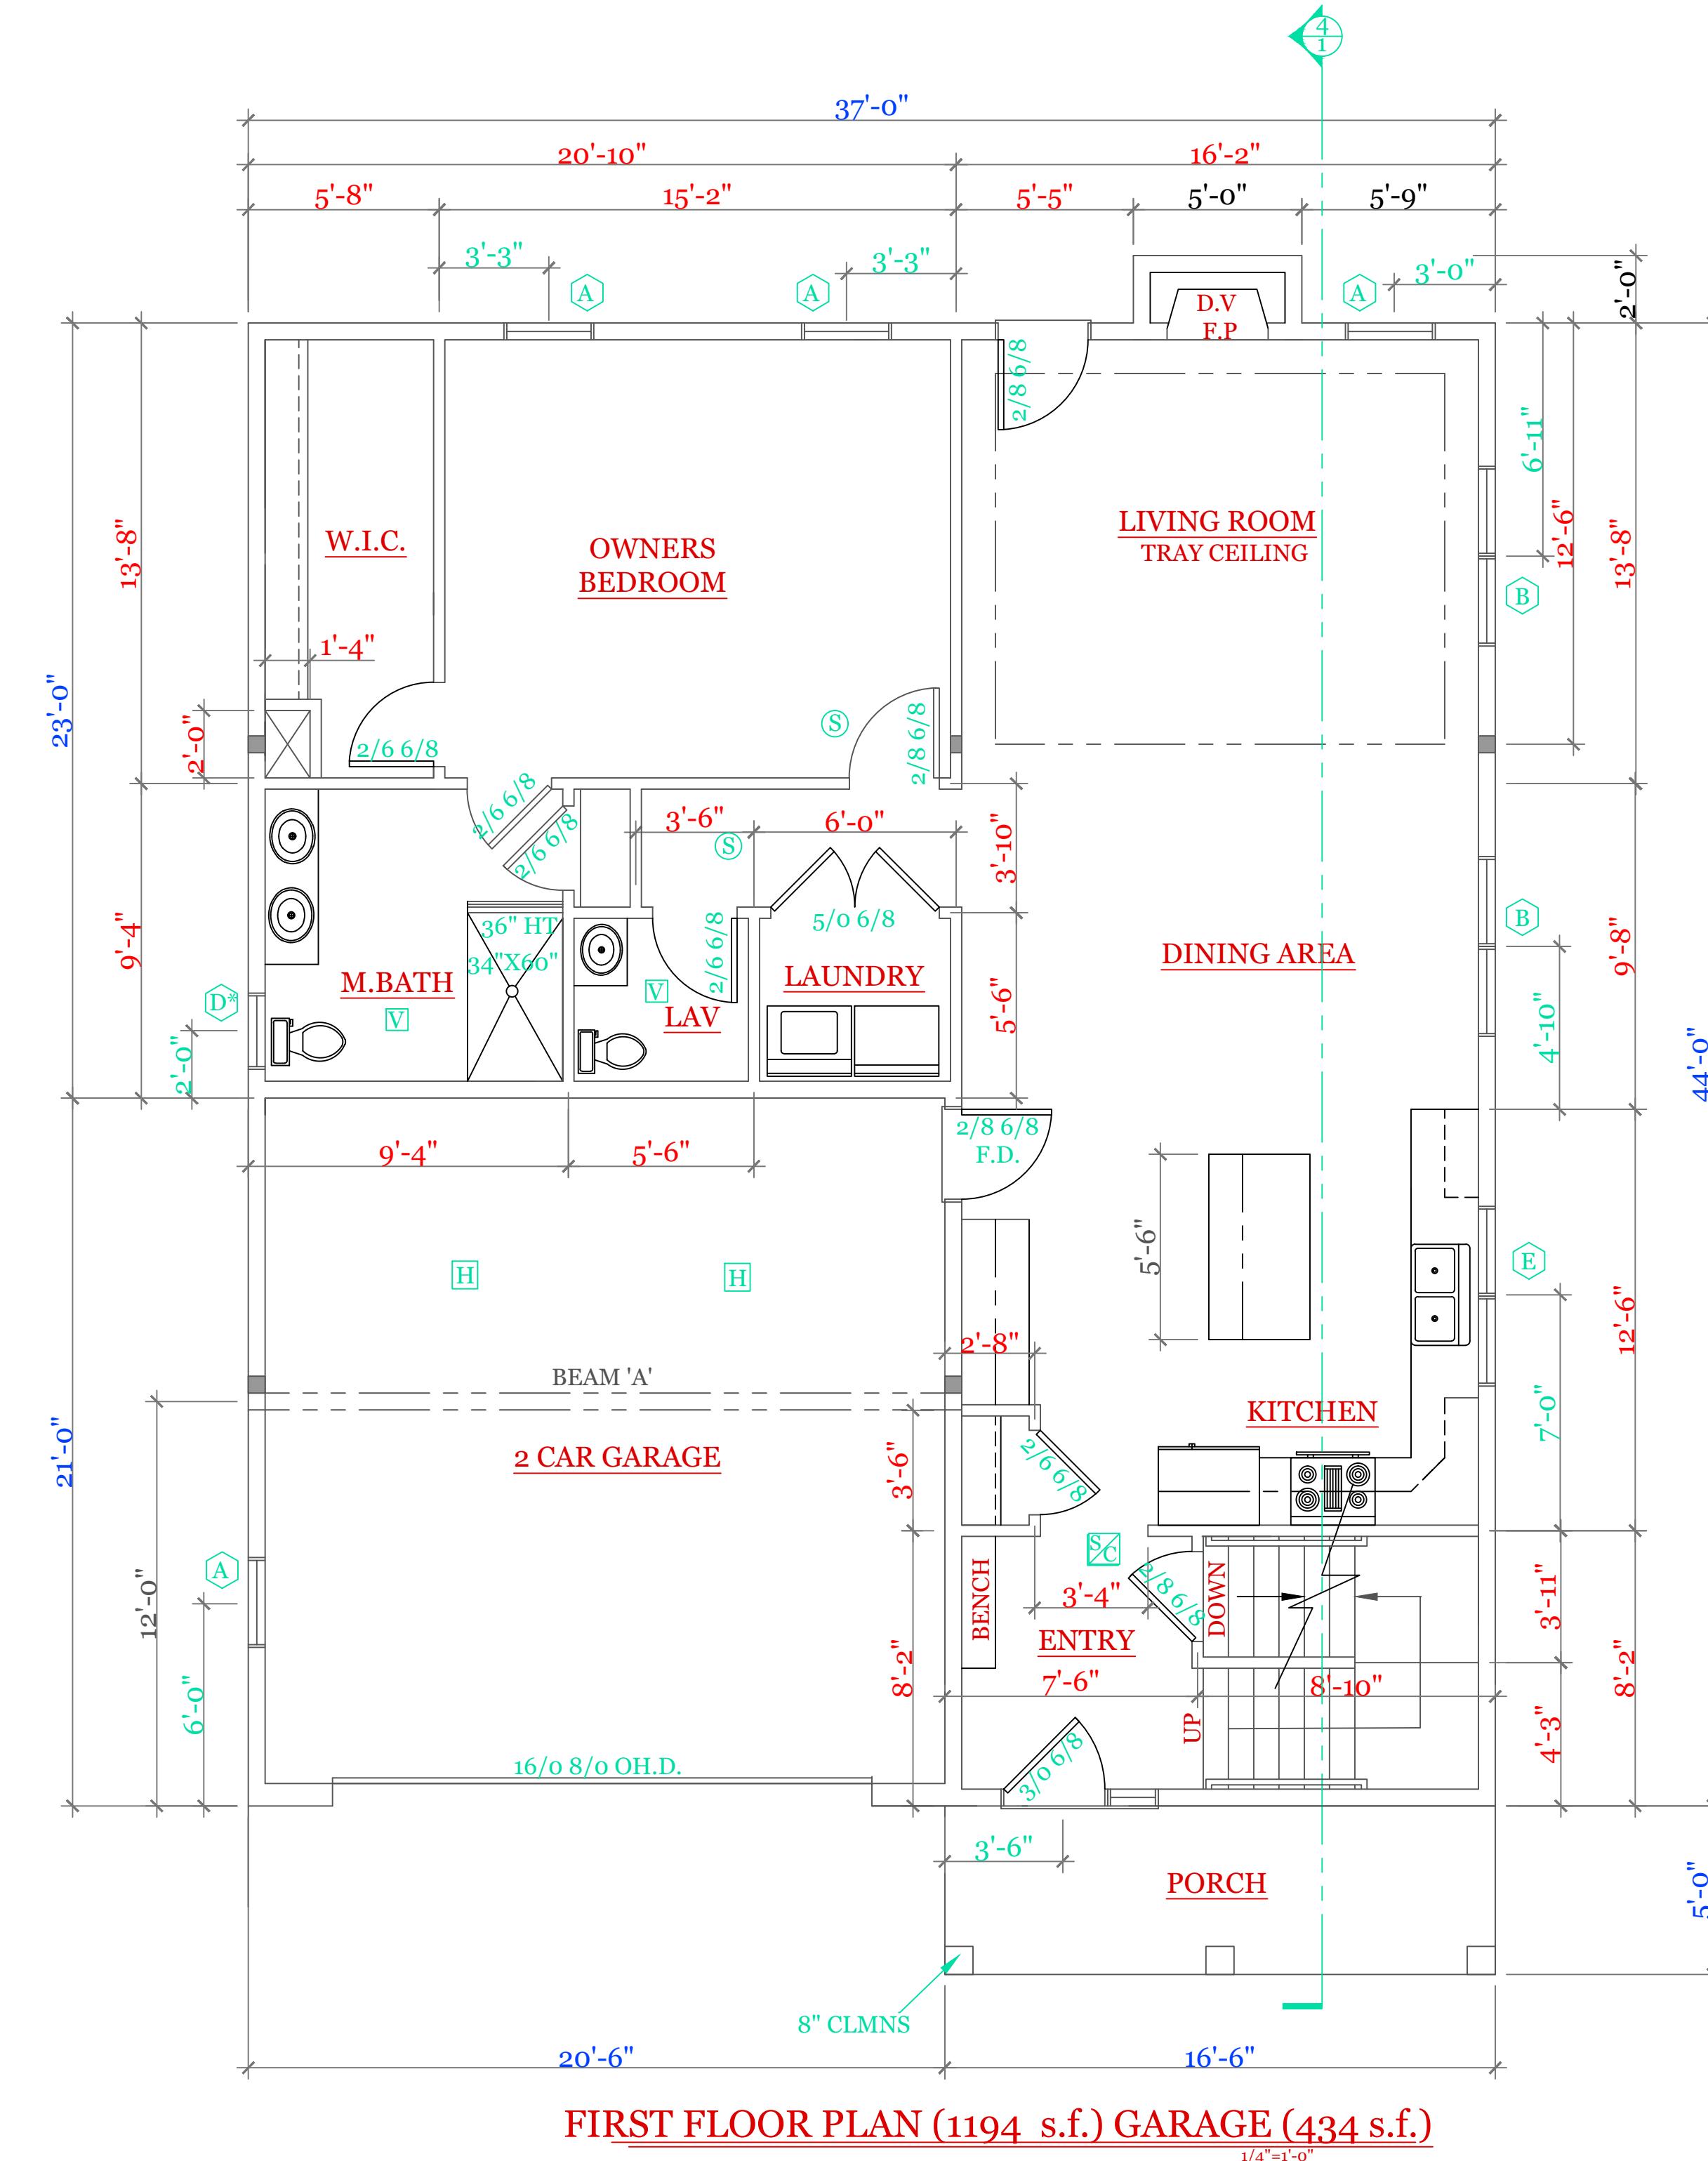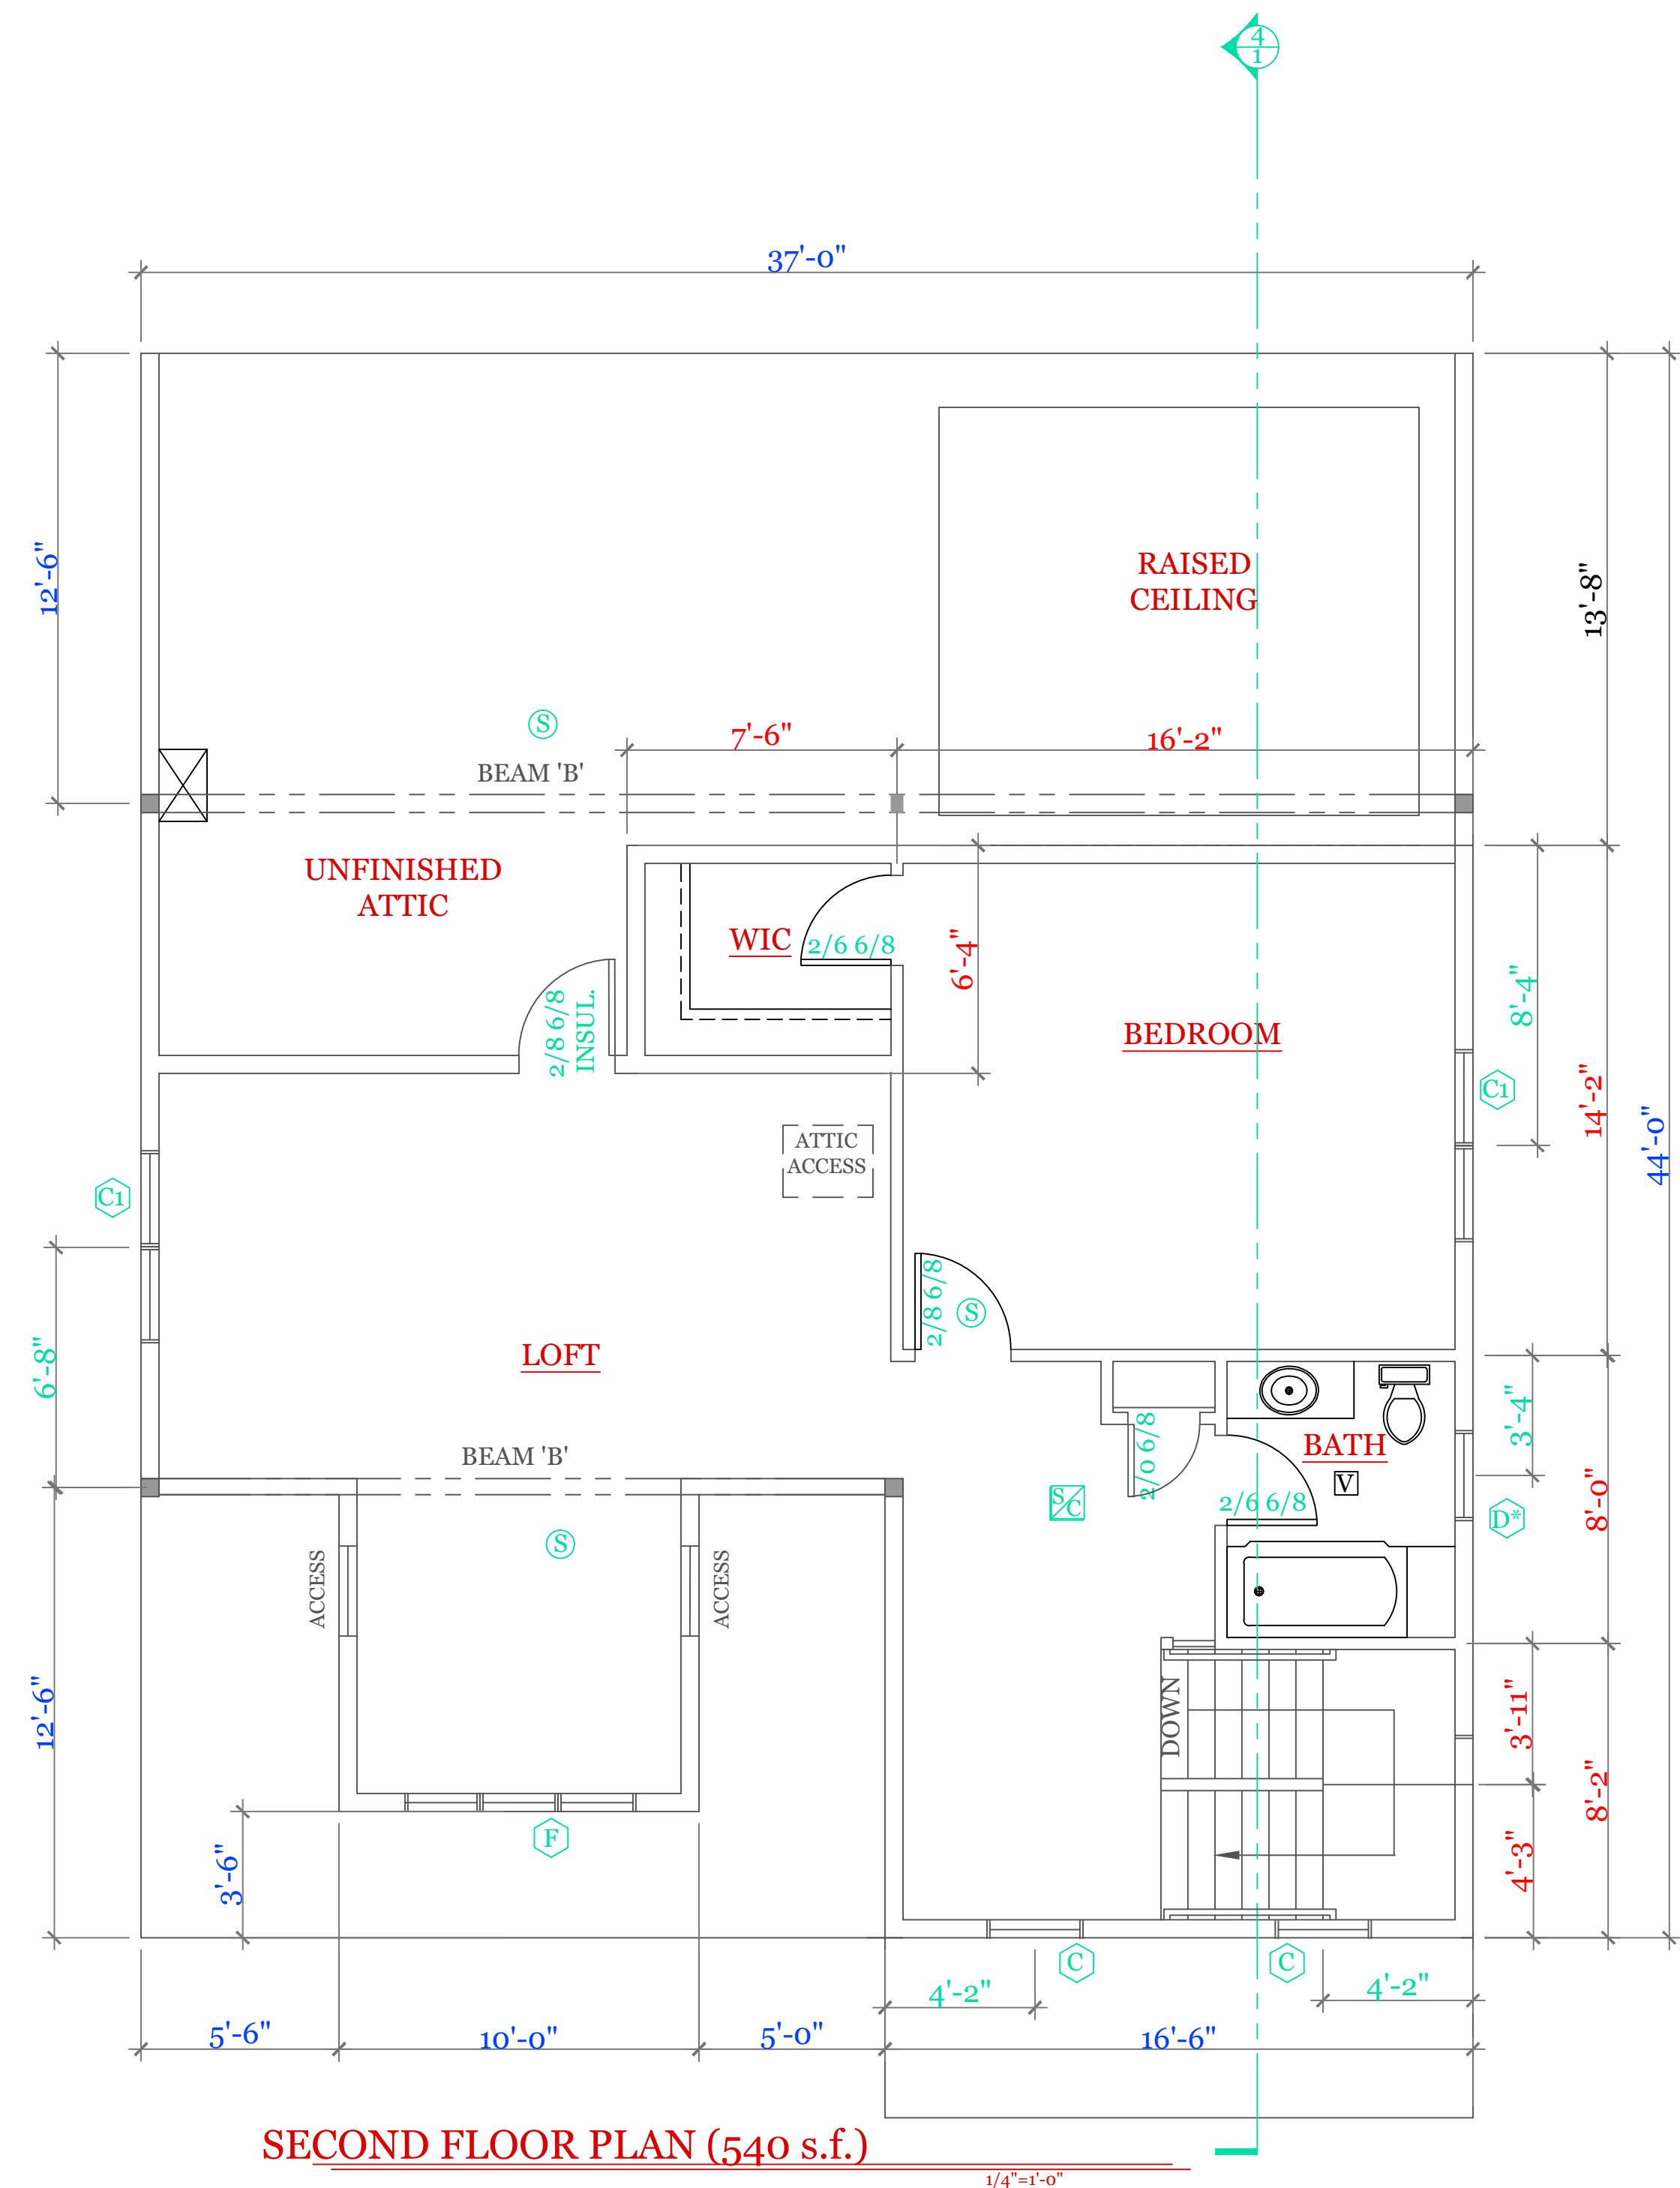

WINDOW SCHEDULE: HARVEY LANSING			
INDEX	QUA	CATALOG	ROUGH OPENING
A	4	10000-1	2'-8 1/8" X 5'-6"
B	2	11000-1	5'-4 1/2" X 5'-6"
C	2	12000-1	2'-8 1/8" X 4'-9"
C1	2	13000-1	5'-4 1/2" X 4'-9"
D*	2	14000-1 TEMPERED	2'-4 3/8" X 2'-8"
E	1	15000-1	4'-0 1/2" X 3'-5 3/8"
F	1	16000-3	7'-9" X 3'-1"
FRONT	1	17000-1	4'-3 3/8" X 6'-10 1/2"
REAR	1	18000-1	3'-2 3/8" X 6'-10 1/2"

NOTES: CONSULT TABLE 603.7(1) JACKS & HEADERS

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UNIT 'C' 1734 S.F.
HIGGINS FARM AT
SALISBURY HILL

FIRST & SECOND
FLOOR PLANS
WINDOW SCHEDULE

UNIT 'C' GL

DATE: 9/28/2022 R5/5/23
SCALE: 1/4"=1'-0"


DRAWN BY: RCS

CHECKED BY: MJB

Sheet 3 OF 5

3

TYPICAL BUILDING SECTION

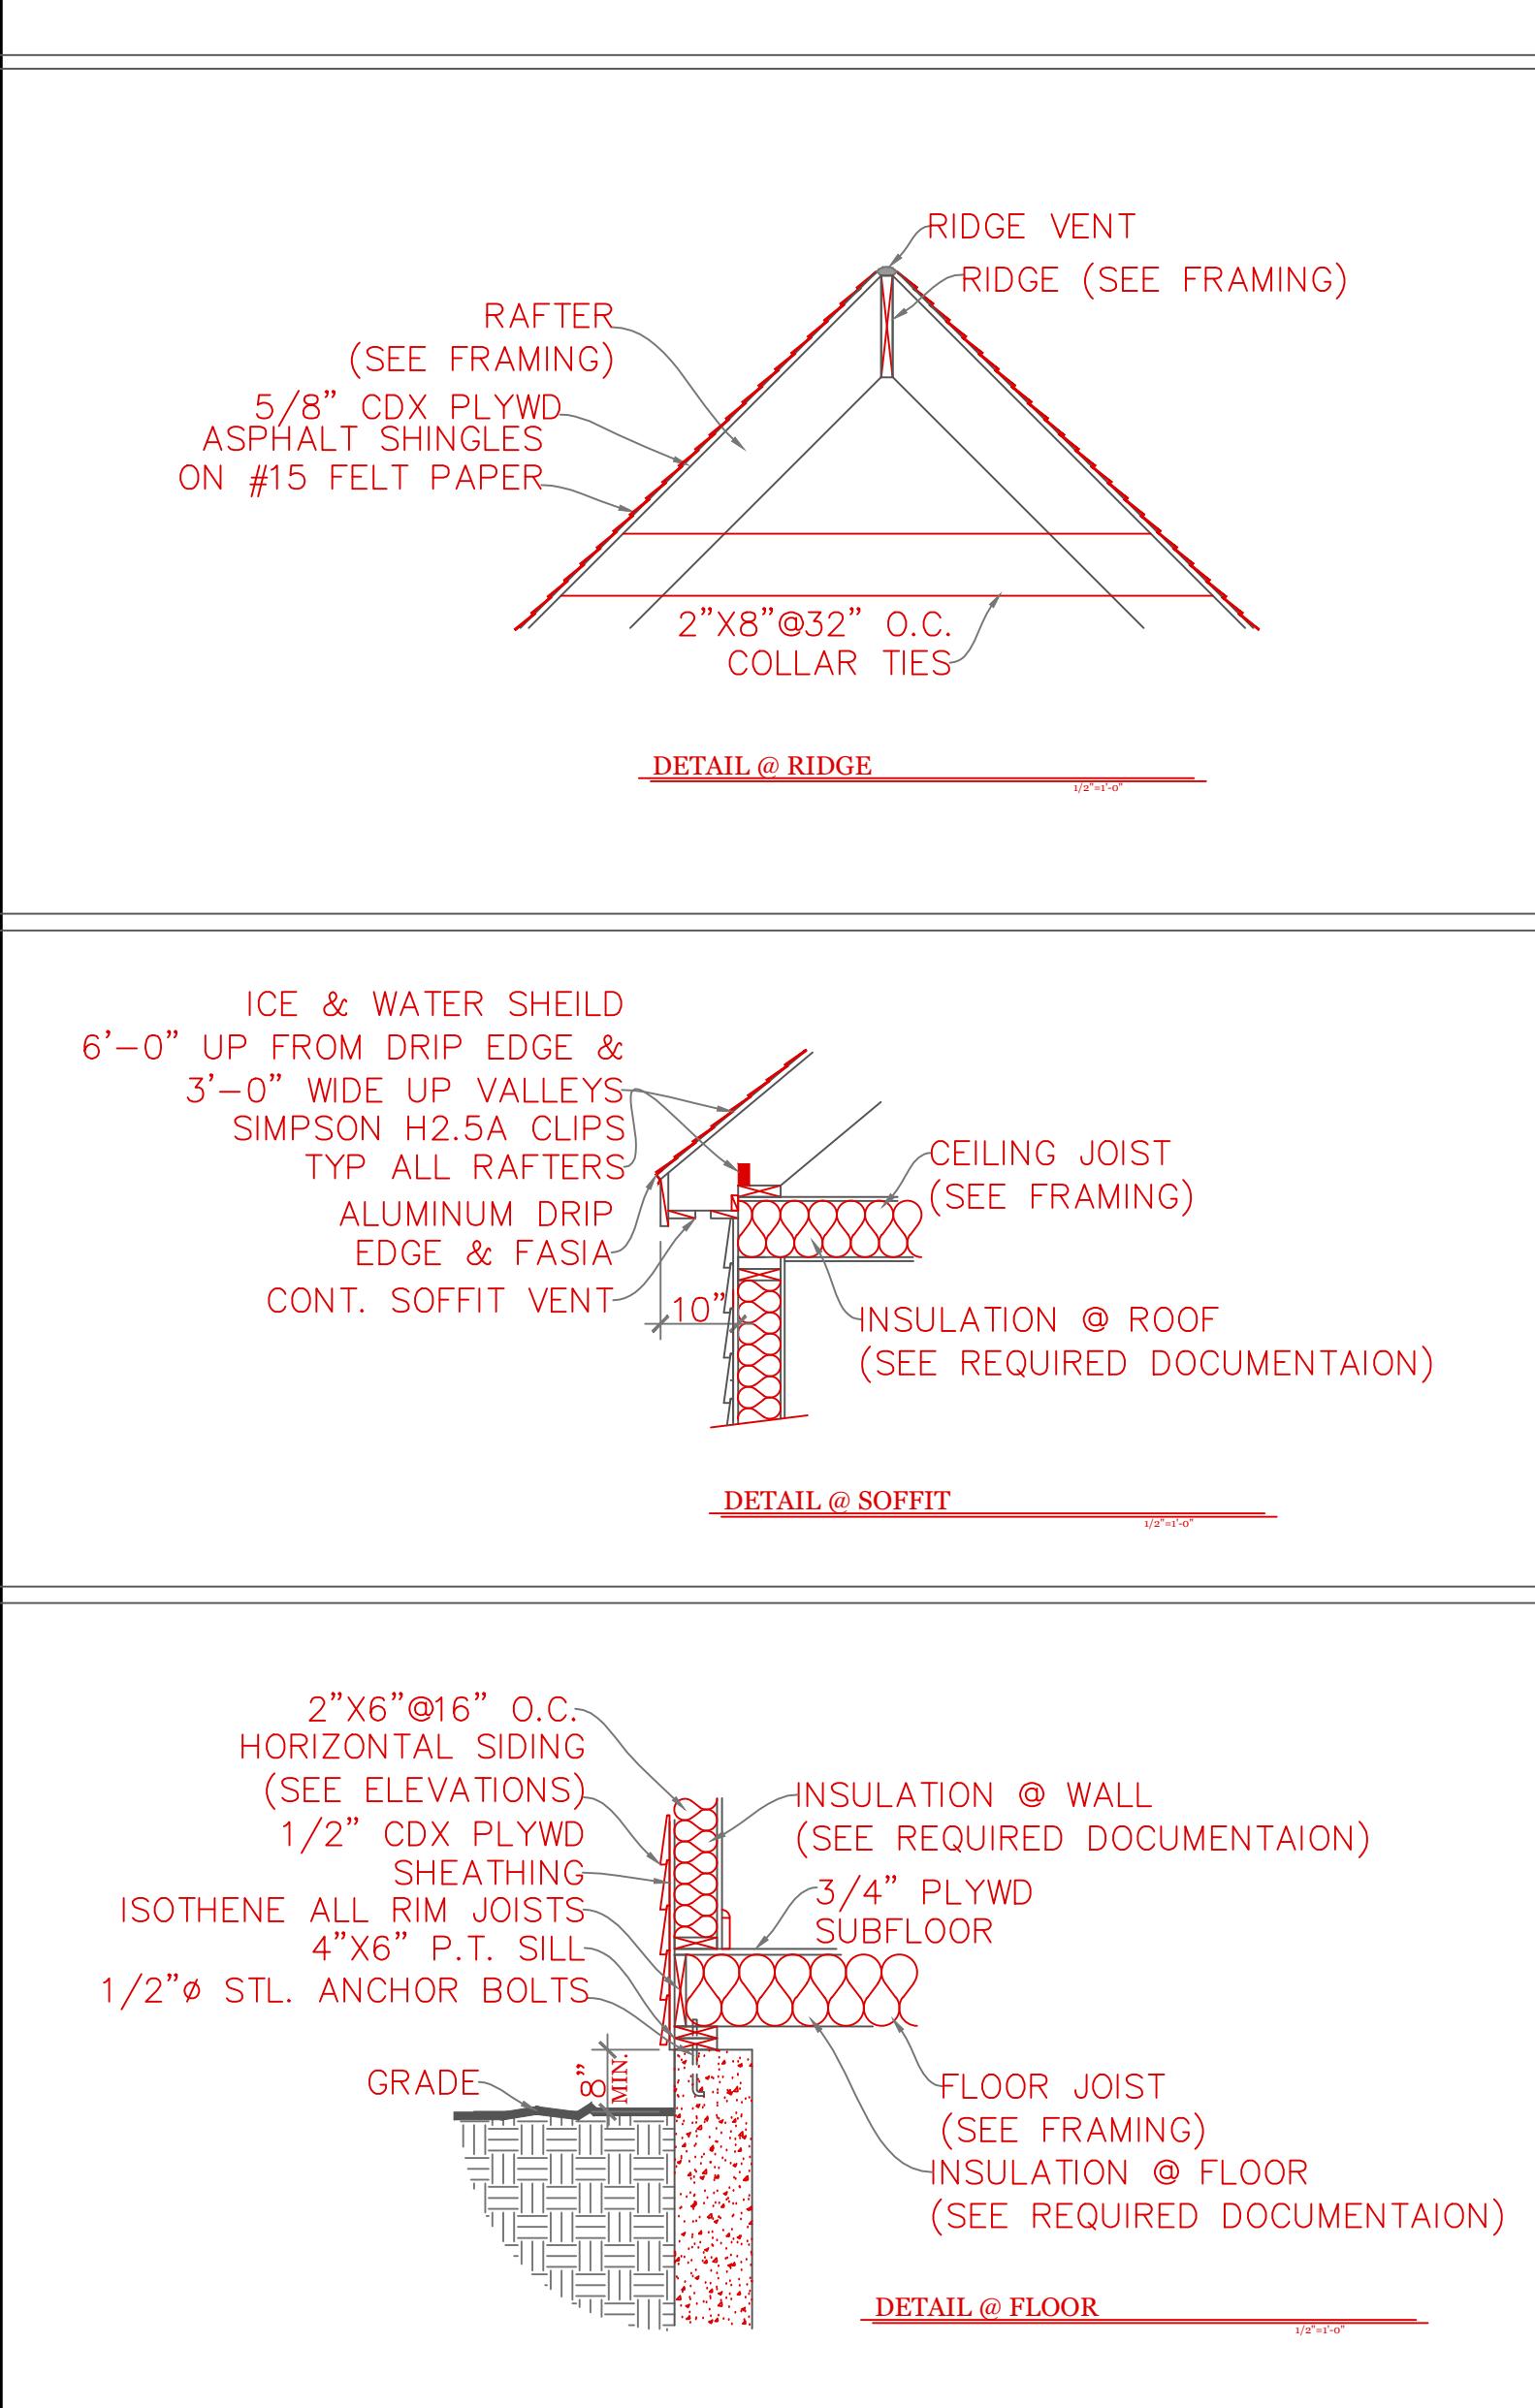

CONSTRUCTION SCHEDULE:		(UNLESS NOTED OTHERWISE ON PLAN)
1	RIDGE BOARD:	SEE FRAMING W/ RIDGE VENT
2	ROOF MATERIAL:	ASPHALT SHINGLES ON 15# ROOF FELT
3	ROOF SHEATHING	1/2" O.S.B. w/ 15# ROOF FELT
4	ROOF RAFTER:	SEE FRAMING
5	COLLAR TIES:	1X8 @ 32" O.C.
6	DRIP EDGE	ALUMINUM DRIP EDGE
7	SOFFIT:	CONT. SOFFIT VENT
8	CEILING JOIST	SEE FRAMING
9	ATTIC INSULATION	R-38
10	EXT WALL:	2"X6" @ 16" O.C.
11	EXT. SHEATHING	1/2" O.S.B. w/ HOUSE WRAP
12	EXT. FINISH	SEE ELEVATIONS
13	INSULATION@WALL	R-21
14	INTERIOR WALL	2"X4"@16"O.C.
15	SUB FLOOR:	3/4" ADVANTEK GLUED & NAILED
16	JOIST:	SEE FRAMING.
17	SILL:	2"X6" P.T. SILL W/ 2X6 KD TOP PLATE
18	INSULATION @ FLOOR	R-30
19	ANCHOR:	1/2"Ø STL ANCHOR BOLTS
20	BEAM:	SEE FRAMING PLAN
21	COLUMN:	3 1/2" L.C.
22	FND. WALL:	10"X7'-10" CONC. WALL
23	SLAB:	SEE FOUNDATION NOTES
24	FOOTING:	20"X10" CONT. KEYED FTNG
25	CONC. PAD:	30"X30"X15" CONC. PAD

NOTES: -ISOTHEENE ALL RIM JOISTS (OPTIONAL)
-ICE & WATER SHEILD 6'-0" UP FROM DRIP EDGE
& 3'-0" WIDE UP VALLEYS
-SIMPSON H2.5A CLIPS TYP ALL RAFTERS

TABLE 402.1.2
INSULATION AND FENESTRATION REQUIREMENTS BY COMPONENT

CLIMATE ZONE	FENESTRATION U-FACTOR ^b	SKYLIGHT ^b U-FACTOR	GLAZED FENESTRATION SHGC _{b,e}	CEILING R-VALUE	WOOD FRAME WALL R-VALUE	MASS WALL R-VALUE ⁱ	FLOOR R-VALUE	BASEMENT WALL R-VALUE ^c	SLAB ^d R-VALUE & DEPTH	CRAW SPACE WALL R-VALUE
5 and Marine 4	0.30	0.55	NR	49	20 or 13+5 ^h	13/17	30g	15/19	10, 2 ft	15/19


2018 INTERNATIONAL ENERGY CONSERVATION CODE® AND MASSACHUSETTES 780 CMR 9TH EDITION

For SI: 1 foot = 304.8 mm.


- a. R-values are minimums. U-factors and SHGC are maximums. R-19 batts compressed into a nominal 2 x 6 framing cavity such that the R-value is reduced by R-1 or more shall be marked with the compressed batt R-value in addition to the full thickness R-value.
- b. The fenestration U-factor column excludes skylights. The SHGC column applies to all glazed fenestration.
- c. "15/19" means R-15 continuous insulated sheathing on the interior or exterior of the home or R-19 cavity insulation at the interior of the basement wall. "15/19" shall be permitted to be met with R-13 cavity insulation on the interior of the basement wall plus R-5 continuous insulated sheathing on the interior or exterior of the home. "10/13" means R-10 continuous insulated sheathing on the interior or exterior of the home or R-13 cavity insulation at the interior of the basement wall.
- d. R-5 shall be added to the required slab edge R-values for heated slabs. Insulation depth shall be the depth of the footing or 2 feet, whichever is less in Zones 1 through 3 for heated slabs.
- e. There are no SHGC requirements in the Marine Zone.
- f. Basement wall insulation is not required in warm-humid locations as defined by Figure 301.1 and Table 301.1.
- g. Or insulation sufficient to fill the framing cavity, R-19 minimum.
- h. "13+5" means R-13 cavity insulation plus R-5 insulated sheathing. If structural sheathing covers 25 percent or less of the exterior, insulating sheathing is not required where structural sheathing is used. If structural sheathing covers more than 25 percent of exterior, structural sheathing shall be supplemented with insulated sheathing of at least R-2.
- i. The second R-value applies when more than half the insulation is on the interior of the mass wall.
- j. For impact rated fenestration complying with Section R301.21.2 of the *International Residential Code* or Section 1608.1.2 of the *International Building Code*, the maximum U-factor shall be 0.75 in Zone 2 and 0.65 in Zone 3.

DESIGN CRITERIA

GROUND SNOW LOAD	WIND SPEED (MPH)	SEISMIC DESIGN	WEATHERING	FROST LINE DEPTH	TERMITE	DECAY	WINTER DESIGN TEMP	ICE SHIELD UNDERLAYMENT REQUIRED	FLOOD HAZARD	AIR FREEZING INDEX	MEAN ANNUAL TEMP
TABLE 5301.2(5)	TABLE 5301.2.(4)	N/A	FIGURE 5301.2(3)	4 ft. minimum unless engineered data shows otherwise	FIGURE 5301.2(6)	FIGURE 5301.2(7)	APPENDIX 780 CMR 120.J TABLE 120.J.3.2.1	As required by the exterior roof covering manufacturer; roof pitch and local climate must also be considered	Refer to applicable Flood Insurance Rate Map (FIRM)	Only utilized in the design and construction of frost protected shallow foundations	Only utilized in the design and construction of frost protected shallow foundations
50 psf	124 mph	N/A	SEVERE	§5403.1.4	MODERATE TO HEAVY	SLIGHT TO MODERATE	N/A	§5905.0	FIRM MAPS	SEE NOTE J TABLE 5301.2(1)	SEE NOTE K TABLE 5301.2(1)

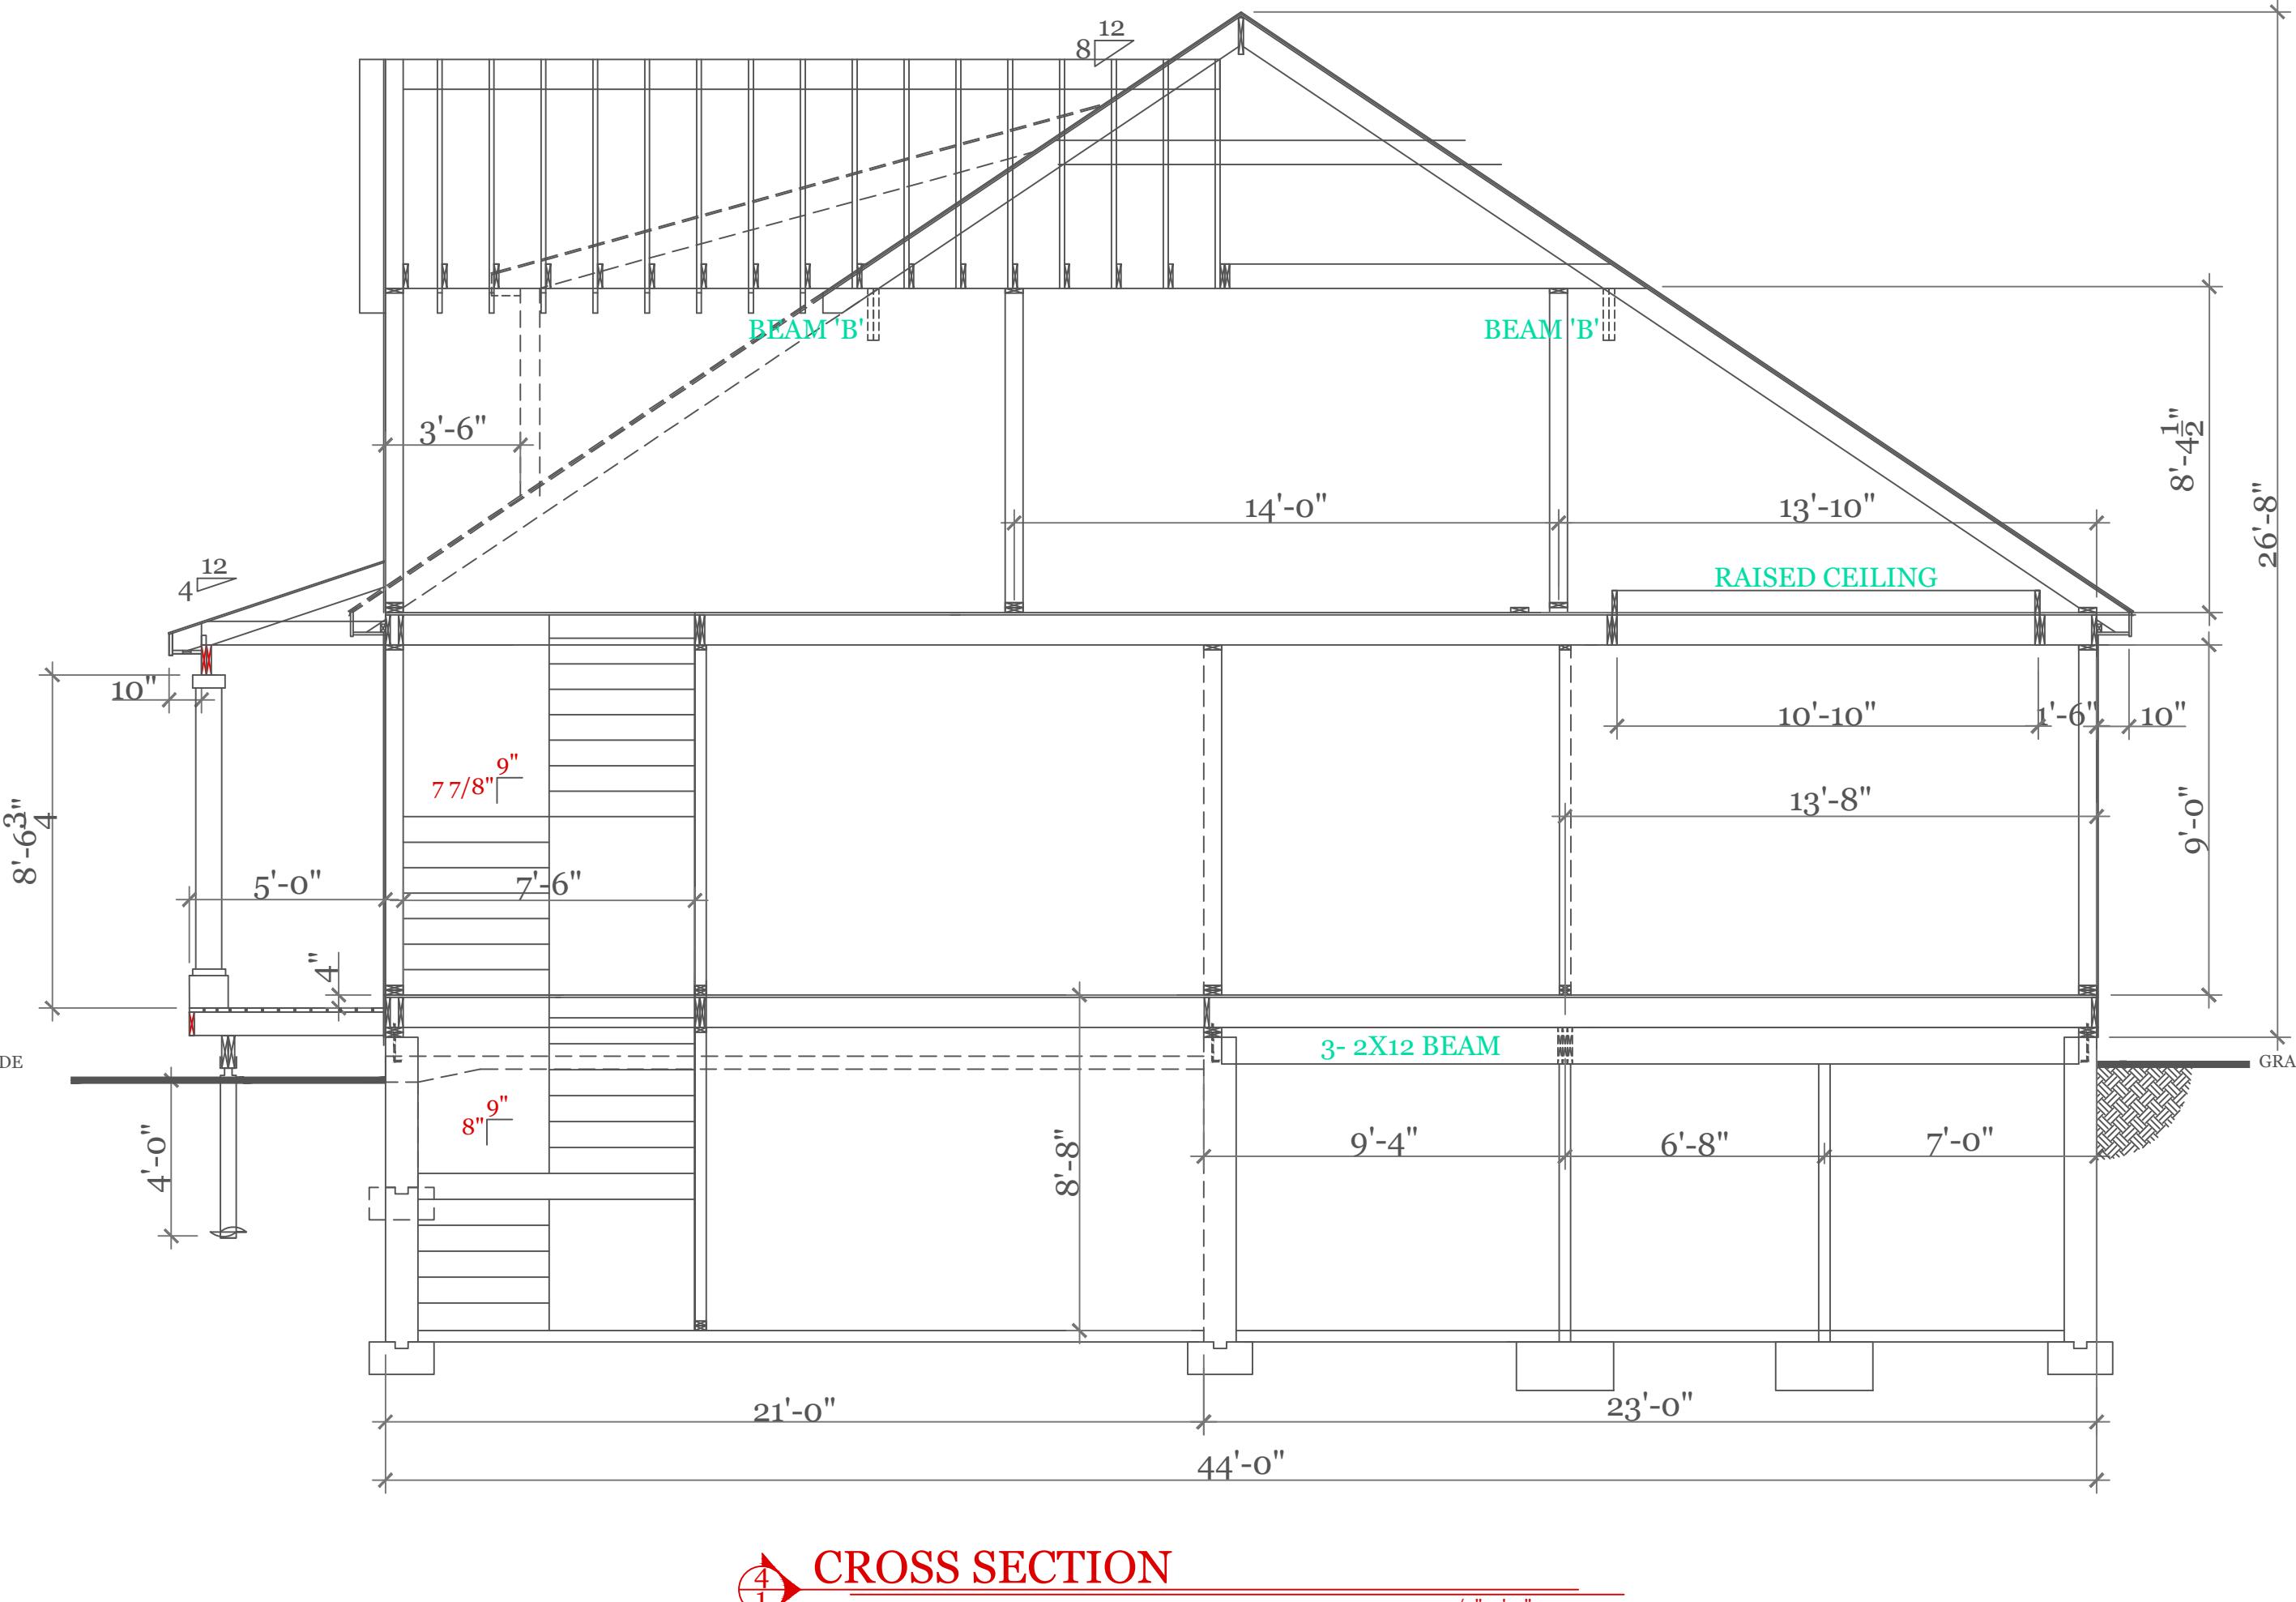

CROSS SECTION

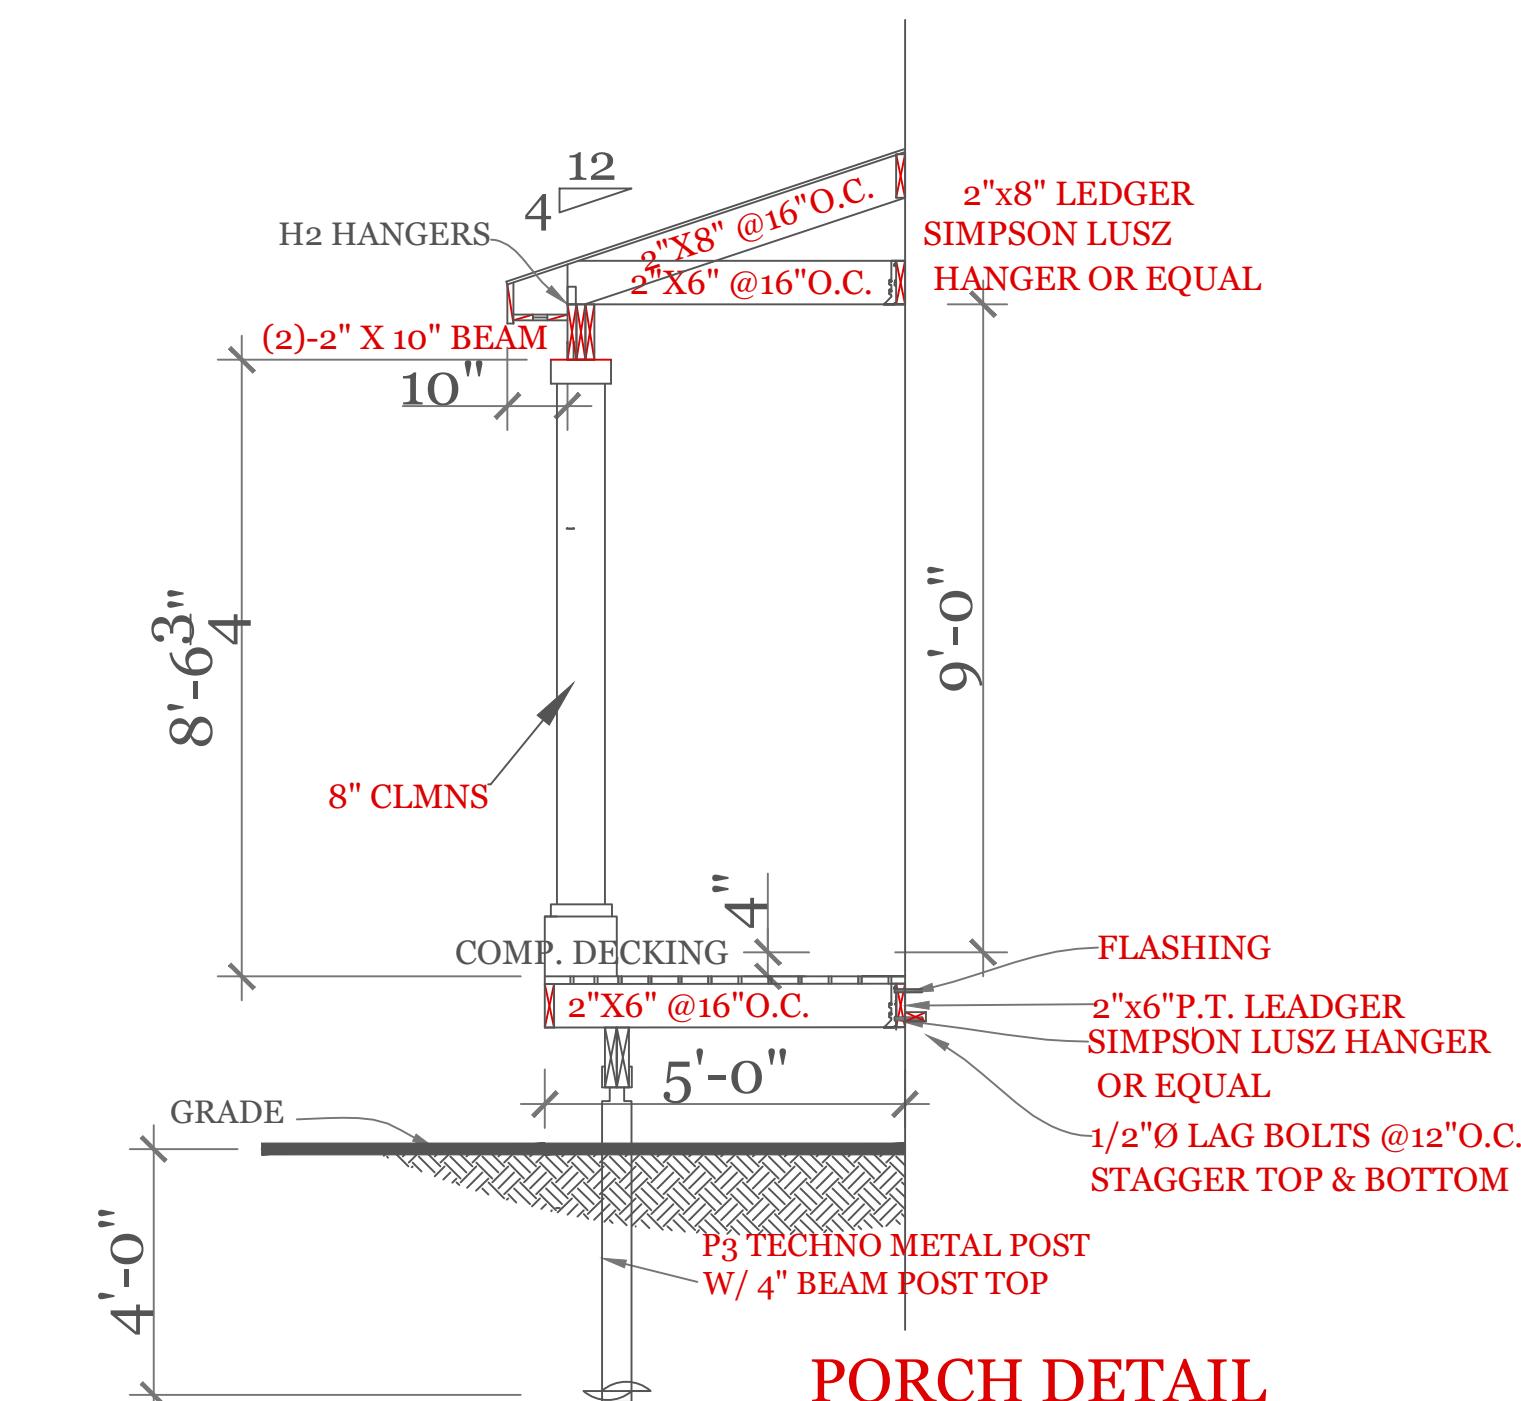

PORCH DETAIL

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Design / Build
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UNIT 'C' 1734 S.F.
HIGGINS FAM AT
SALISBURY HILL

BUILDING SECTION CODE CRITERIA CONSTR. SCHEDULE

UNIT 'C' GL

CALE: AS NOTED

DRAWN BY: RC

CHECKED BY: MJ

4 OF 5

10 of 10

4

4

NOTES:

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UNIT 'C' 1734 S.F. HIGGINS FARM AT SALISBURY GREEN	FRAMING PLANS BEAM CALCS
UNIT 'C' GL	
DATE: 9/28/2022 R5/5/23	
SCALE: 3/16" = 1'-0"	
DRAWN BY: RCS	
CHECKED BY: MJB	
Sheet 5 OF 5	





5

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SECOND FLOOR FRAMING (2"X10"@16"O.C. UNLESS NOTED)
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ROOF FRAMING (2"X8"@16"O.C. UNLESS NOTED)
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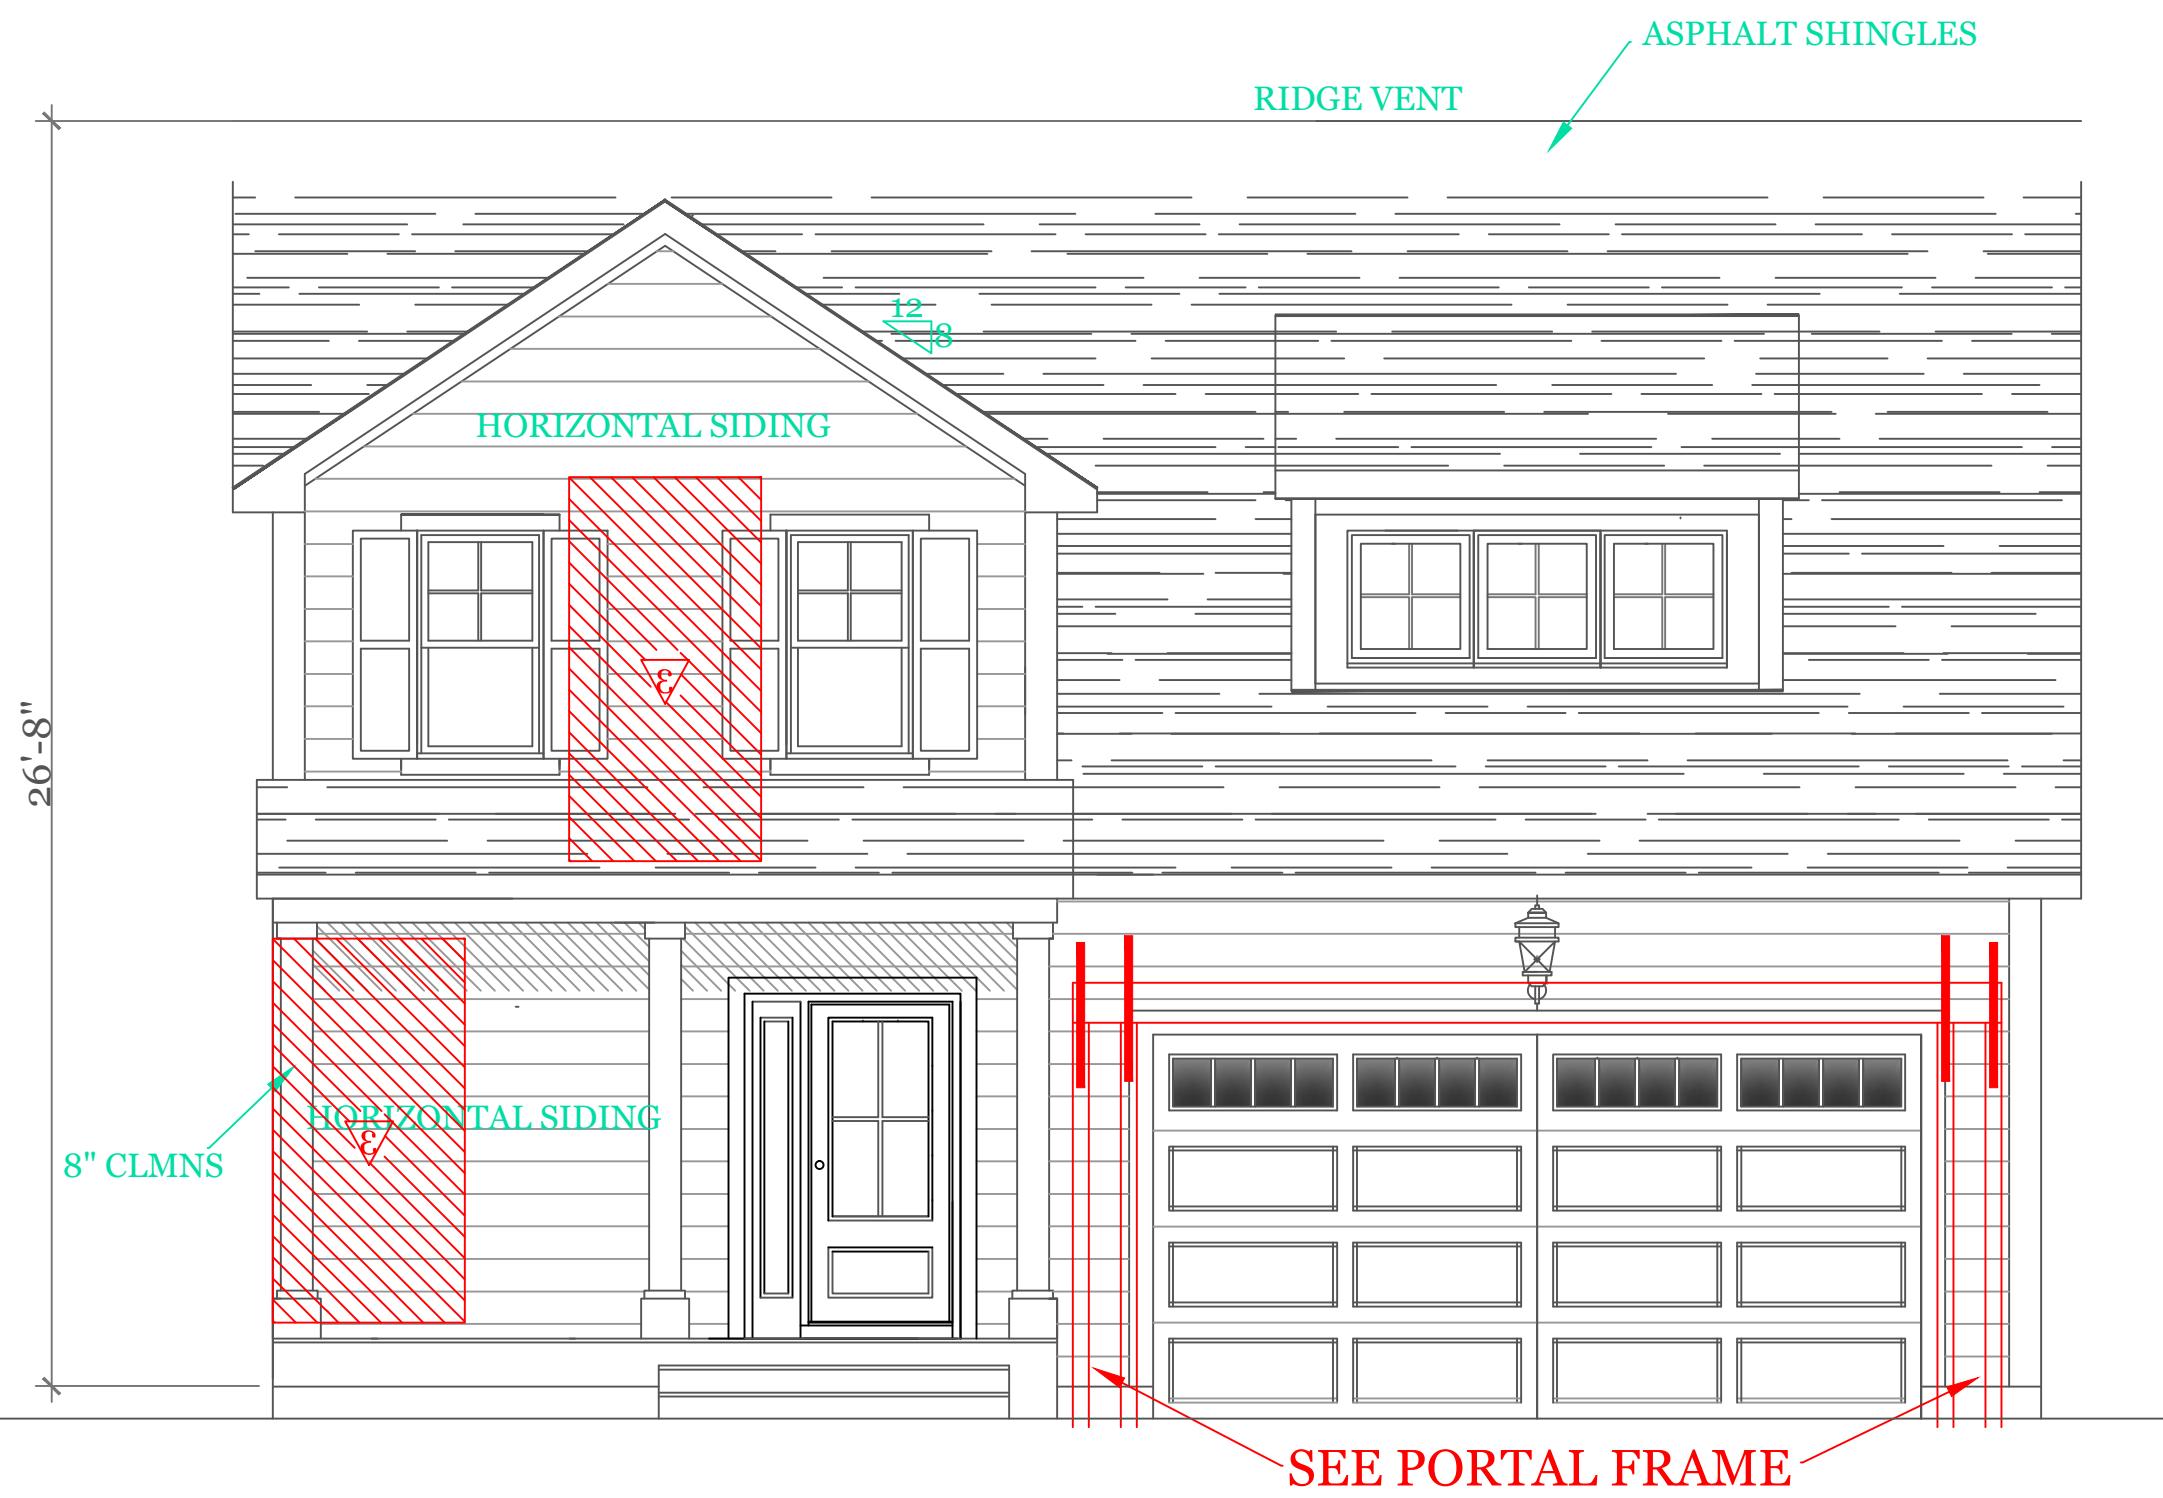
CEILING FRAMING (2"X8"@16"O.C. UNLESS NOTED)
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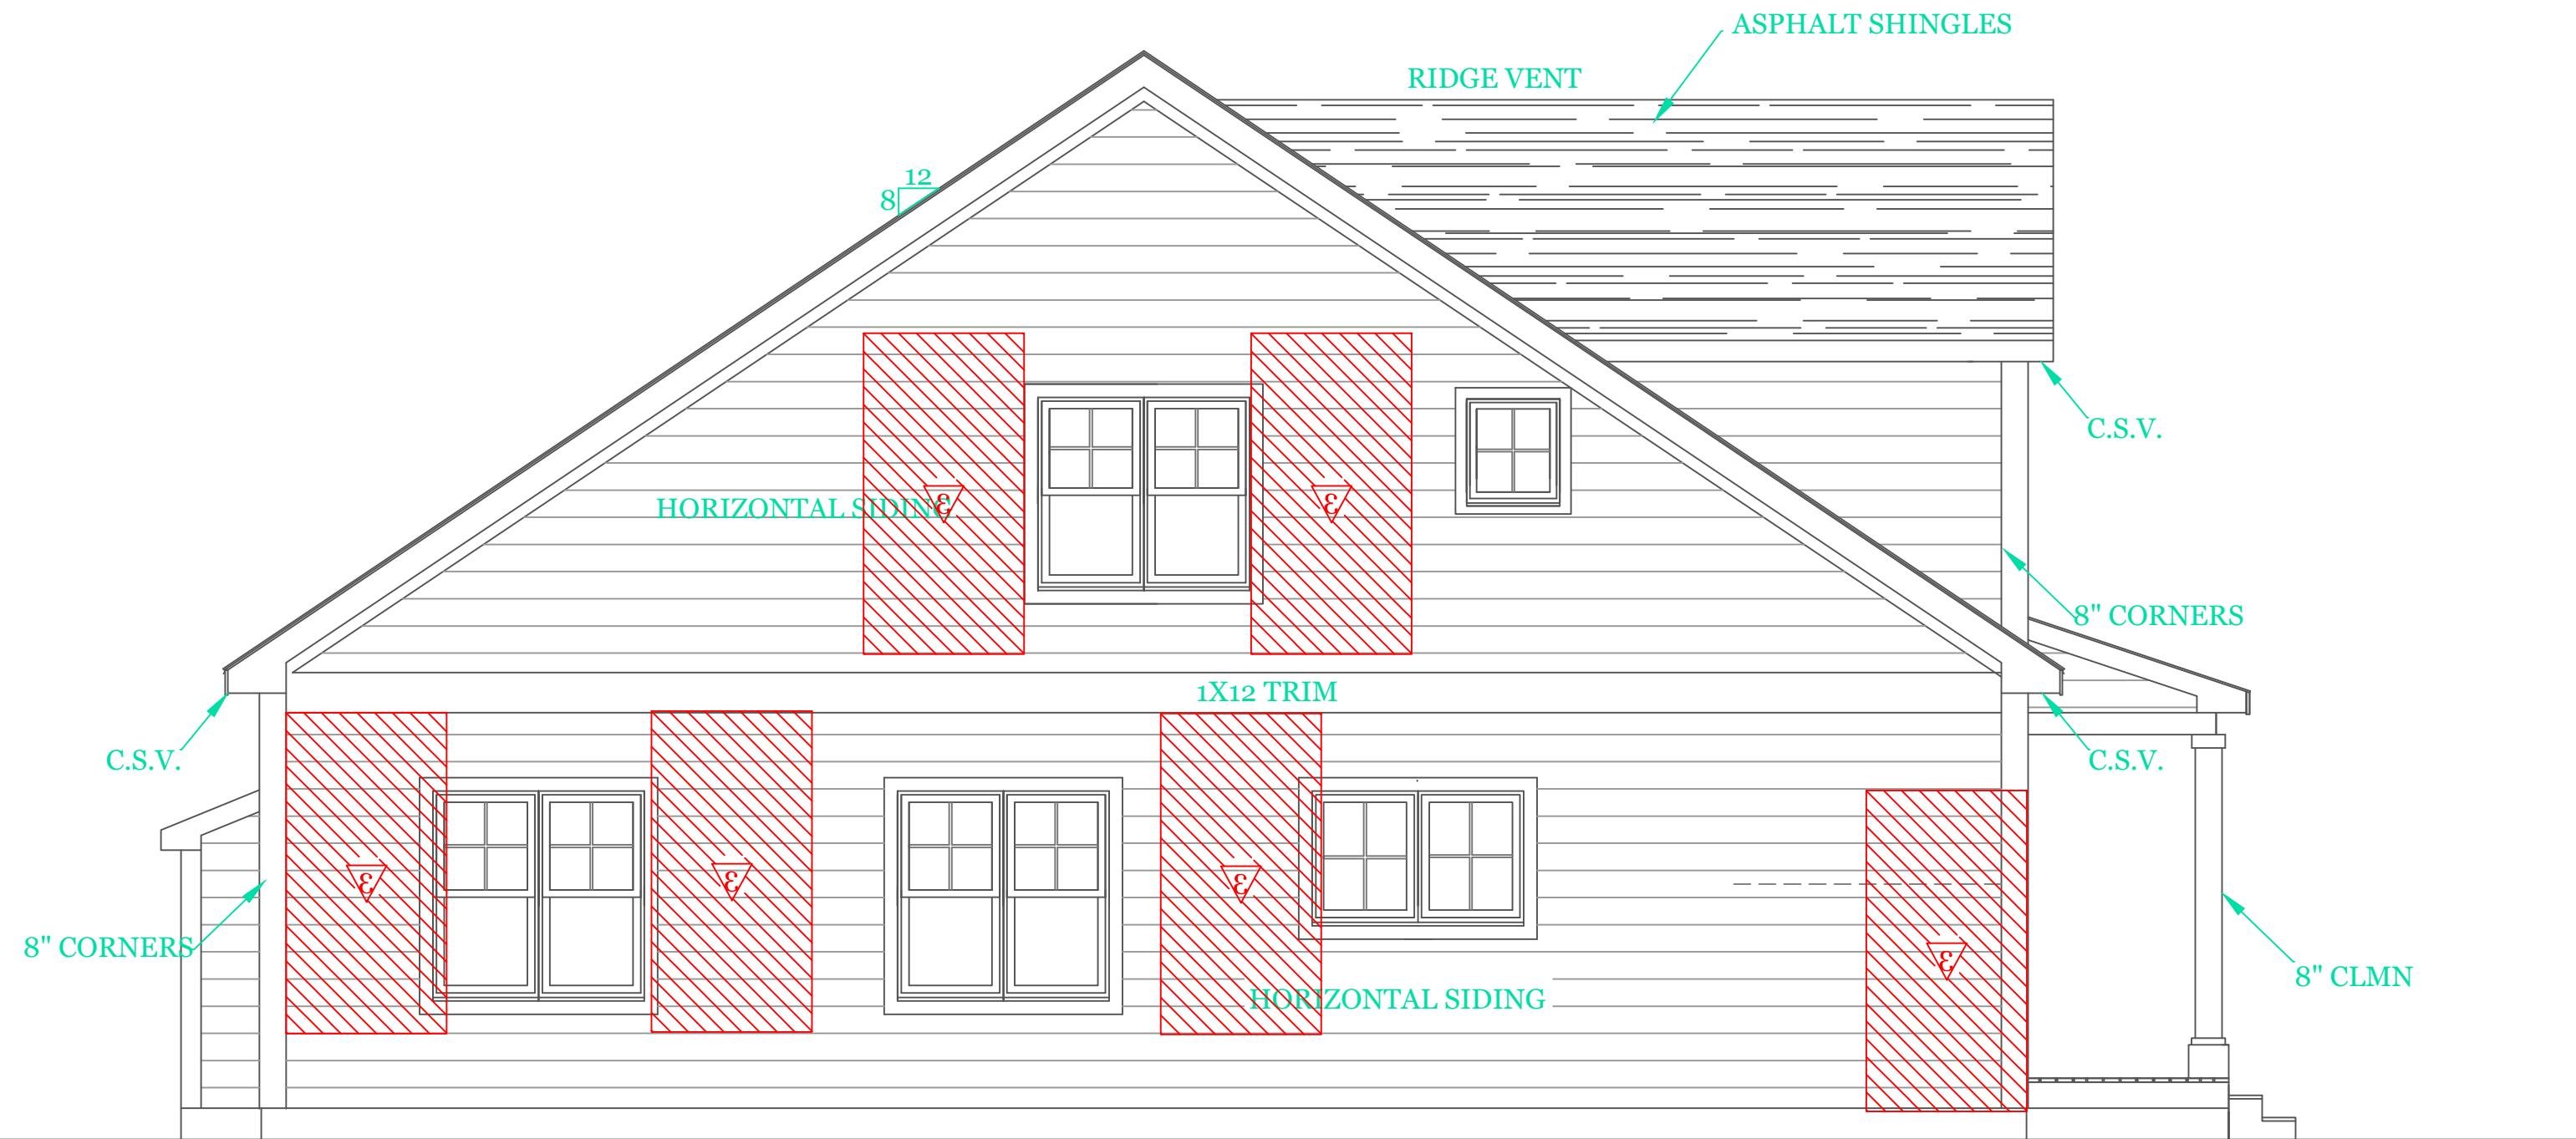
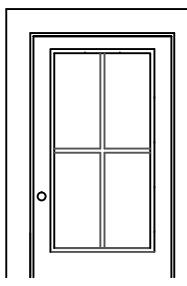
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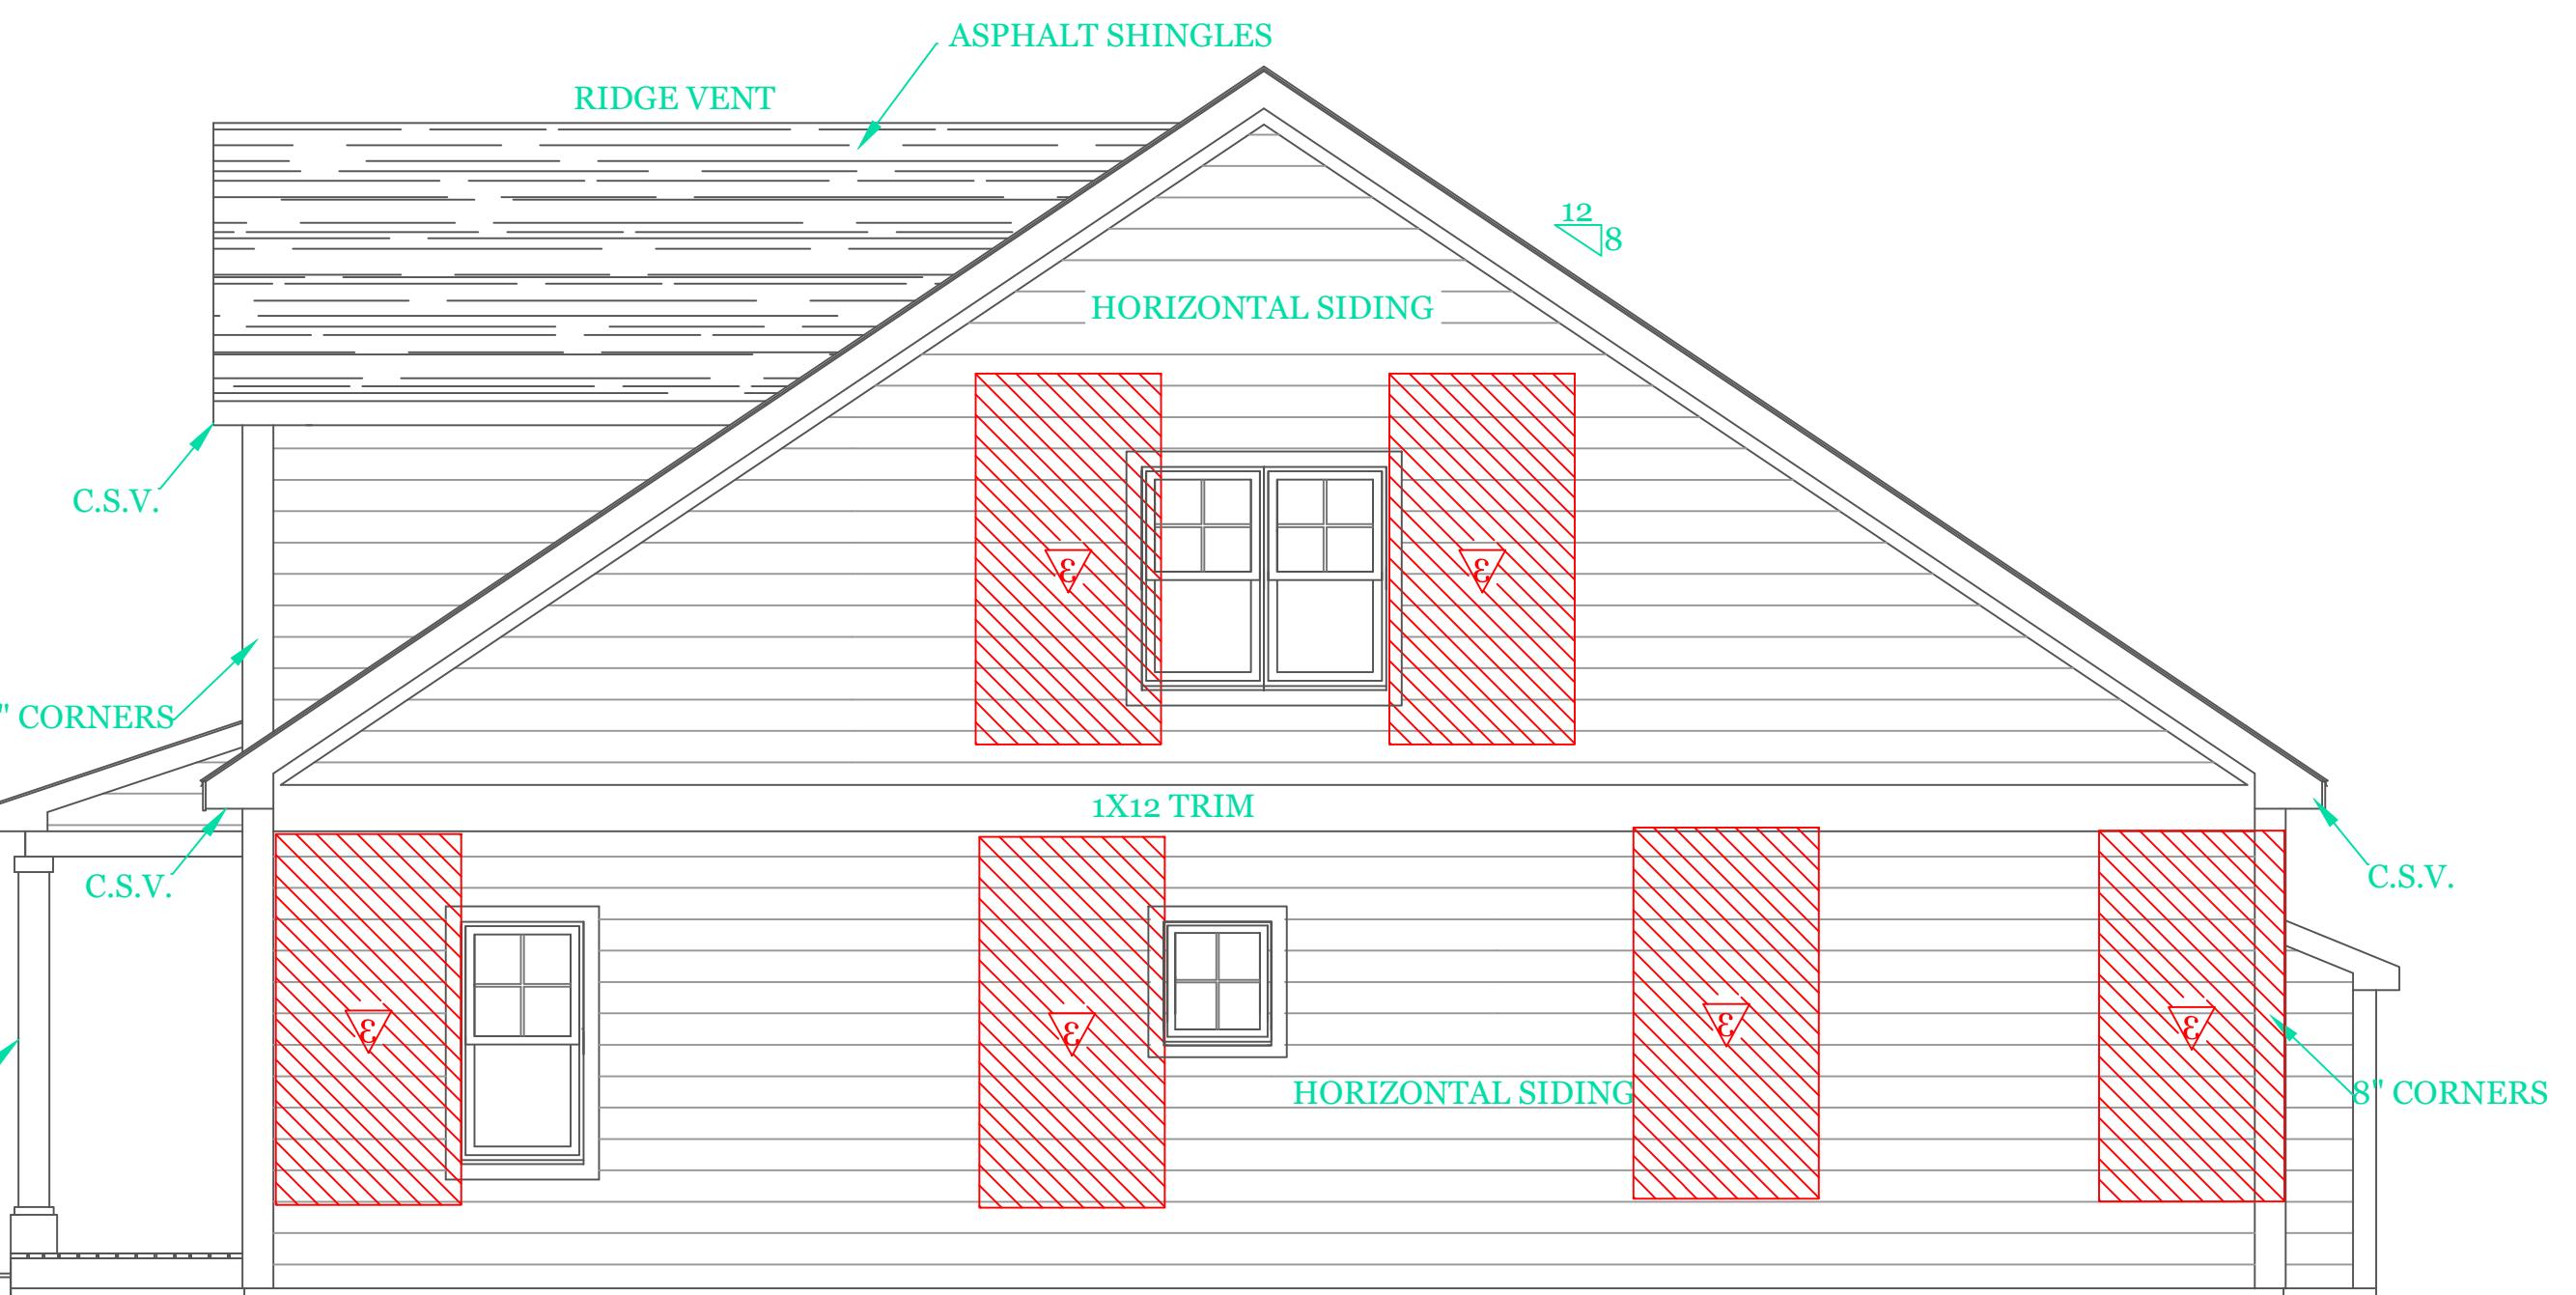


FRONT ELEVATION (1734 s.f.)


WOOD STRUCTURAL PANEL 15/32 CDX PLY WD. SHEATHING ON 16" STUD SPACING PANELS INSTALLED VERTICALLY
W/ 6d COMMON NAIL 6" O.C. @ EDGES & 12" O.C. INTERMEDIATE SUPPORTS

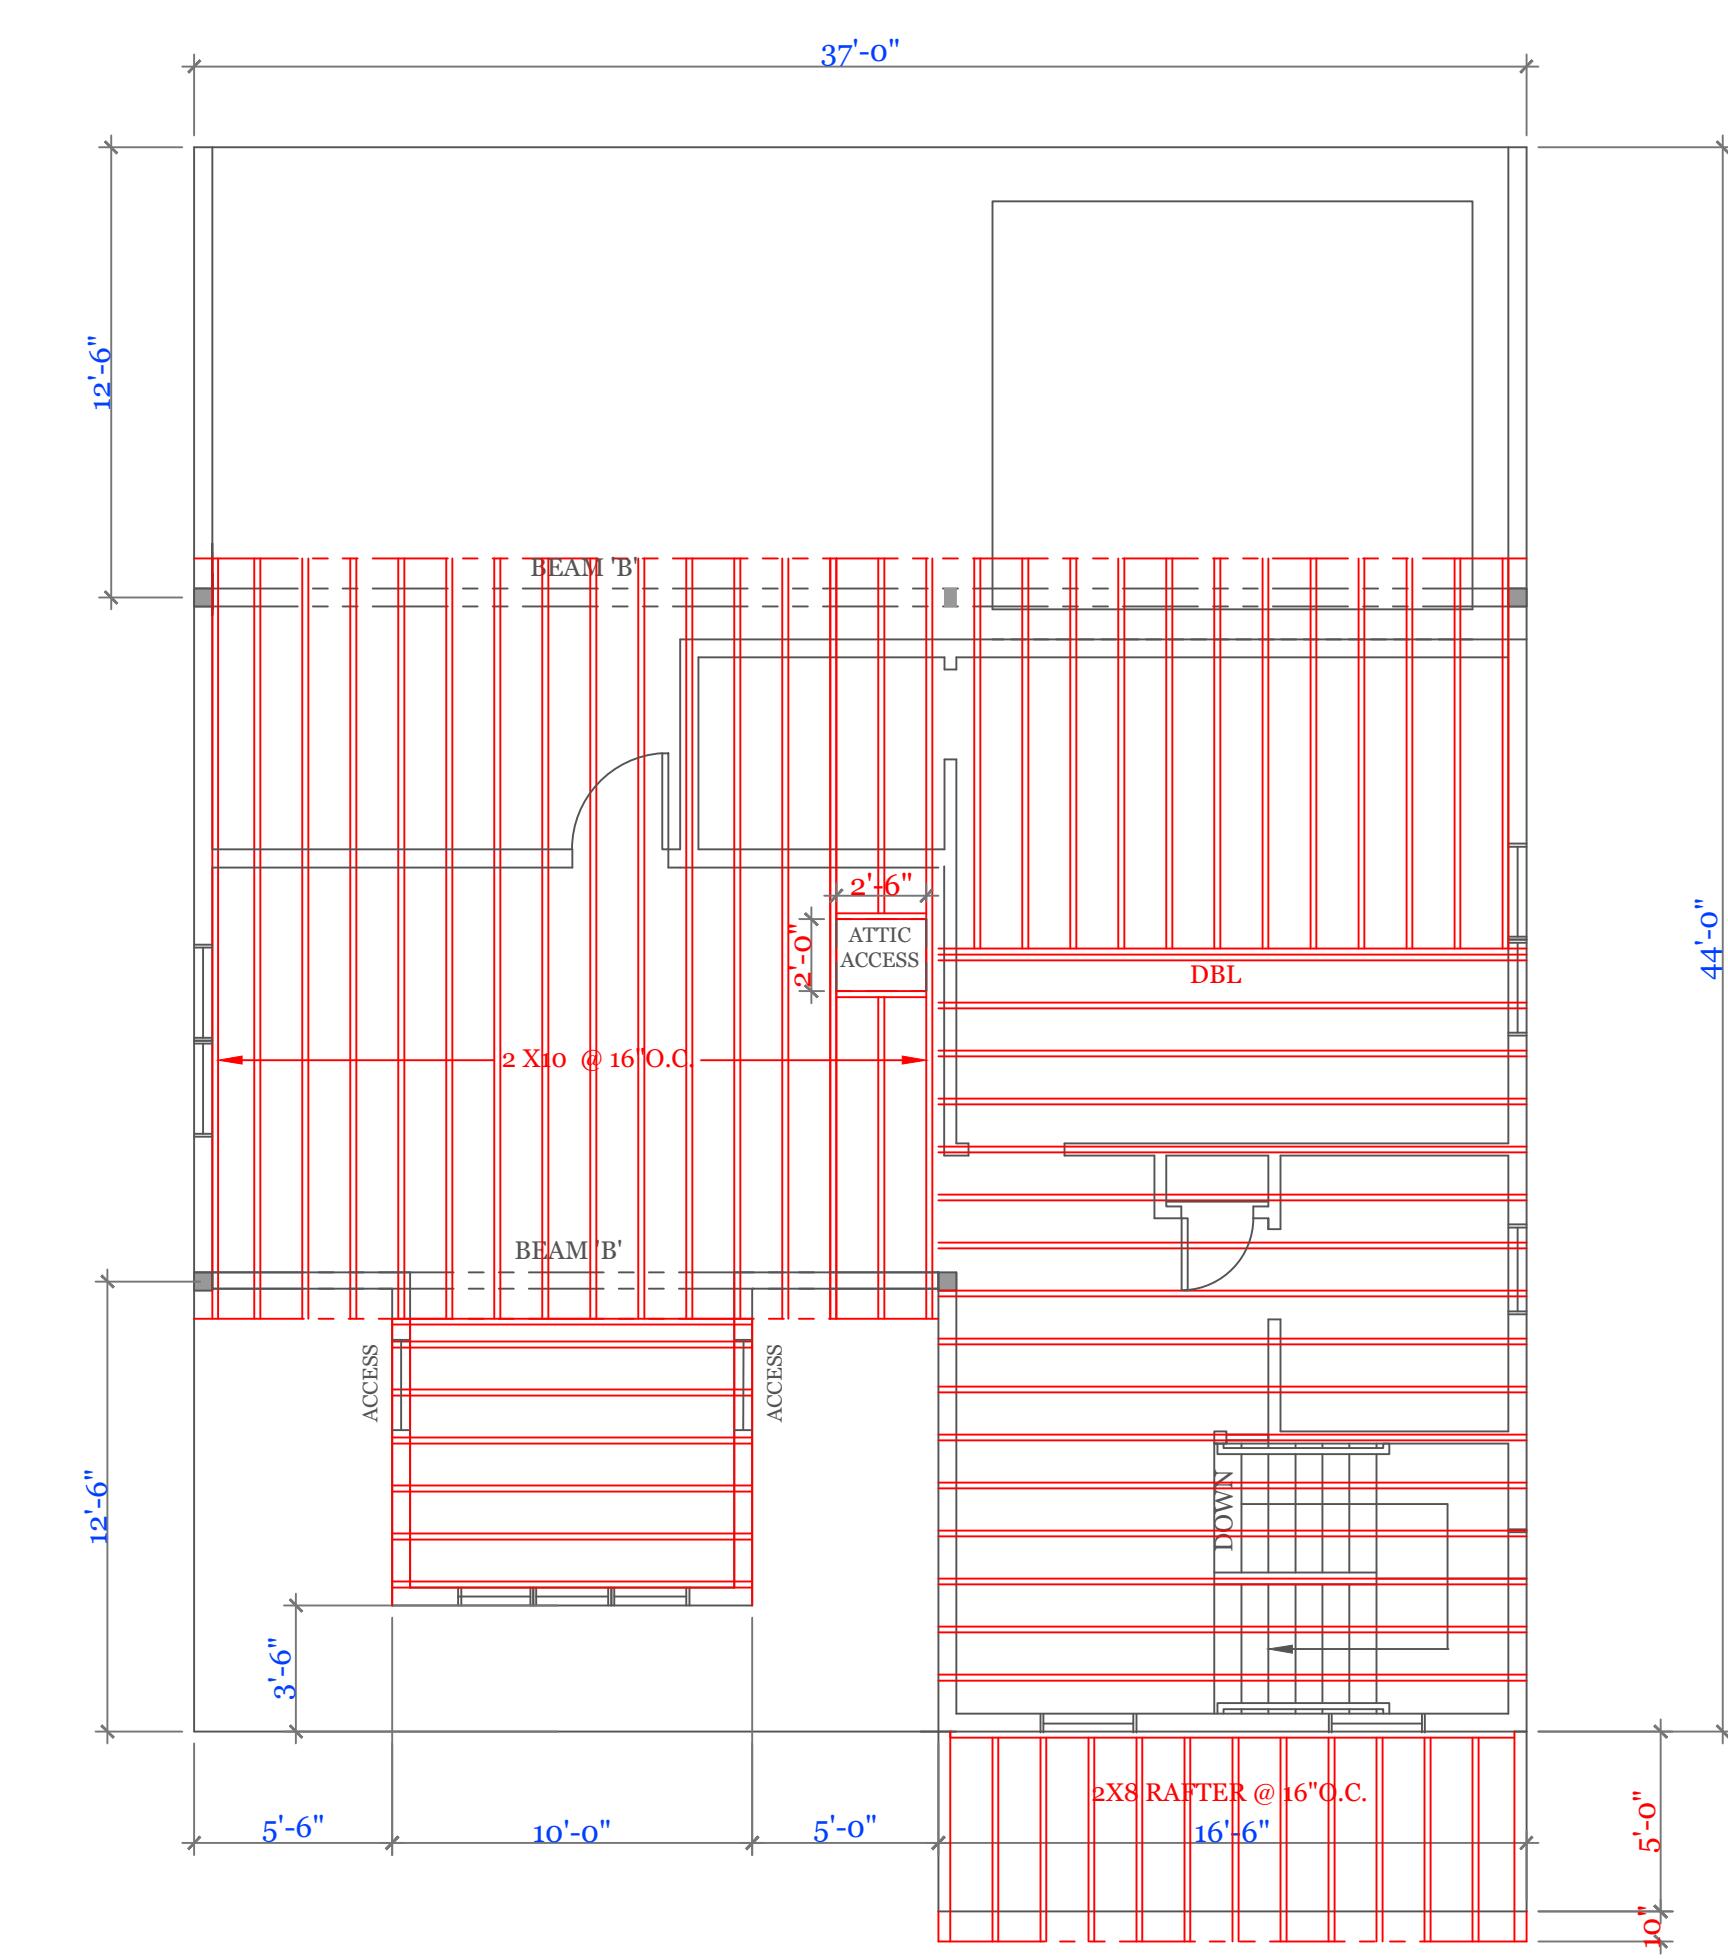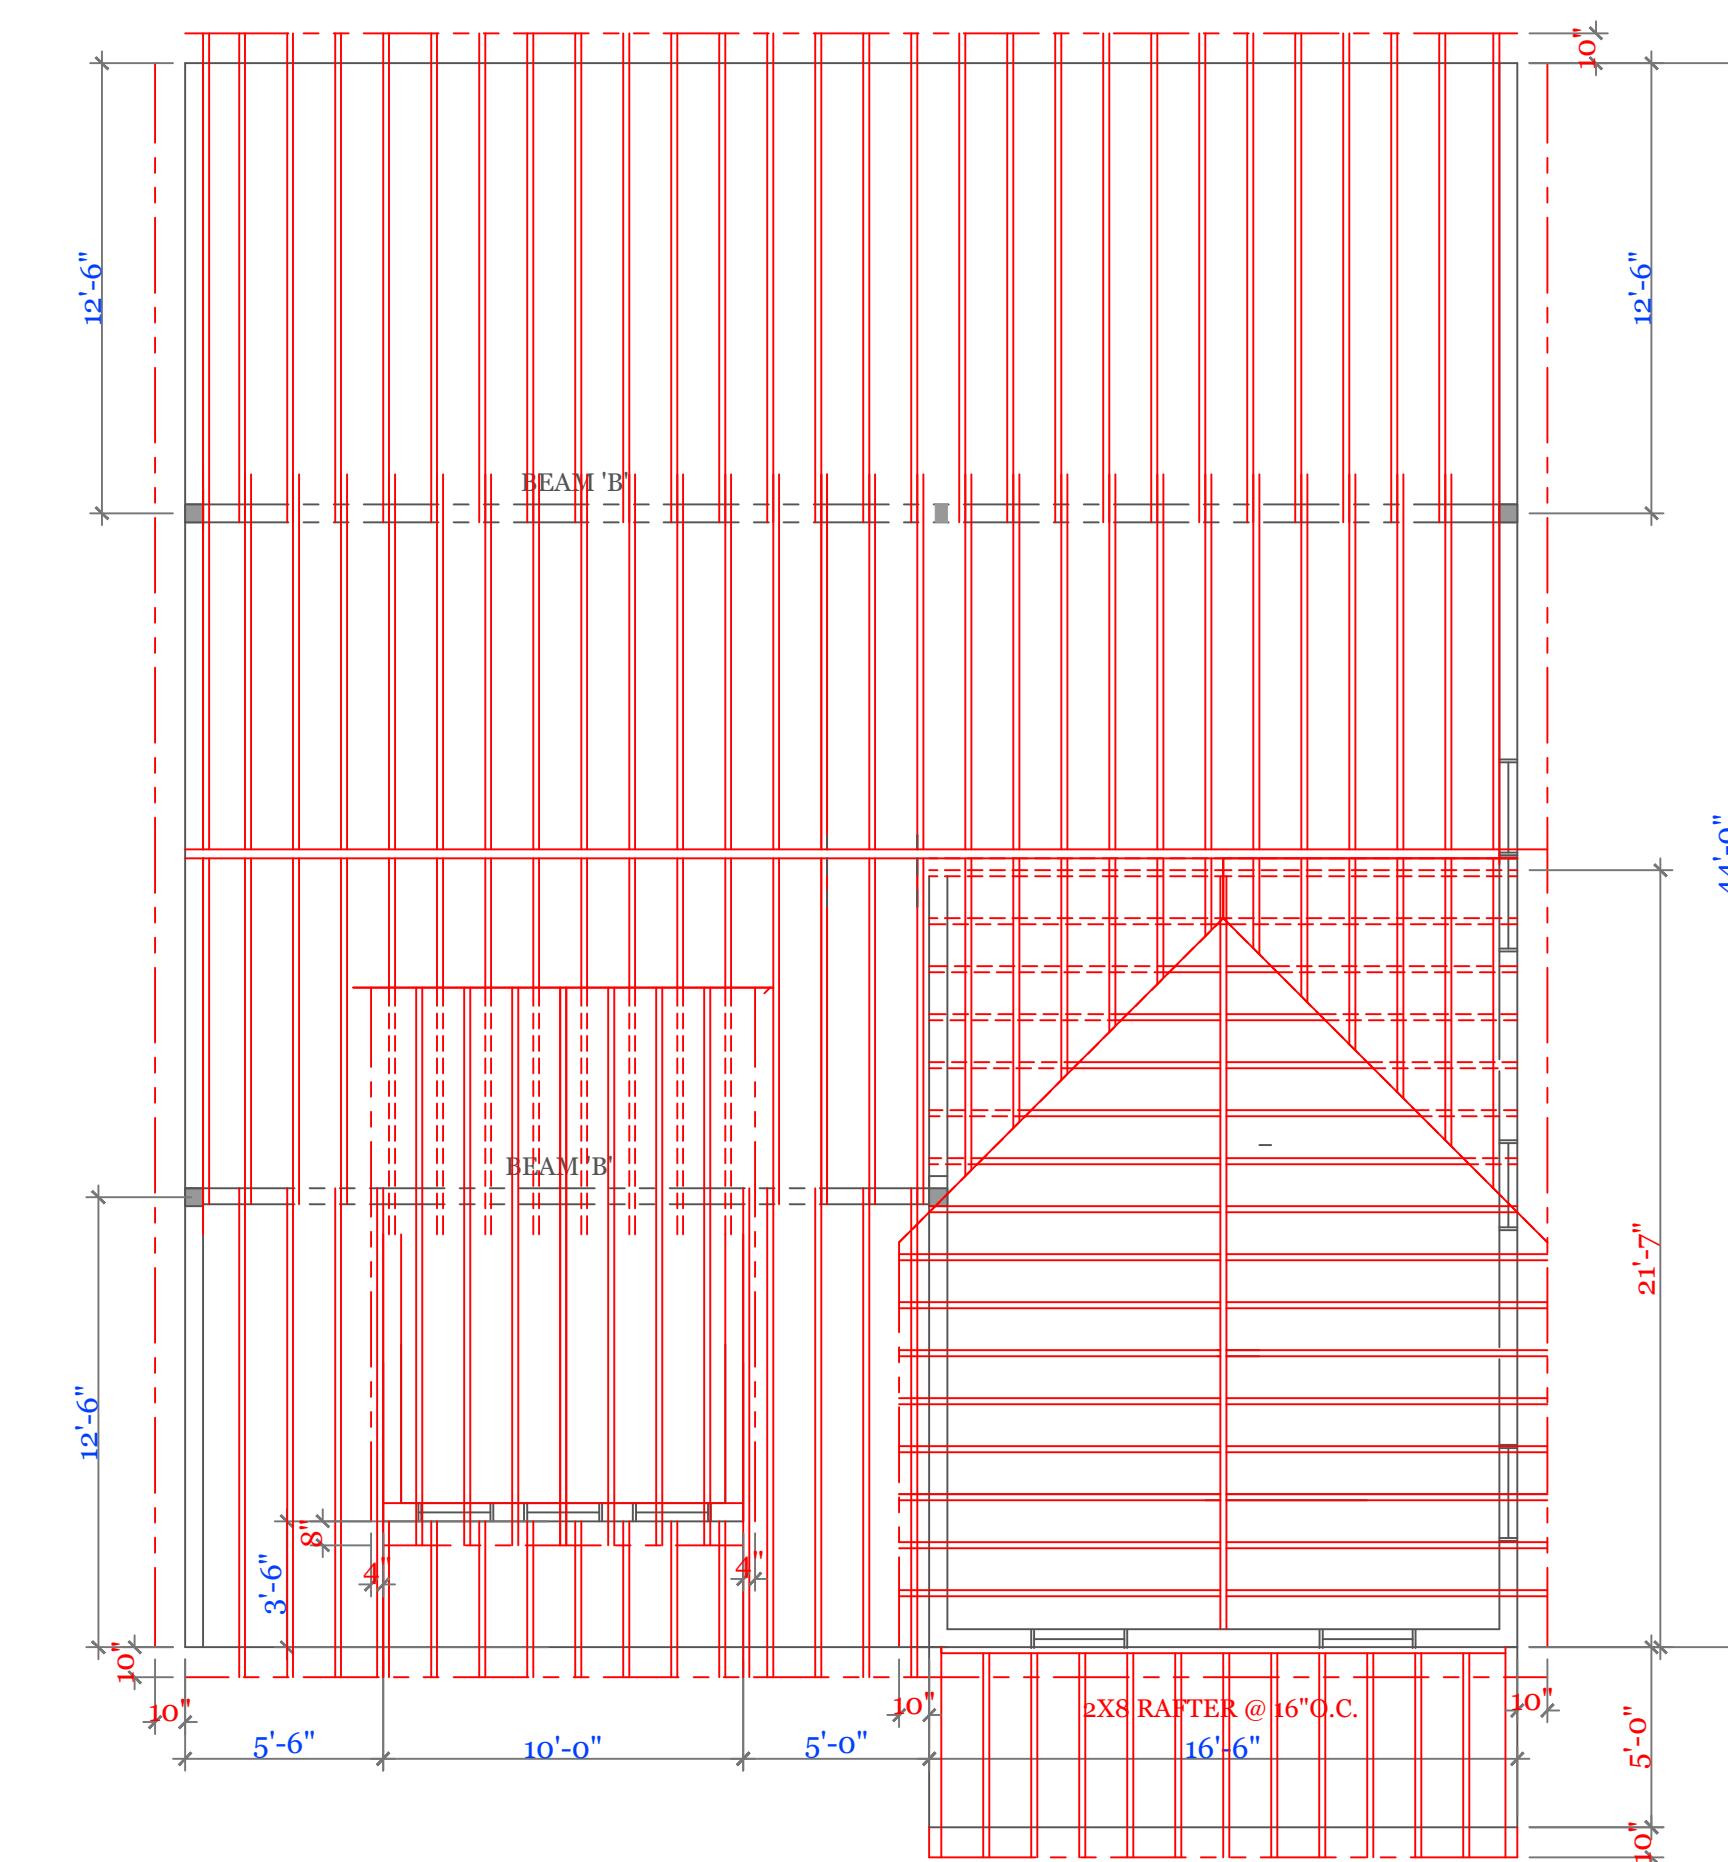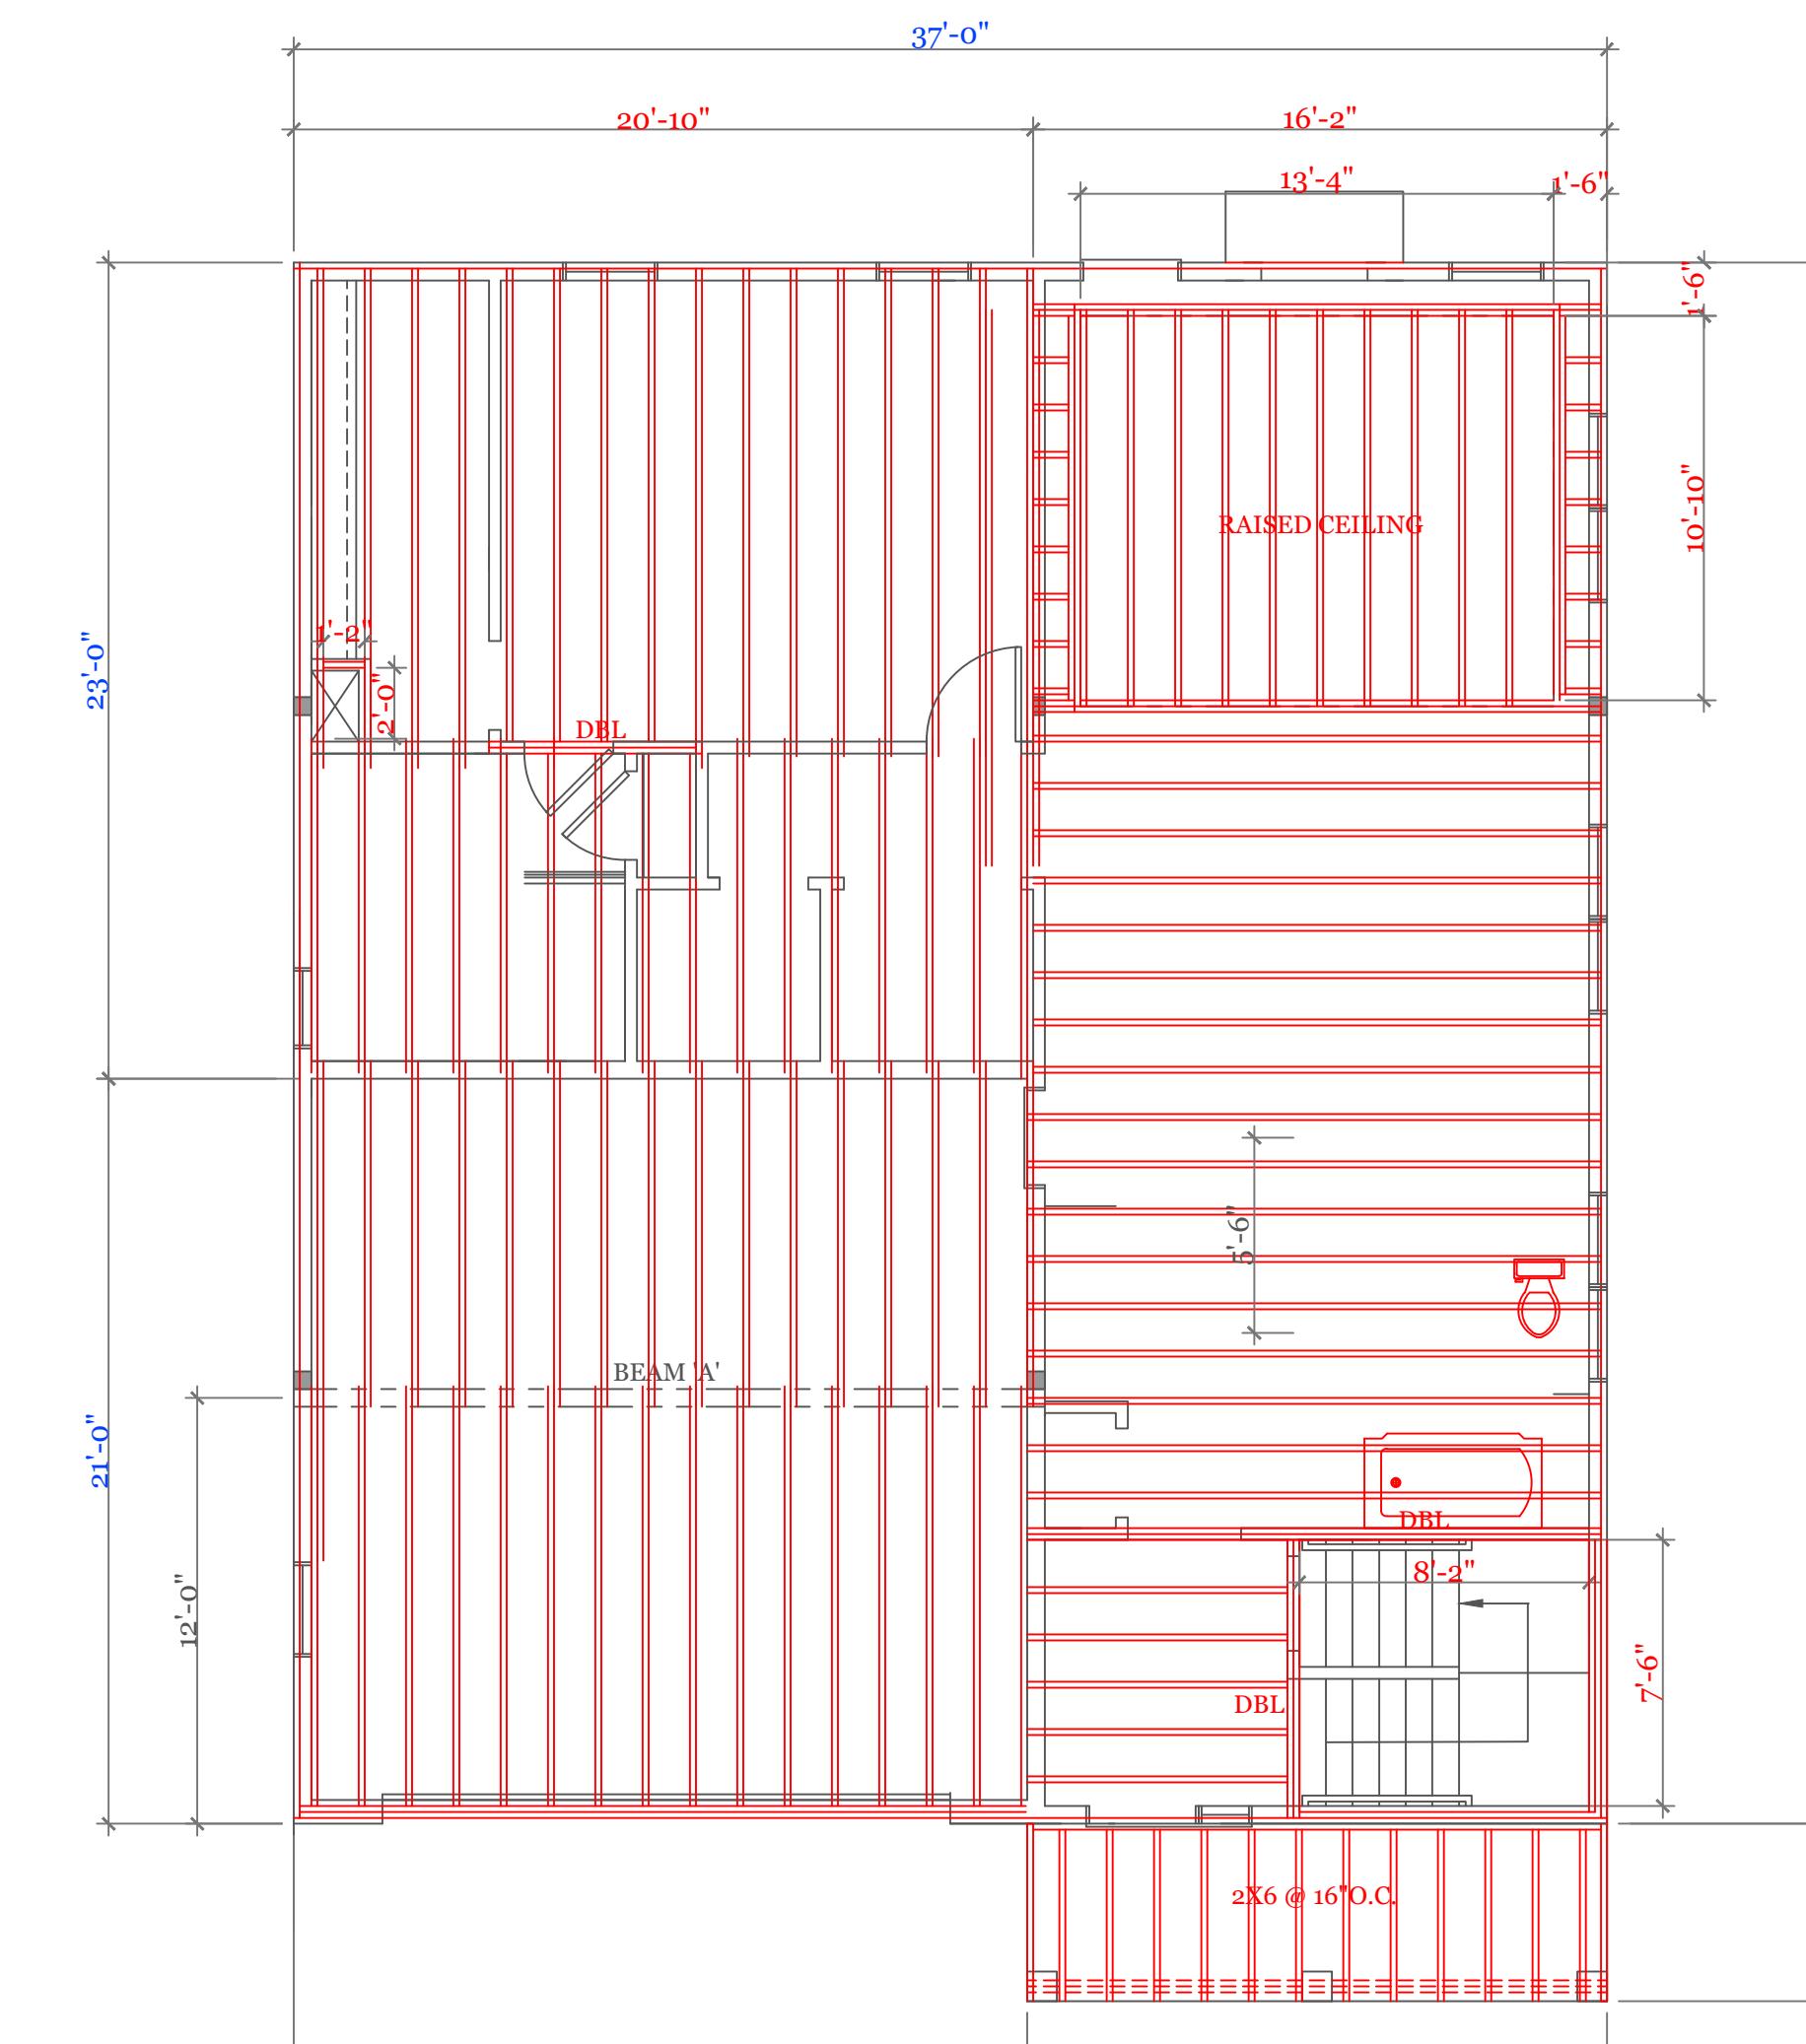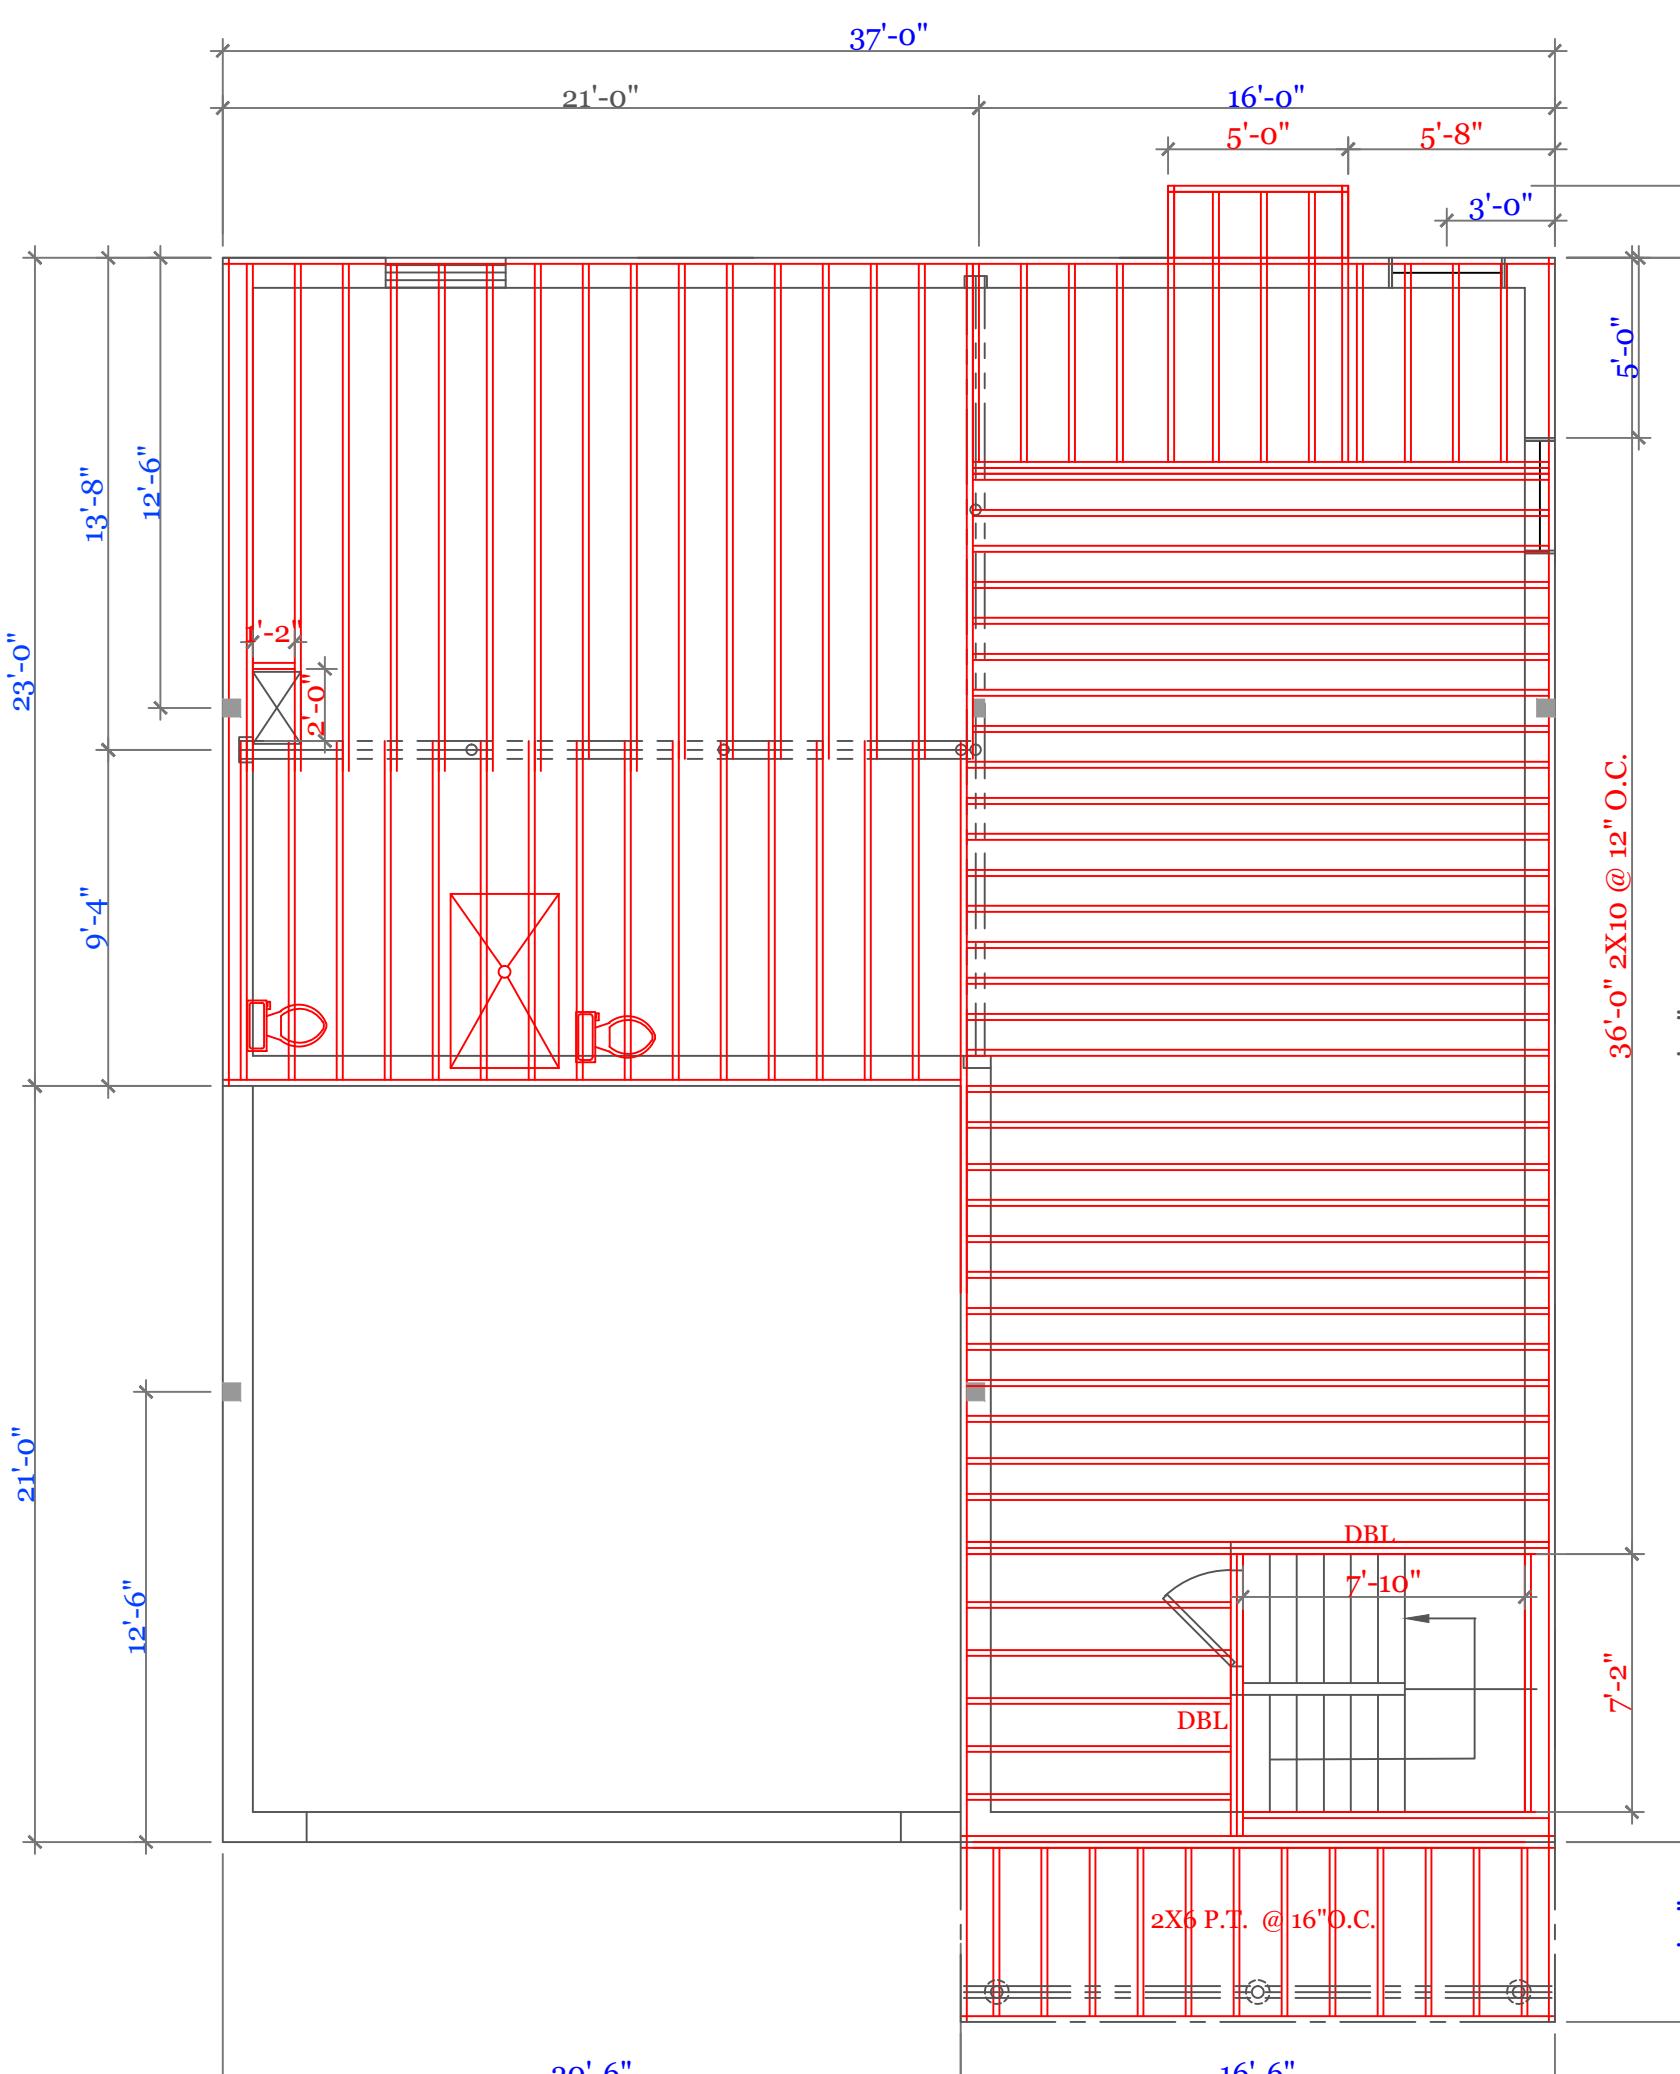

RIGHT SIDE ELEVATION



LEFT SIDE ELEVATION

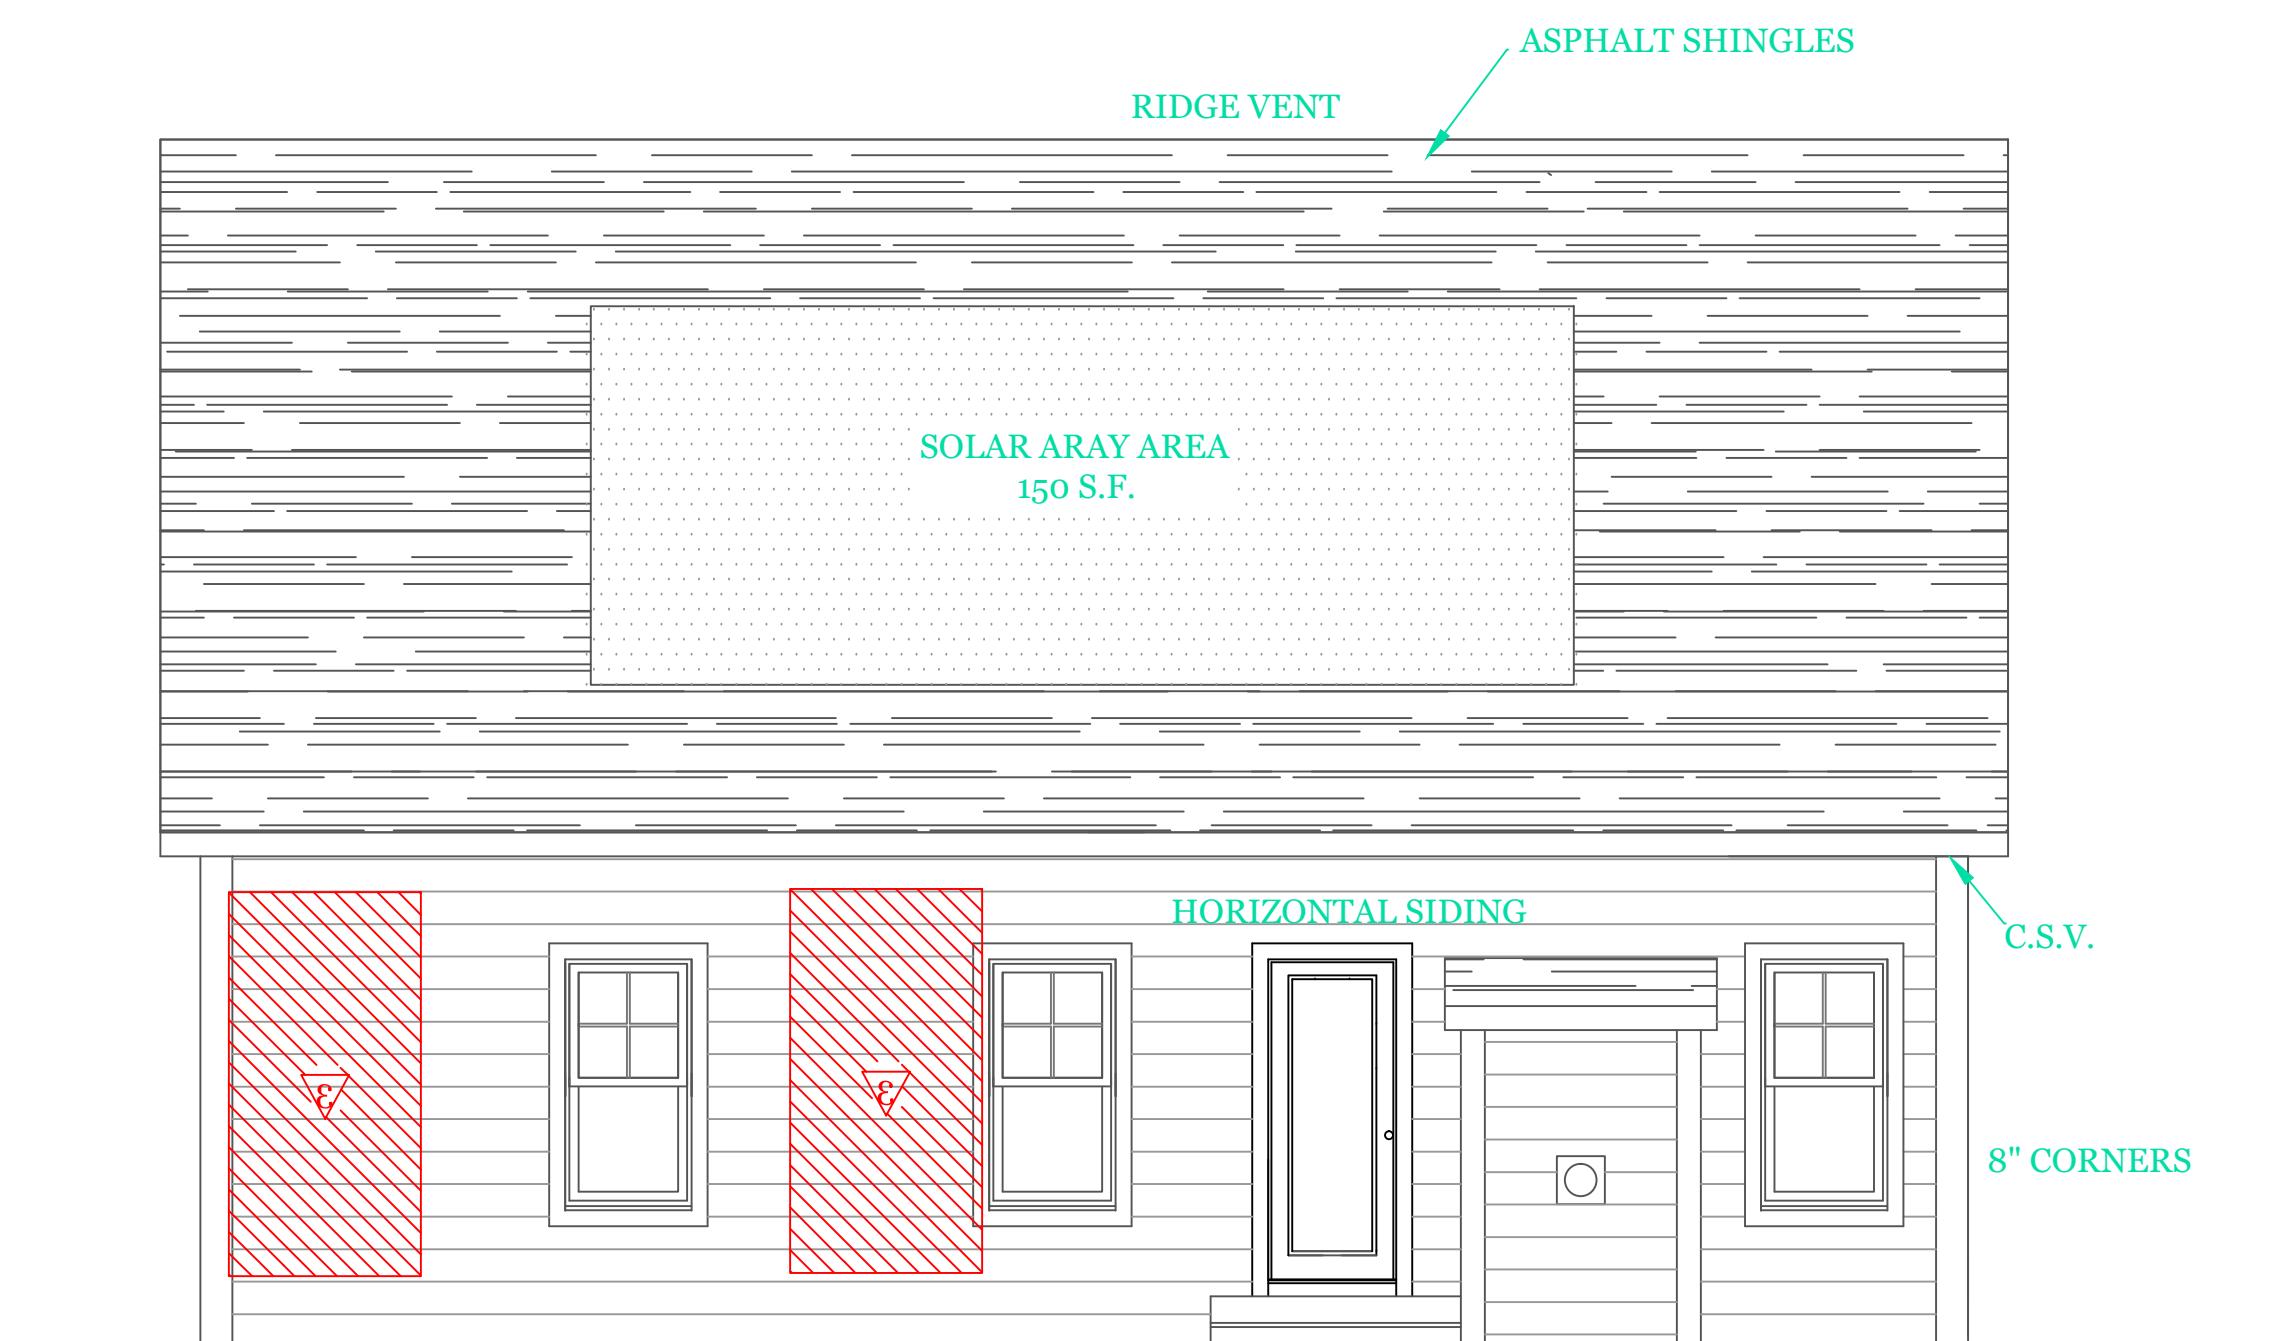

REAR ELEVATION

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UNIT 'C' 1734 S.F.
HIGGINS FARM AT
SALISBURY HILL
ELEVATIONS

UNIT 'C' GR

DATE: 9/28/2022 R5/5/23

SCALE: 1/4" = 1'-0"

DRAWN BY: RCS

CHECKED BY: MJB



Sheet 1 OF 5

1

NOTES:

SYMBOL SCHEDULE:

- [V] VENT
- [S] SMOKE AND CARBON DETECTOR
- (S) SMOKE DETECTOR
- [H] HEAT DETECTOR
- [■] BEARING POINT W/ SQUASH BLOCK

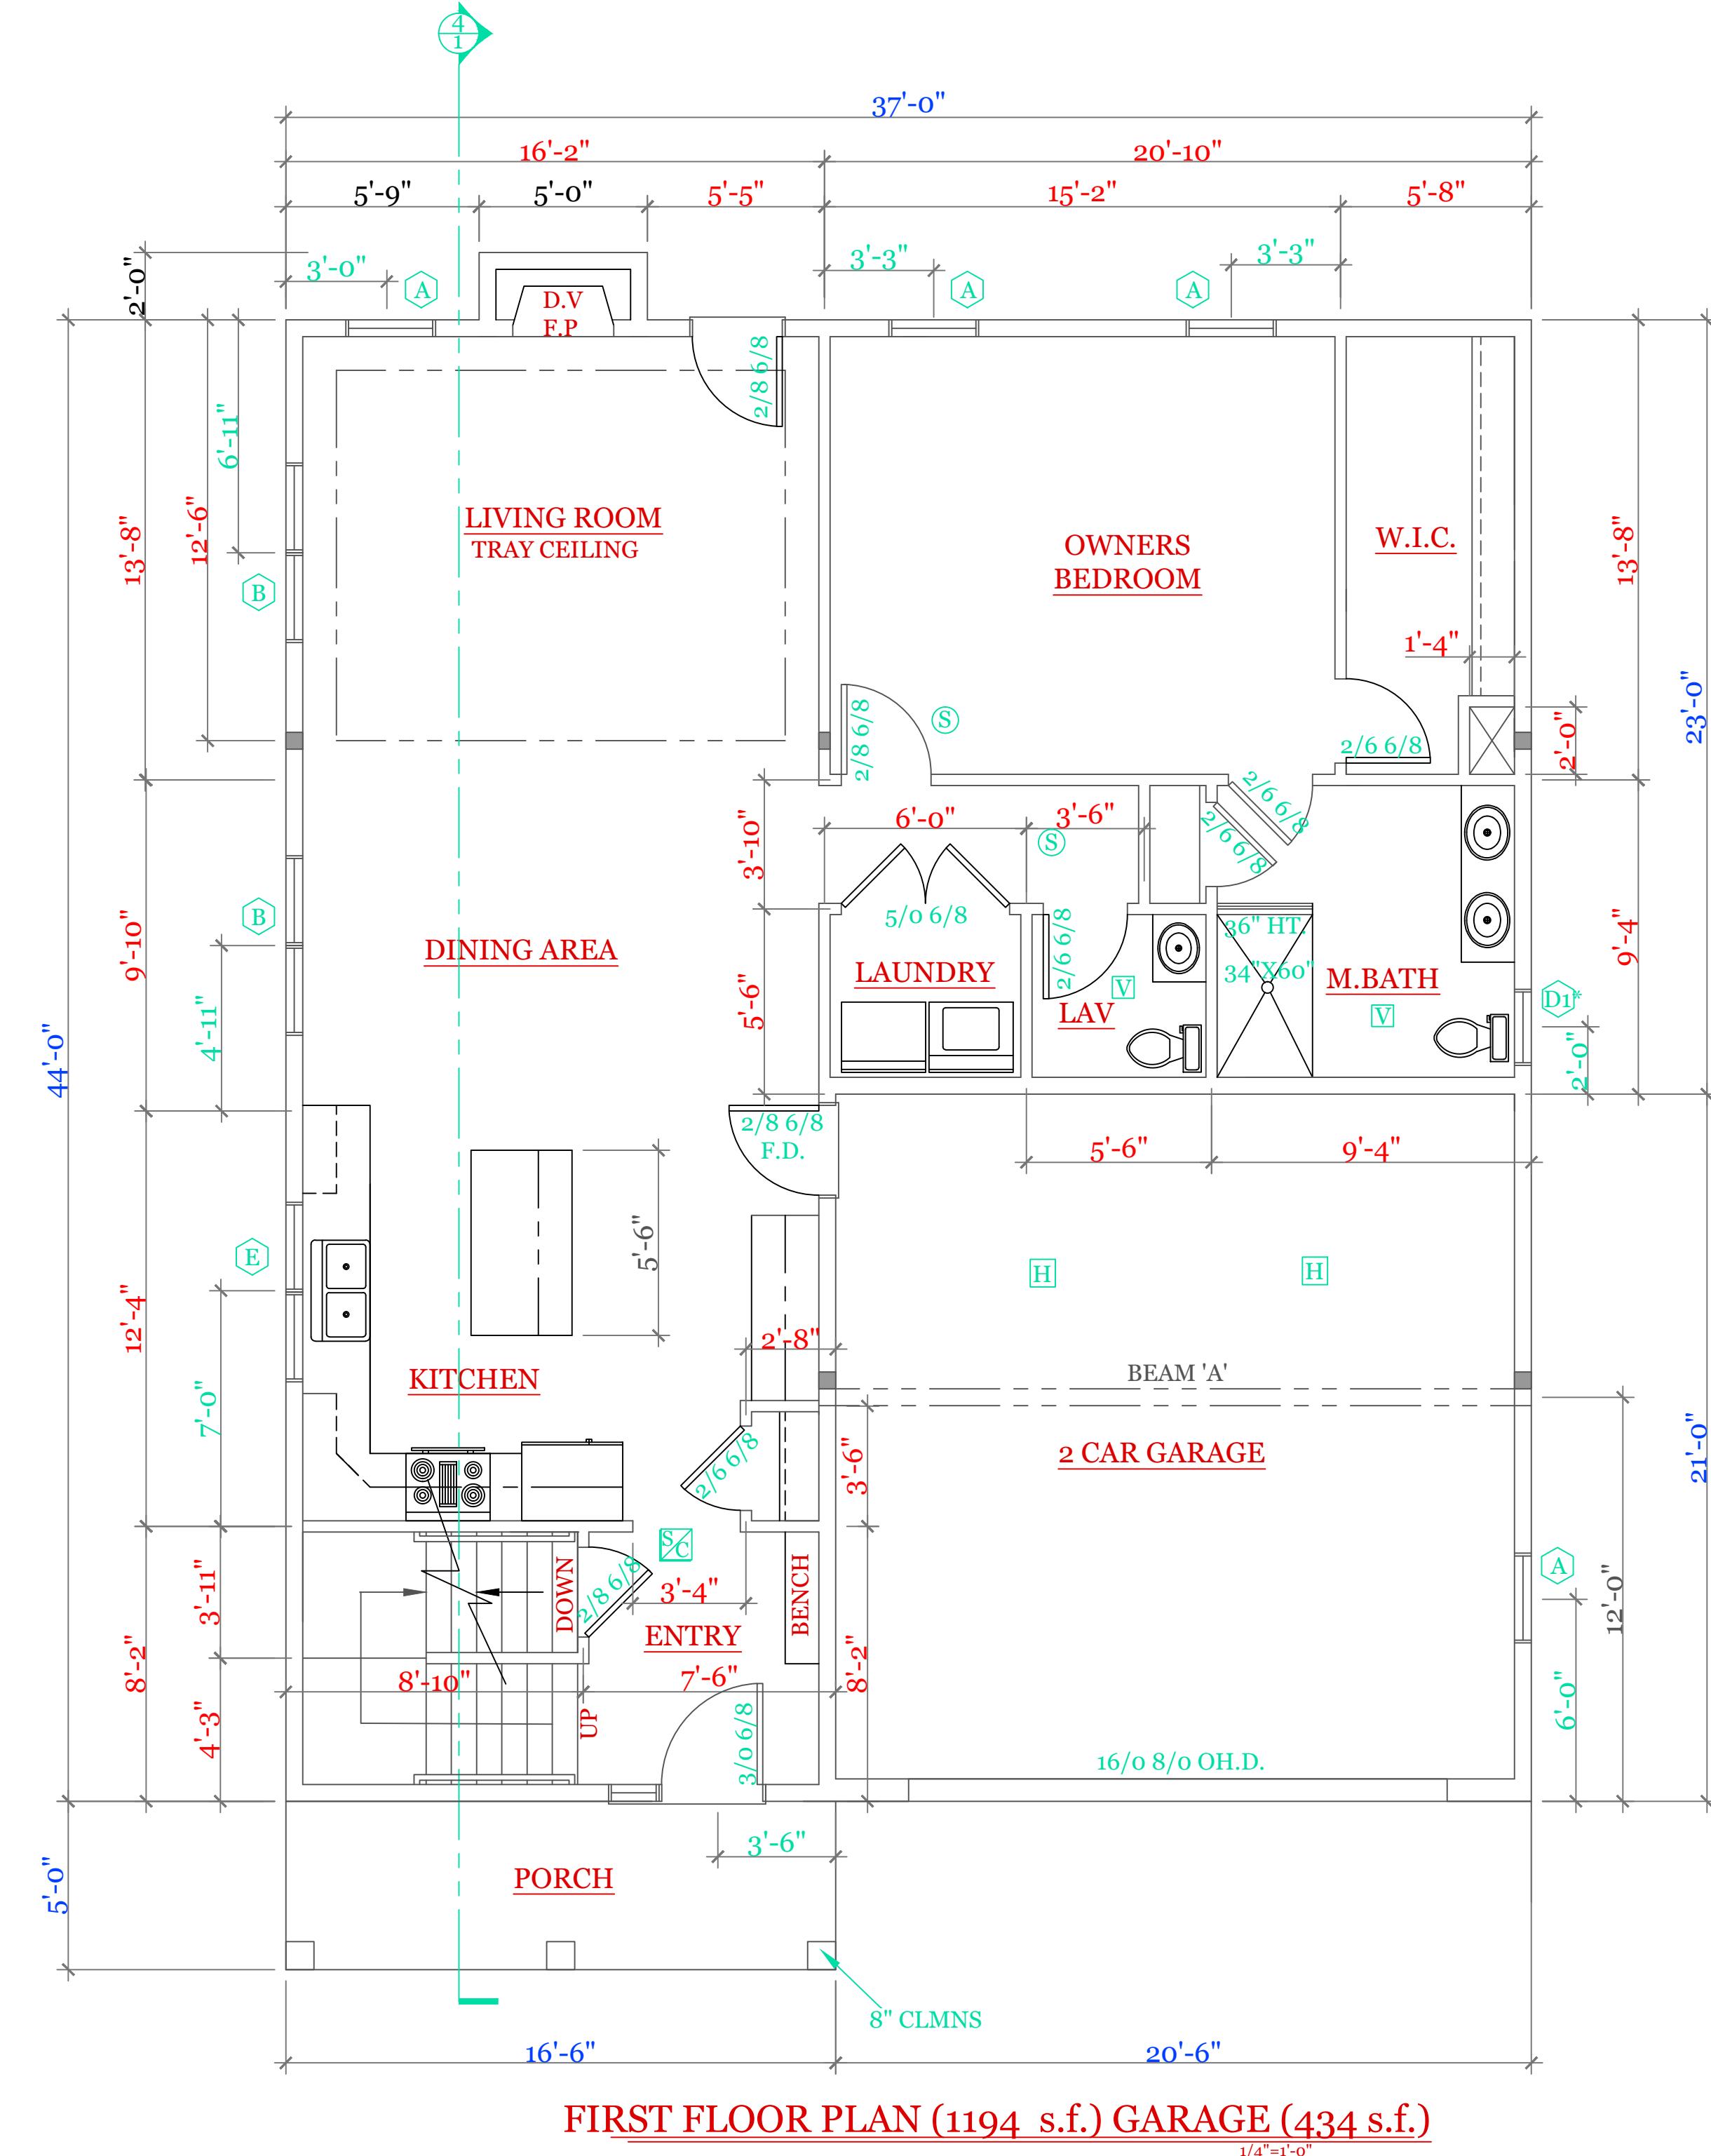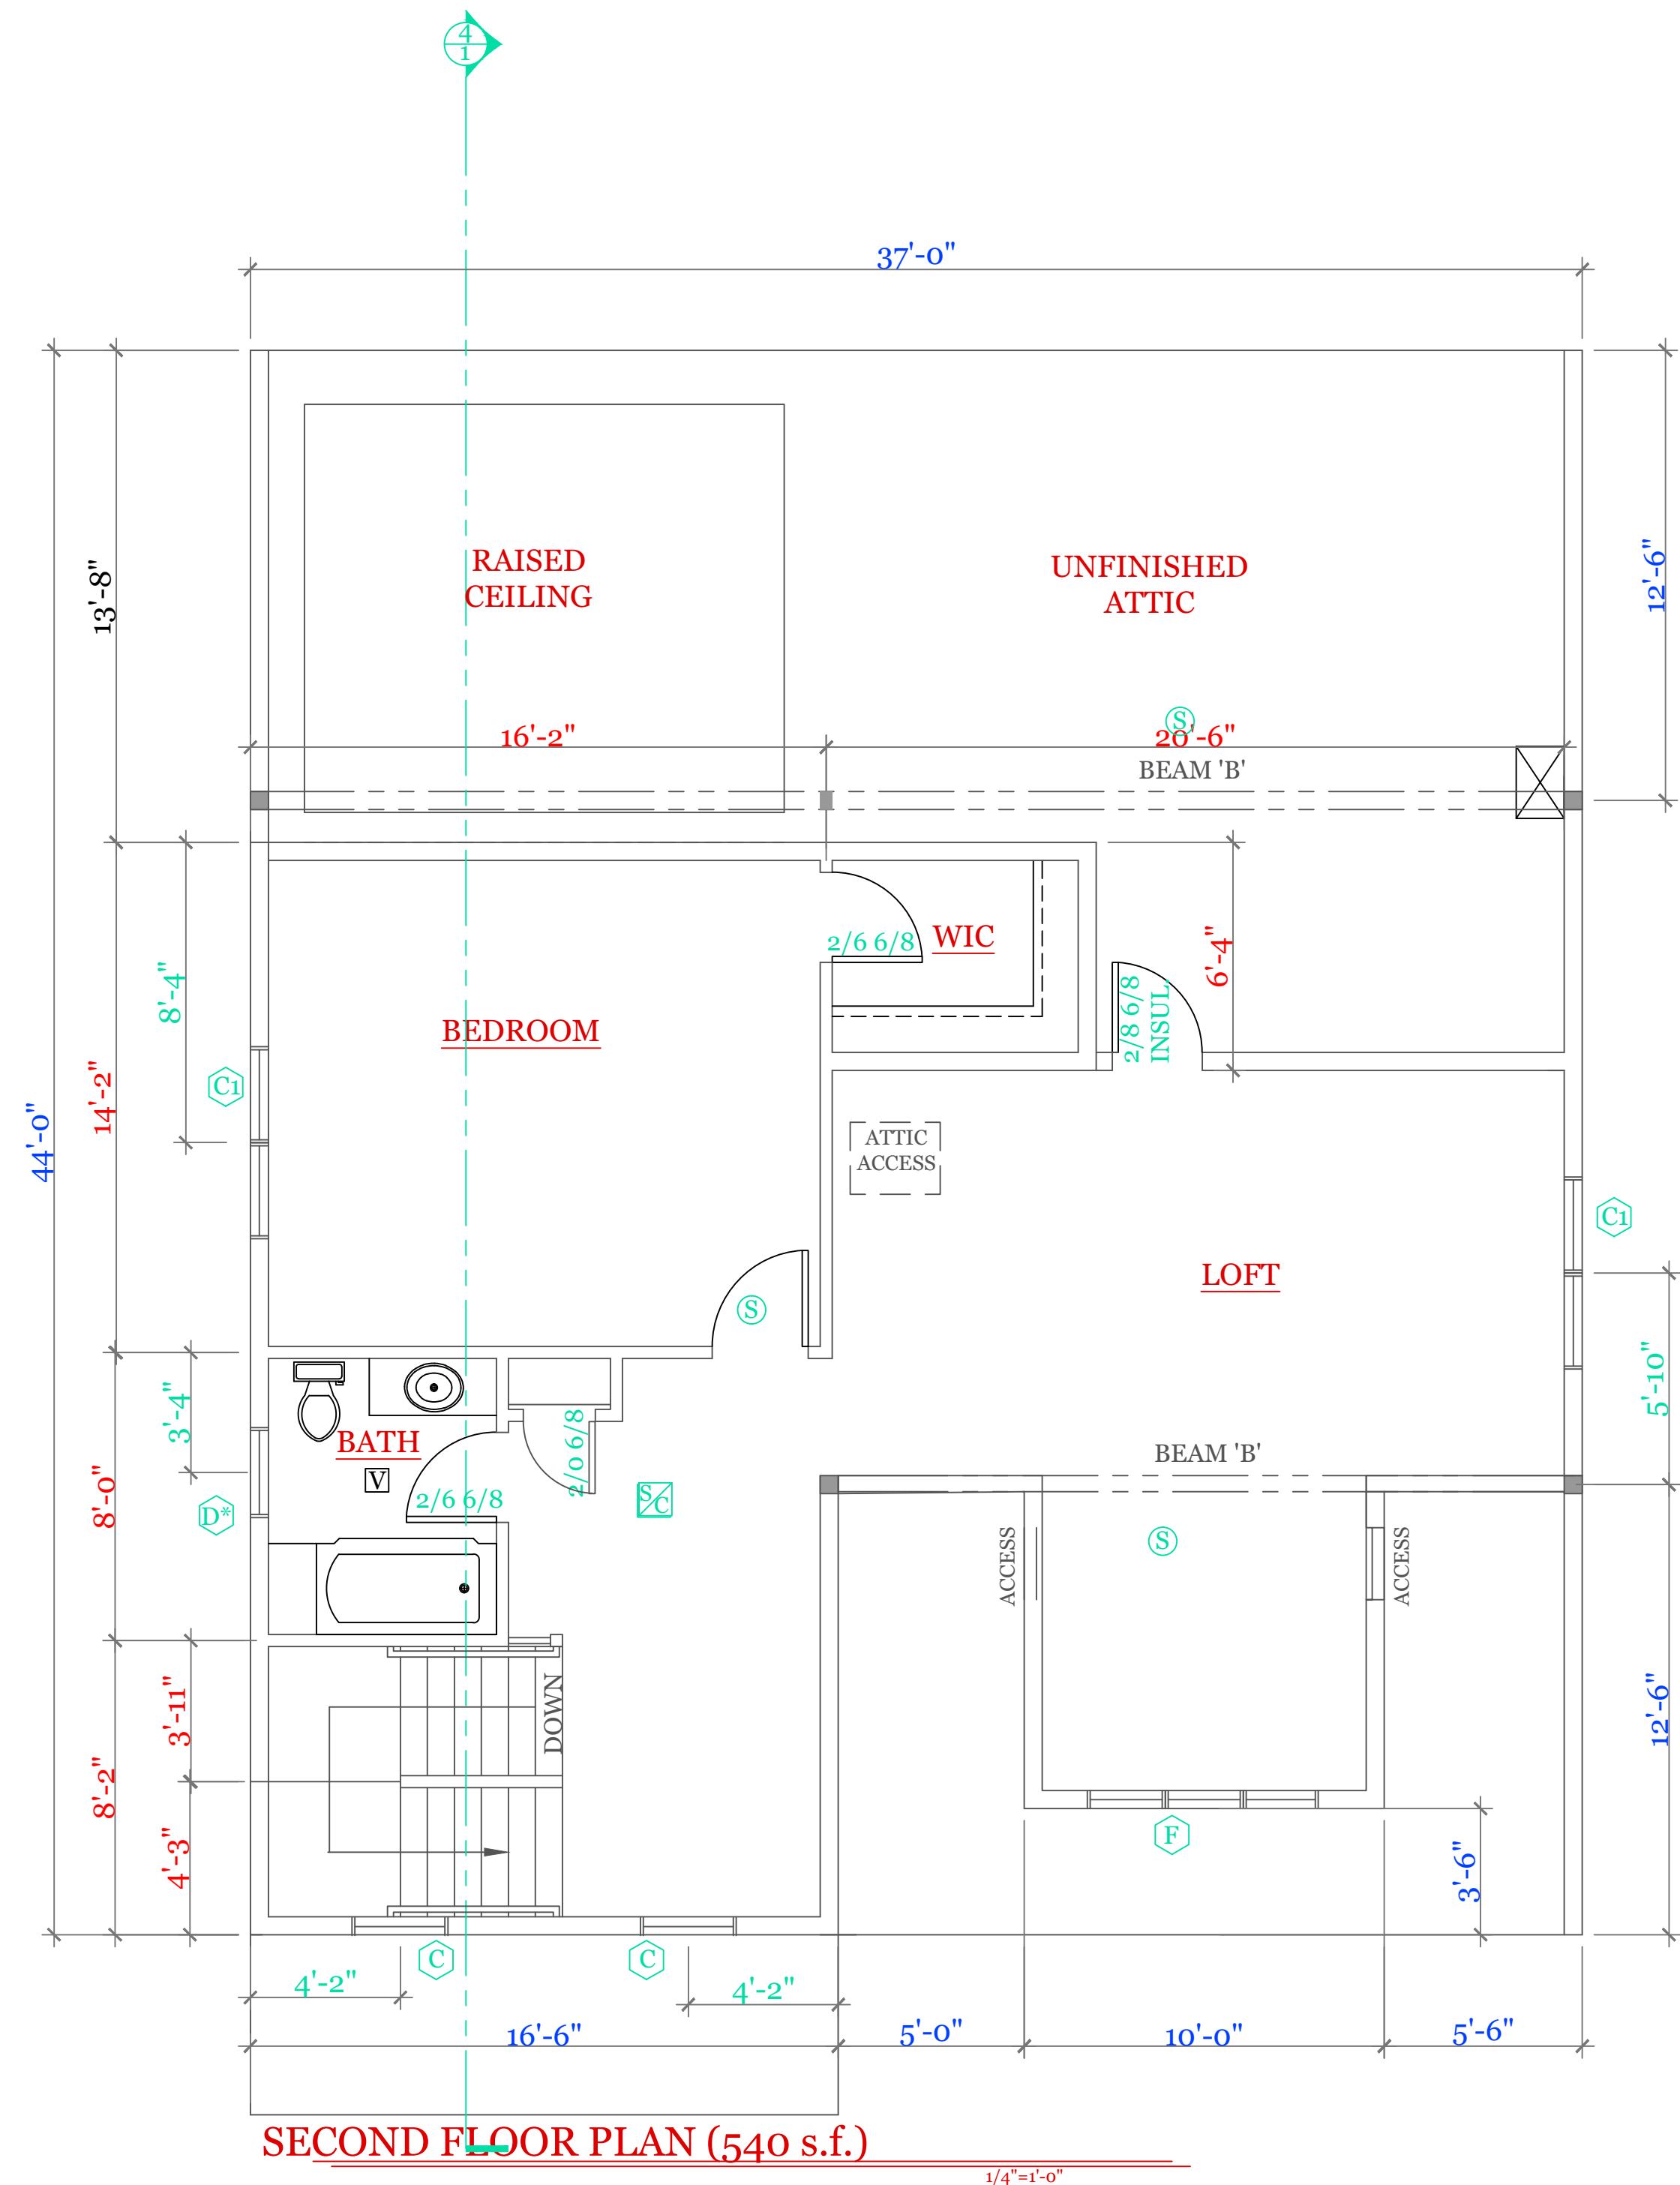

WINDOW SCHEDULE: HARVEY LANSING			
INDEX	QUA	CATALOG	ROUGH OPENING
A	4	10000-1	2'-8 1/8" X 5'-6"
B	2	11000-1	5'-4 1/2" X 5'-6"
C	2	12000-1	2'-8 1/8" X 4'-9"
C1	2	13000-1	5'-4 1/2" X 4'-9"
D*	2	14000-1 TEMPERED	2'-4 3/8" X 2'-8"
E	1	15000-1	4'-0 1/2" X 3'-5 3/8"
F	1	16000-3	7'-9" X 3'-1"
FRONT	1	17000-1	4'-3 3/8" X 6'-10 1/2"
REAR	1	18000-1	3'-2 3/8" X 6'-10 1/2"

NOTES: CONSULT TABLE 603.7(1) JACKS & HEADERS

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Holden Ma.

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UNIT 'C' 1734 S.F.
HIGGINS FARM AT
SALISBURY HILL

FIRST & SECOND
FLOOR PLANS
WINDOW SCHEDULE

UNIT 'C' GR

DATE: 9/28/2022 R5/5/23

SCALE: 1/4"=1'-0"


DRAWN BY: RCS

CHECKED BY: MJB

Sheet 3 OF 5

3

TYPICAL BUILDING SECTION

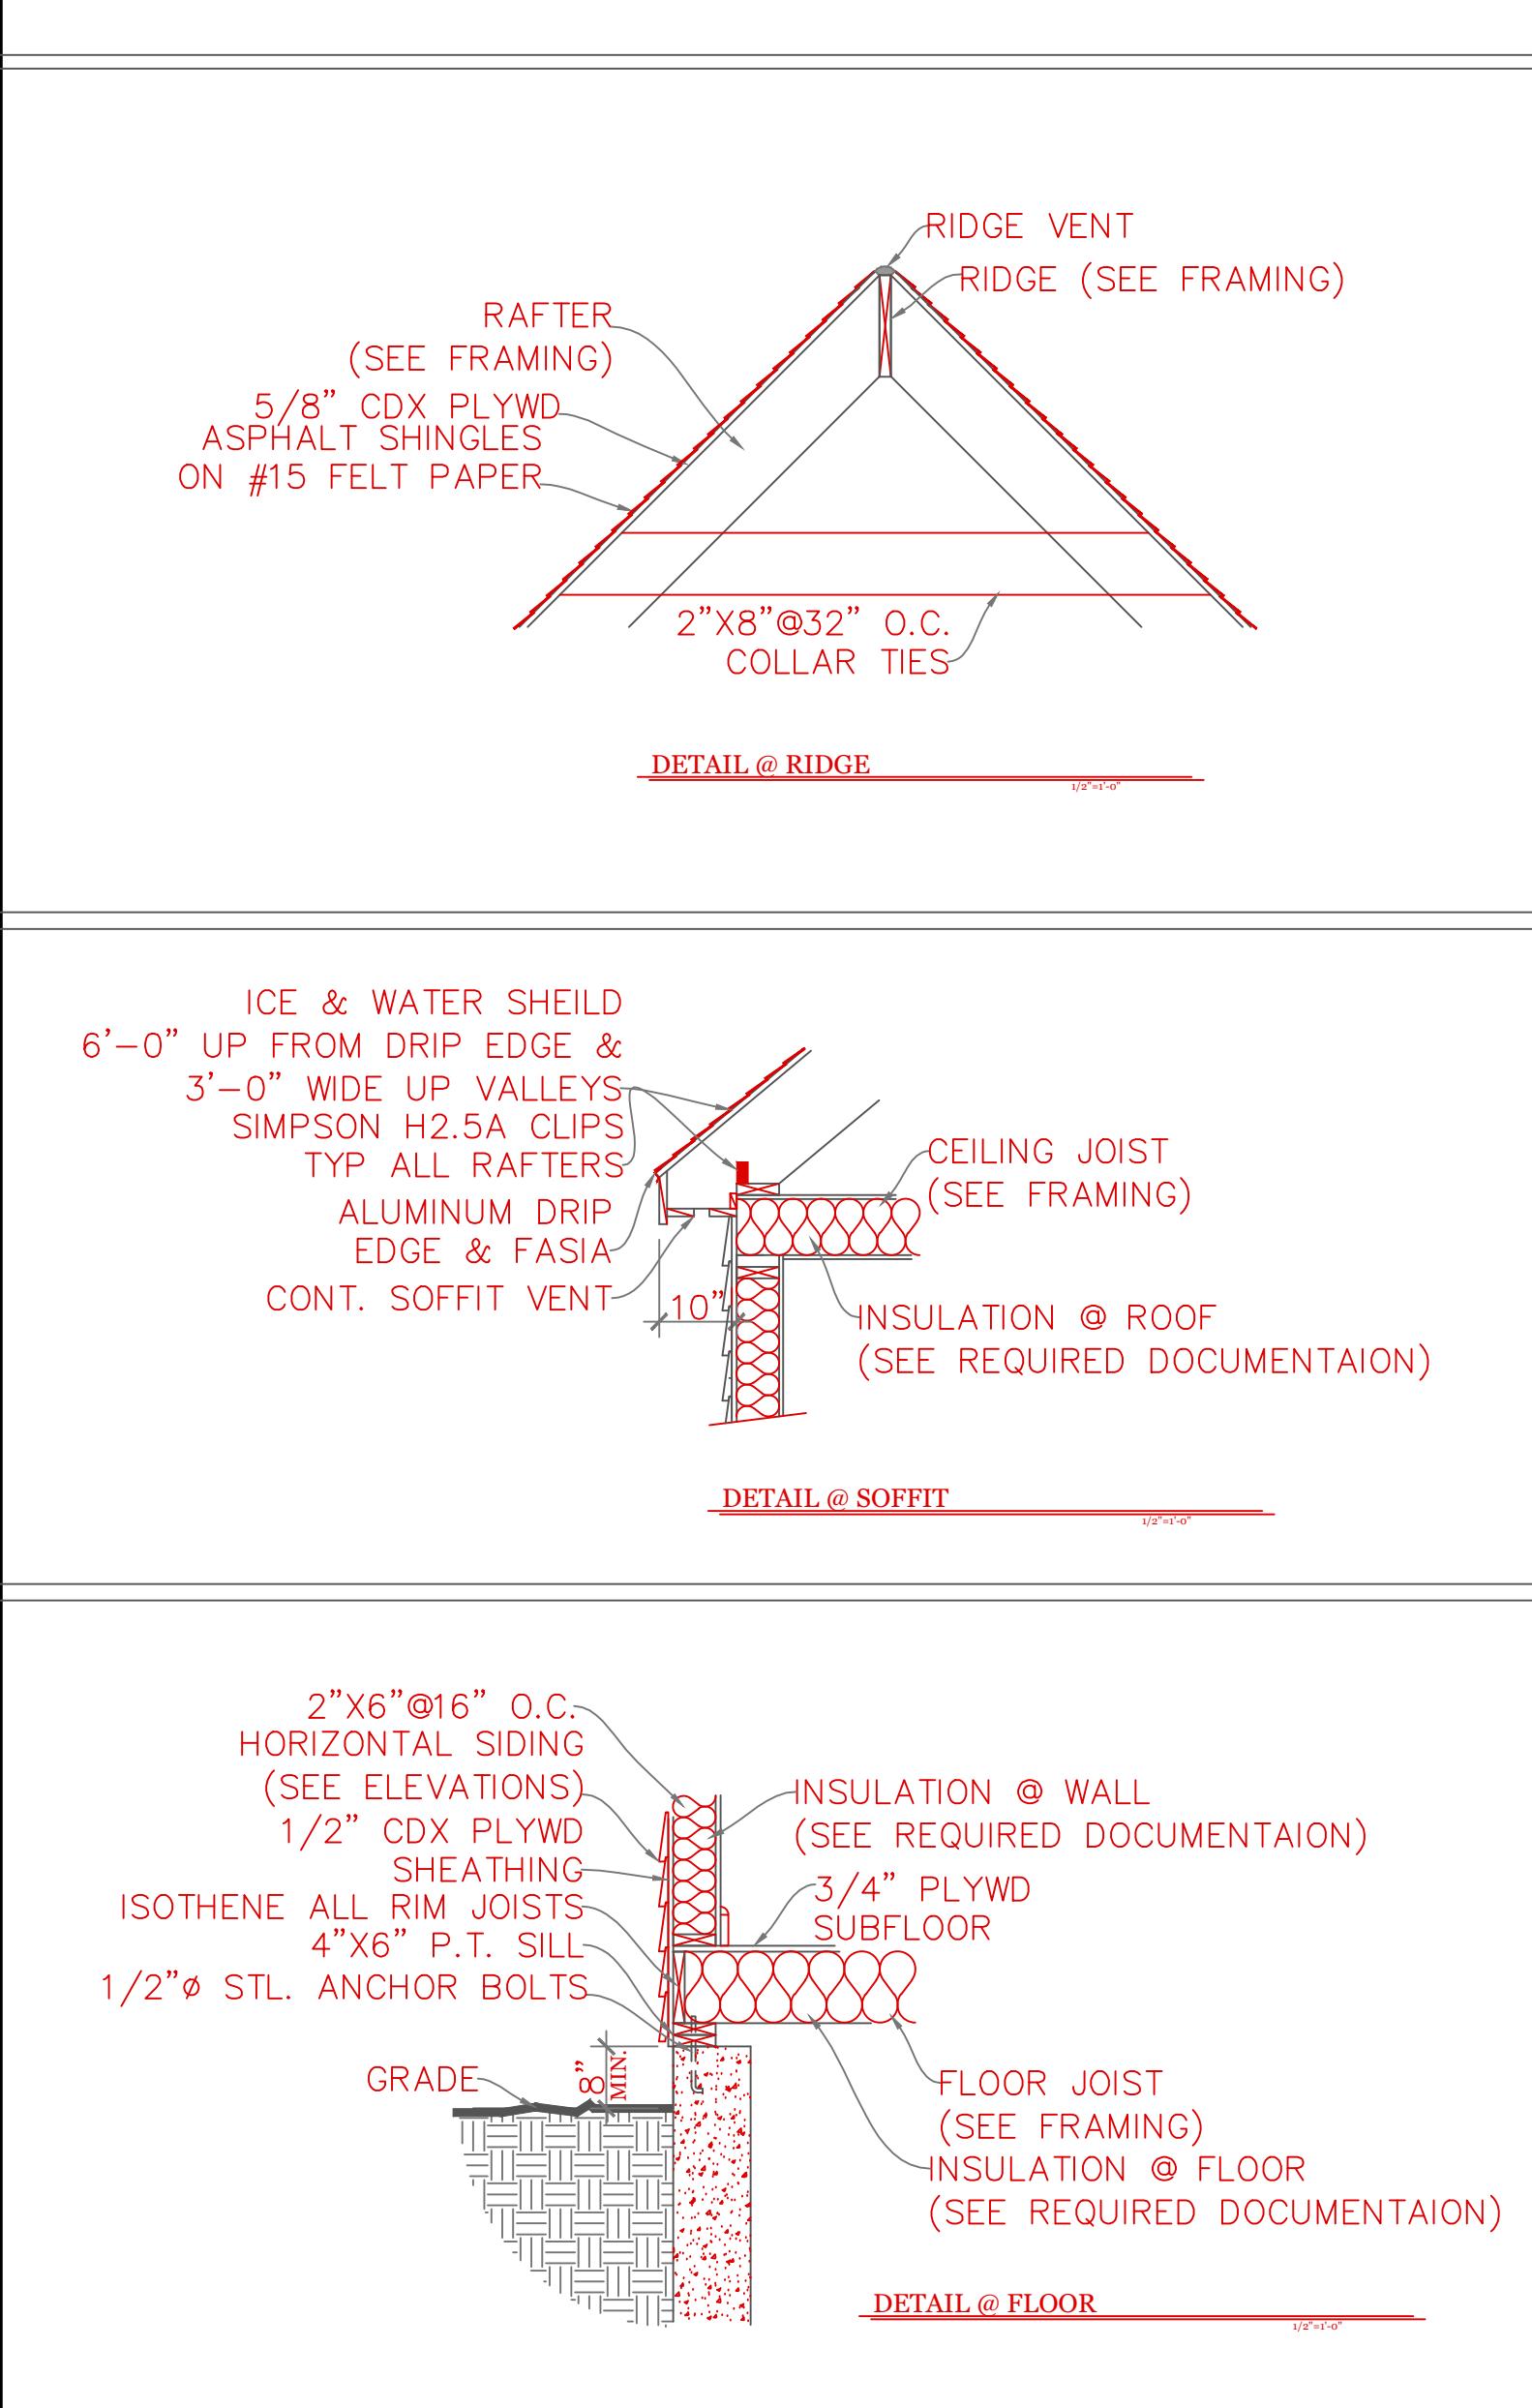

CONSTRUCTION SCHEDULE:		(UNLESS NOTED OTHERWISE ON PLAN)
1	RIDGE BOARD:	SEE FRAMING W/ RIDGE VENT
2	ROOF MATERIAL:	ASPHALT SHINGLES ON 15# ROOF FELT
3	ROOF SHEATHING	1/2" O.S.B. w/ 15# ROOF FELT
4	ROOF RAFTER:	SEE FRAMING
5	COLLAR TIES:	1X8 @ 32" O.C.
6	DRIP EDGE	ALUMINUM DRIP EDGE
7	SOFFIT:	CONT. SOFFIT VENT
8	CEILING JOIST	SEE FRAMING
9	ATTIC INSULATION	R-38
10	EXT WALL:	2"X6" @ 16" O.C.
11	EXT. SHEATHING	1/2" O.S.B. w/ HOUSE WRAP
12	EXT. FINISH	SEE ELEVATIONS
13	INSULATION@WALL	R-21
14	INTERIOR WALL	2"X4"@16"O.C.
15	SUB FLOOR:	3/4" ADVANTEK GLUED & NAILED
16	JOIST:	SEE FRAMING.
17	SILL:	2"X6" P.T. SILL W/ 2X6 KD TOP PLATE
18	INSULATION @ FLOOR	R-30
19	ANCHOR:	1/2"Ø STL ANCHOR BOLTS
20	BEAM:	SEE FRAMING PLAN
21	COLUMN:	3 1/2" L.C.
22	FND. WALL:	10"X7'-10" CONC. WALL
23	SLAB:	SEE FOUNDATION NOTES
24	FOOTING:	20"X10" CONT. KEYED FTNG
25	CONC. PAD:	30"X30"X15" CONC. PAD

NOTES: -ISOTHENE ALL RIM JOISTS (OPTIONAL)
-ICE & WATER SHEILD 6'-0" UP FROM DRIP EDGE
& 3'-0" WIDE UP VALLEYS
-SIMPSON H2.5A CLIPS TYP ALL RAFTERS

TABLE 402.1.2
INSULATION AND FENESTRATION REQUIREMENTS BY COMPONENT

CLIMATE ZONE	FENESTRATION U-FACTOR ^b	SKYLIGHT ^b U-FACTOR	GLAZED FENESTRATION SHGC _{b,e}	CEILING R-VALUE	WOOD FRAME WALL R-VALUE	MASS WALL R-VALUE ⁱ	FLOOR R-VALUE	BASEMENT ^c WALL R-VALUE	SLAB ^d R-VALUE & DEPTH	CRAWL SPACE WALL R-VALU
5 and Marine 4	0.30	0.55	NR	49	20 or 13+5 ^h	13/17	30g	15/19	10, 2 ft	15/19

2018 INTERNATIONAL ENERGY CONSERVATION CODE® AND MASSACHUSETTES 780 CMR 9TH EDITION


For SI: 1 foot = 304.8

- For SI: 1 foot = 304.8 mm.


 - a. R-values are minimums. U-factors and SHGC are maximums. R-19 batts compressed into a nominal 2 x 6 framing cavity such that the R-value is reduced by R-1 or more shall be marked with the compressed batt R-value in addition to the full thickness R-value.
 - b. The fenestration U-factor column excludes skylights. The SHGC column applies to all glazed fenestration.
 - c. "15/19" means R-15 continuous insulated sheathing on the interior or exterior of the home or R-19 cavity insulation at the interior of the basement wall. "15/19" shall be permitted to be met with R-13 cavity insulation on the interior of the basement wall plus R-5 continuous insulated sheathing on the interior or exterior of the home. "10/13" means R-10 continuous insulated sheathing on the interior or exterior of the home or R-13 cavity insulation at the interior of the basement wall.
 - d. R-5 shall be added to the required slab edge R-values for heated slabs. Insulation depth shall be the depth of the footing or 2 feet, whichever is less in Zones 1 through 3 for heated slabs.
 - e. There are no SHGC requirements in the Marine Zone.
 - f. Basement wall insulation is not required in warm-humid locations as defined by Figure 301.1 and Table 301.1.
 - g. Or insulation sufficient to fill the framing cavity, R-19 minimum.
 - h. "13+5" means R-13 cavity insulation plus R-5 insulated sheathing. If structural sheathing covers 25 percent or less of the exterior, insulating sheathing is not required where structural sheathing is used. If structural sheathing covers more than 25 percent of exterior, structural sheathing shall be supplemented with insulated sheathing of at least R-2.
 - i. The second R-value applies when more than half the insulation is on the interior of the mass wall.
 - j. For impact rated fenestration complying with Section R301.2.1.2 of the *International Residential Code* or Section 1608.1.2 of the *International Building Code*, the maximum U-factor shall be 0.75 in Zone 2 and 0.65 in Zone 3.

DESIGN CRITERIA

DESIGN CRITERIA											
GROUND SNOW LOAD	WIND SPEED (MPH)	SEISMIC DESIGN	WEATHERING	FROST LINE DEPTH	TERMITE	DECAY	WINTER DESIGN TEMP	ICE SHIELD UNDERLAYMENT REQUIRED	FLOOD HAZARD	AIR FREEZING INDEX	MEAN ANNUAL TEMP
TABLE 5301.2(5)	TABLE 5301.2.(4)	N/A	FIGURE 5301.2(3)	4 ft. minimum unless engineered data shows otherwise	FIGURE 5301.2(6)	FIGURE 5301.2(7)	APPENDIX 780 CMR 120.J TABLE 120.J.3.2.1	As required by the exterior roof covering manufacturer; roof pitch and local climate must also be considered	Refer to applicable Flood Insurance Rate Map (FIRM)	Only utilized in the design and construction of frost protected shallow foundations	Only utilized in the design and construction of frost protected shallow foundations
50 psf	124 mph	N/A	SEVERE	§5403.1.4	MODERATE TO HEAVY	SLIGHT TO MODERATE	N/A	§5905.0	FIRM MAPS	SEE NOTE J TABLE 5301.2(1)	SEE NOTE K TABLE 5301.2(1)

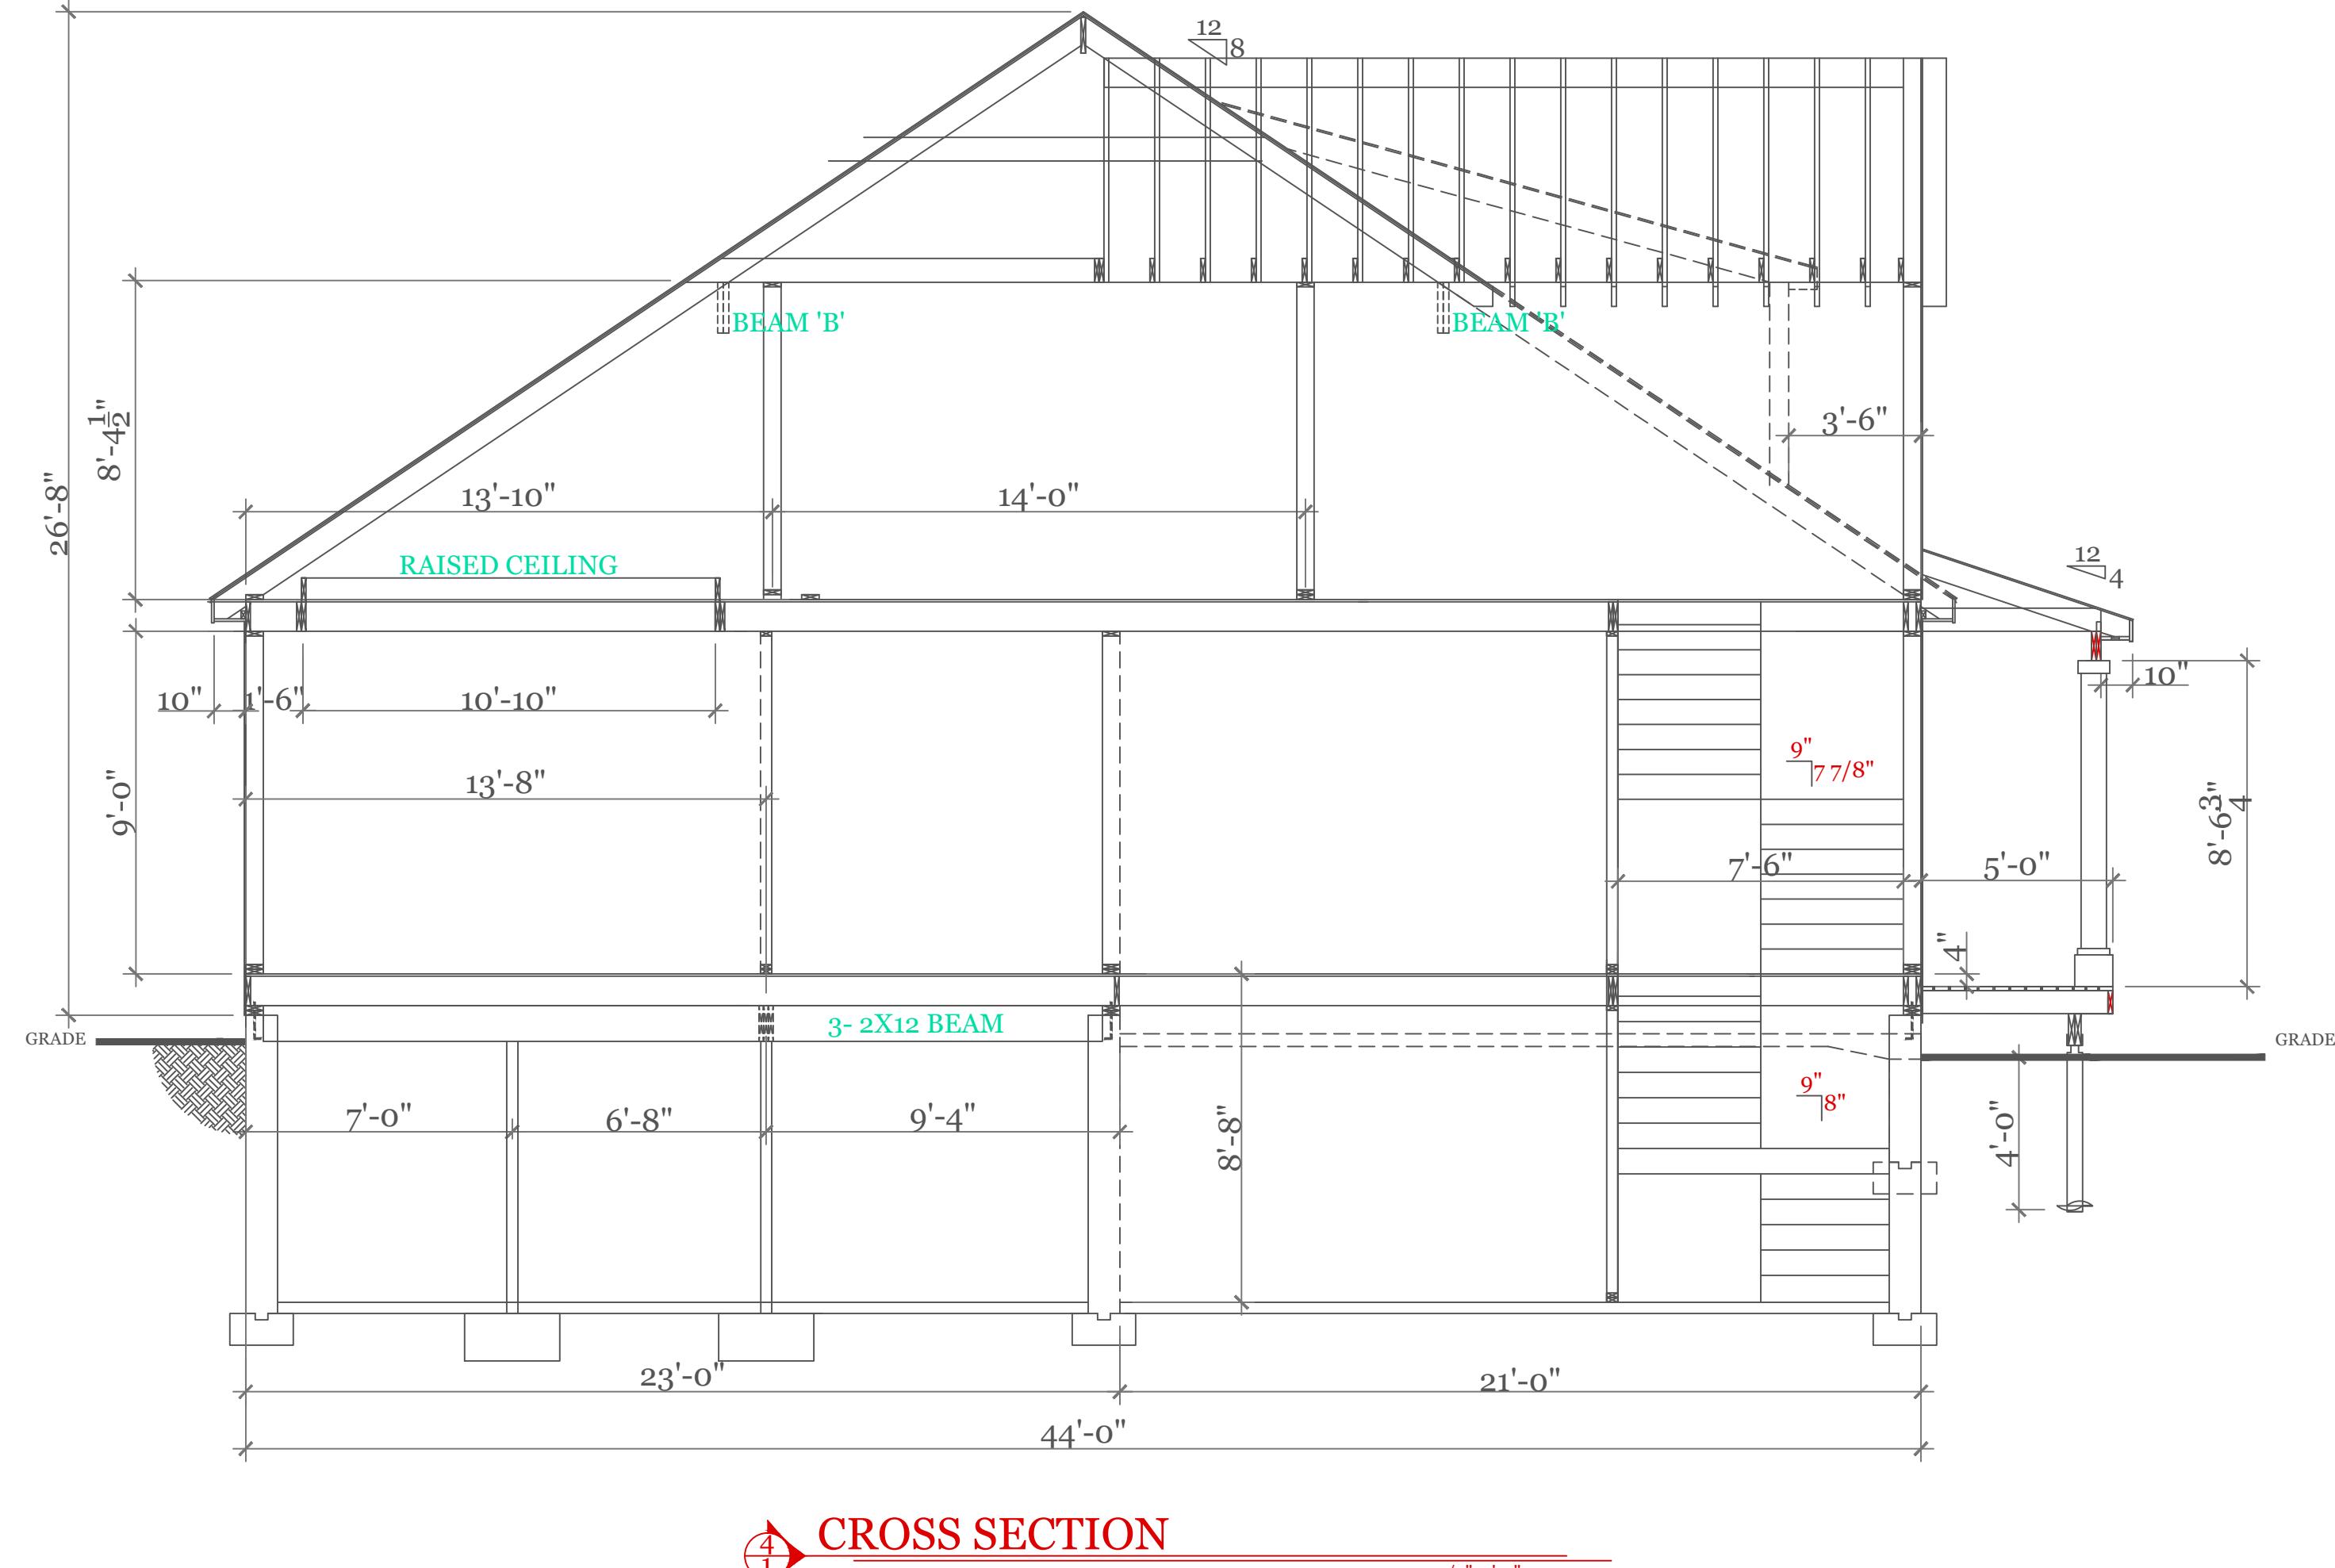

CROSS SECTION

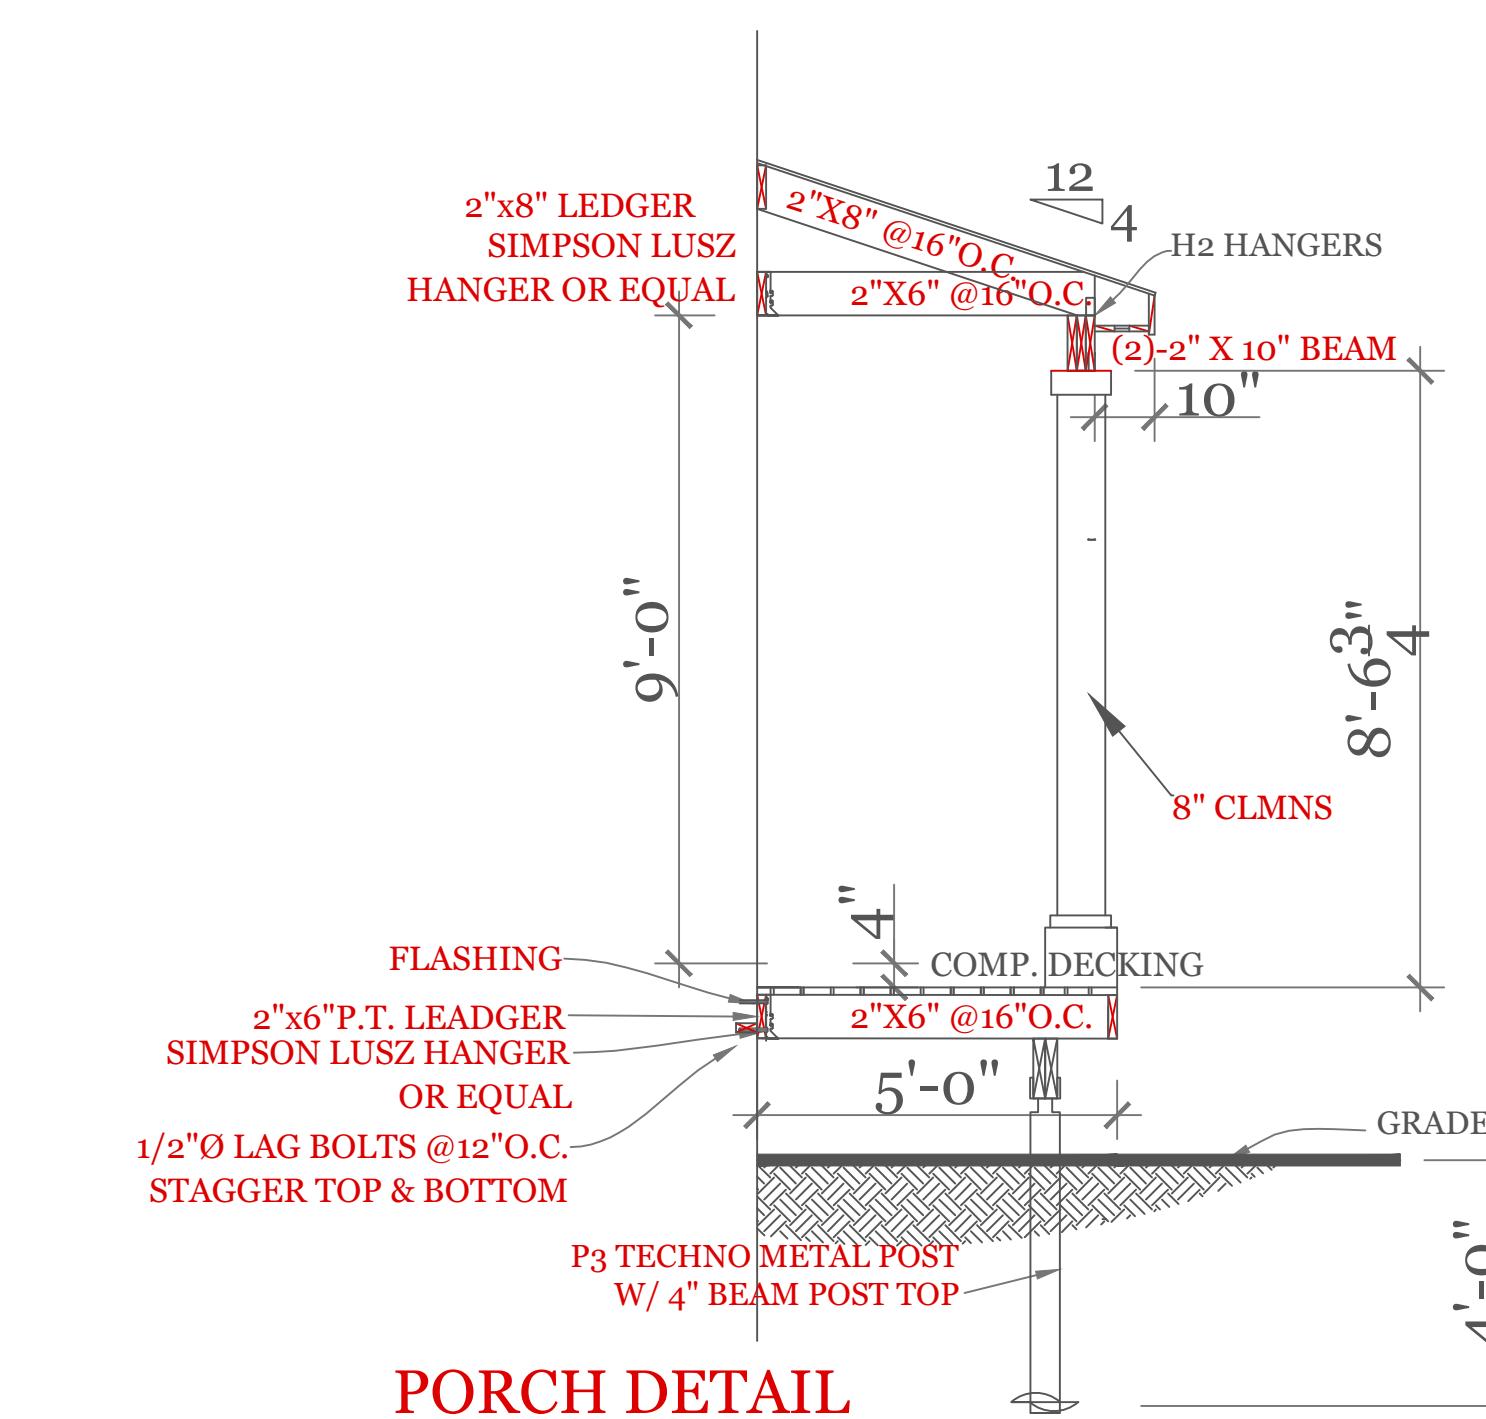

PORCH DETAIL

NOTES:

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Phone No. 17 Glenwood
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UNIT 'C' 1734 S.F.
HIGGINS FAM AT
SALISBURY HILL

BUILDING SECTION
CODE CRITERIA
CONSTR. SCHEDULE

UNIT 'C' GR

DATE: 9/28/2022 R5/5/23

SCALE: AS NOTED

DRAWN BY: RCS

CHECKED BY: MJB

Sheet 4 OF 5

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UNIT 'C' 1734 S.F.
HIGGINS FARM AT
SALISBURY GREEN
FRAMING PLANS
BEAM CALCS

UNIT 'C' GR

DATE: 9/28/2022 R5/5/23
SCALE: 3/16" = 1'-0"
DRAWN BY: RCS
CHECKED BY: MJB

Sheet 5 OF 5

5

BEAM CALCULATIONS

BEAM	SIZE	SPAN	LIVE LOAD	TOTAL LOAD	MAX LIVE (PLF)	MAX TOTAL (PLF)
A	5 1/4" X 14" LVL	21'-6"	240	382	334	482
B	5 1/4"X 18" LVL ROOF	21'-6"	---	840	---	1050

